HAMILTON COURTS 1220-1236 31ST STREET, NW WASHINGTON, DC

BUILDING ENVELOPE REHABILITATIONS

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November 22, 2021
PROJECT TITLE AND LOCATION:
BUILDING ENVELOPE REHABILITATIONS
HAMILTON COURTS 1220-1236 31ST
STREET, NW Washington, DC
CSG PROJECT #: DRAWN BY: 16-114 MTC
DATE: APPROVED BY: 02-01-2021 RMRJ
SCALE: NOT TO SCALE
REVISIONS :DATEDESCRIPTION
DRAWING TITLE:
COVER SHEET
001

PROJECT INFORMATION/SCOPE OF WORK:

PROJECT HISTORY:

ROOF REPAIRS -- REPLACE MODIFIED BITUMEN FLASHINGS AT CHIMNEY WITH NEW AND INSTALLATION OF NEW REGLET-MOUNTED HAMILTON COURTS IS A GROUPING OF SEVERAL BUILDINGS LOCATED AT 1220, 1222, 1226, 1228, 1228–1/2, 1230, 1234, 1236 (1220–1236) COUNTERFLASHING. 31ST STREET NW, WASHINGTON, DC 20007. IT UNDERWENT A BUILDING ENVELOPE SURVEY IN AUGUST/SEPTEMBER OF 2015 DURING WHICH -- REPAIR MODIFIED BITUMEN AT THE FIRE ESCAPE SECUREMENT POINTS. FLASH THE RAILINGS AND SUPPORTS INTO THE NUMEROUS AREAS OF WATER INFILTRATION WERE OBSERVED ENTERING THE BUILDINGS. THE SCOPE OF WORK IS LISTED UNDER ITEM II AND DOES MODIFIED BITUMEN WITH SIPLAST PARAPRO AND THE ASSOCIATED PRIMERS AND REINFORCING FABRIC. NOT INTEND TO CHANGE THE GENERAL AESTHETIC APPEARANCE OF THE BUILDINGS. IT SHOULD BE NOTED THAT THE FIRE RESISTANCE OF THE NEW ROOF—RELATED MASONRY MATERIALS WILL NOT DIFFER FROM THOSE CURRENTLY EXISTING ON THE BUILDING. PHASE 1 WAS COMPLETED IN 2017-2018, PHASE 2 WAS COMPLETED IN 2018-2019, AND PHASE 3 WAS COMPLETED IN 2020-2021. THIS BUILDING PERMIT SHALL ONLY APPLY TO PHASE 4, LISTED -- REBUILD THE TWO (2) ROTATED CHIMNEYS ON THE SOUTH ELEVATION OF THE BUILDING. -- PRIME AND PAINT MASONRY ABOVE ROOFLINE TO MATCH FACADE COLOR. MASONRY PAINT-BASF MASTERPROTECT 400. UNDER ITEM II. NO EGRESS PATHS EXITING THE BUILDING SHALL BE BLOCKED AT ANYTIME DURING THIS PROJECT. PLEASE REFER TO THE ATTACHED PROJECT MANUAL DATED AUGUST 15, 2016 AND THE ADDENDA #1 DATED NOVEMBER 21, 2016, ADDENDA #2 DATED FEBRUARY 24, 2017, III. LIFE SAFETY AND CODE ANALYSIS: ADDENDA #3 DATED MARCH 13, 2017, AND ADDENDA #4 DATED MAY 3, 2017, FOR MORE DETAILED INFORMATION. A. <u>BUILDING 1236</u> USE GROUP: R2 (RESIDENTIAL) TYPE OF CONSTRUCTION: VB A. OBTAIN ALL NECESSARY PERMITS AND REGULATORY AGENCY (DCRA, FINE ARTS COMMISSION, ETC.) APPROVALS PRIOR TO STARTING ANY FULLY SPRINKLERED: NO REQUIRED WORK. NUMBER OF STORIES: 3 ABOVE GRADE, 1 BELOW GRADE 4 COORDINATING CLOSURE OF WORK, STAGING AND CRANE OPERATION AREAS WITH THE PROPERTY MANAGER'S ON-SITE REPRESENTATIVE. FIRE RATED ASSEMBLY: (PER IBC TABLE 601 & 602) INSTALLING SAFETY PROTECTIVE PROVISIONS TO ISOLATE WORK AREAS AND PROTECT VEHICLES, PEDESTRIANS, TENANTS, SIDEWALK AREAS, STRUCTURAL FRAMING: 0 HOURS REQUIRED, EXISTING TO REMAIN ENTRANCES AND INTERIOR/EXTERIOR BUILDING COMPONENTS FROM THE WORK. THIS IS TO INCLUDE OVERHEAD PROTECTION (SCAFFOLDING) EXTERIOR BEARING WALLS: O HOURS REQUIRED, EXISTING TO REMAIN AT THE FRONT AND REAR ENTRANCE IF REQUIRED. - INTERIOR BEARING WALLS: 0 HOURS REQUIRED, EXISTING TO REMAIN PERFORMING AN INTERIOR CONDITION SURVEY OF TOP FLOOR UNITS AND EXTERIOR BUILDING COMPONENTS. PROVIDE WRITTEN D. NON BEARING PARTITIONS (INTERIORS): O HOURS REQUIRED, EXISTING TO REMAIN DOCUMENTATION TO OWNER AND CONSULTANT FOR REVIEW PRIOR TO STARTING WORK. SURVEY SHEET SHALL INCLUDE DOCUMENTATION OF - FLOOR/CEILING CONSTRUCTION: O HOURS REQUIRED. EXISTING TO REMAIN ANY EXISTING DAMAGED BUILDING COMPONENTS, MECHANICAL EQUIPMENT OR ANY OTHER CONCERNS THAT MAY AFFECT THE INTEGRITY OF THE - ROOF/CEILING CONSTRUCTION: 0 HOURS REQUIRED. EXISTING TO REMAIN WORK AND/OR BUILDING. ALL WORK MUST BE COORDINATED WITH THE PROPERTY MANAGER. BUILDING LOCATED IN A HISTORIC DISTRICT WITHIN THE DISTRICT OF COLUMBIA PHASING SHALL BE PERFORMED IN THE FOLLOWING YEARS: 7. APPLICABLE BUILDING CODES: - PHASE 1 = 2017 - 2015 INTERNATIONAL BUILDING CODE - PHASE 2 = 2018-2019 2017 DISTRICT OF COLUMBIA BUILDING CODE - PHASE 3 = 2020-2021 2017 DISTRICT OF COLUMBIA EXISTING BUILDING CODE - PHASE 4 = 2021 2017 DISTRICT OF COLUMBIA ENERGY CONSERVATION CODE PHASE 4 SHALL INCLUDE, BUT IS NOT LIMITED TO. THE FOLLOWING: 8. BUILDING SQUARE FEET WILL NOT CHANGE 1. <u>BUILDING 1220-1226</u> <u>BUILDING 1234</u> В. METAL ROOF REHABILITATION USE GROUP: B (BUSINESS) -- SELECTIVE REPAIRS TO THE METAL ROOF, AT THE DIRECTION OF THE CONSULTANT. TYPE OF CONSTRUCTION: IIIB -- REPLACEMENT OF DAMAGED AND MISSING METAL SNOW GUARDS, PER ALLOWANCES. FULLY SPRINKLERED: NO -- CLEAN, SCOUR, AND PAINT THE METAL ROOFS WITH TWO (2) COATS OF APPROVED DIRECT-TO-METAL (DTM) PAINT IN A COLOR NUMBER OF STORIES: 3 SELECTED BY THE OWNER. FIRE RATED ASSEMBLY: (PER IBC TABLE 601 & 602) - FACADE REHABILITATION STRUCTURAL FRAMING: 0 HOURS REQUIRED, EXISTING TO REMAIN -- REMOVAL AND REPLACEMENT OF THE FOUR (4) WOOD JULIETTE BALCONIES/DOORS ON THE WEST ELEVATION OF BUILDING EXTERIOR BEARING WALLS: 2 HOURS REQUIRED, EXISTING TO REMAIN 1226. REPLACEMENT SHALL INCLUDE INSTALLATION OF A SELF-ADHERED WEATHER BARRIER (HENRY BLUESKIN) PERIMETER – INTERIOR BEARING WALLS: O HOURS REQUIRED, EXISTING TO REMAIN FLASHINGS AT EACH BALCONY. INSTALL NEW TRIM PIECES AS REQUIRED, PRIMED AND PAINTED TO MATCH EXISTING. THE - NON BEARING PARTITIONS (INTERIORS): O HOURS REQUIRED, EXISTING TO REMAIN EXISTING RAILINGS ARE TO BE SALVAGE, CLEANED, SCOURED, PRIMED, AND PAINTED WITH A RUST INHIBITING COATING PRIOR - FLOOR/CEILING CONSTRUCTION: 0 HOURS REQUIRED, EXISTING TO REMAIN TO REINSTALLATION. THE JULIETTE BALCONY DOORS ARE TO BE REPLACED IN KIND AND MUST BE APPROVED BY THE OWNER - ROOF/CEILING CONSTRUCTION: O HOURS REQUIRED, EXISTING TO REMAIN AND DC FINE ARTS COMMISSION. BALCONY DOORS ARE TO BE PRIMED AND PAINTED IN TWO (2) COATS OF EXTERIOR GRADE BUILDING LOCATED IN A HISTORIC DISTRICT WITHIN THE DISTRICT OF COLUMBIA PAINT IN AN OWNER APPROVED COLOR(S) 7. APPLICABLE BUILDING CODES: a. WINDOW, DOOR AND JULIETTE BALCONY DOOR MANUFACTURER - JELD WEN, MARVIN, OR APPROVED EQUAL 2015 INTERNATIONAL BUILDING CODE PRODUCT LINE - SITELINE WOOD AURALAST PINE, ULTIMATE WOOD, OR APPROVED EQUAL 2017 DISTRICT OF COLUMBIA BUILDING CODE c. FENESTRATIONS SHALL HAVE A MAXIMUM U-FACTOR OF 0.38 FOR FIXED FENESTRATIONS, AND 0.45 FOR OPERABLE 2017 DISTRICT OF COLUMBIA EXISTING BUILDING CODE FENESTRATIONS, AND A MAXIMUM SHGC OF 0.40. - 2017 DISTRICT OF COLUMBIA ENERGY CONSERVATION CODE -- REMOVE AND REPLACE THE WOOD; DOUBLE HUNG, HALF ROUND, FIXED, AND CASEMENT WINDOWS ON THE EXTERIOR OF THIS BUILDING SQUARE FEET WILL NOT CHANGE BUILDING GROUP. REPLACEMENT IN KIND TO MATCH EXISTING MATERIALS AND DESIGN. REPLACEMENT WINDOWS ARE TO BE <u>BUILDING 1228</u> APPROVED BY THE OWNER AND THE DC FINE ARTS COMMISSION. REPLACEMENT WINDOWS TO BE PRIMED AND PAINTED IN 1. USE GROUP: B (BUSINESS) AND R2 (RESIDENTIAL) TWO (2) COATS OF EXTERIOR GRADE PAINT IN AN OWNER APPROVED COLOR(S). TYPE OF CONSTRUCTION: IIIB a. MANUFACTURER – JELD WEN, MARVIN, OR APPROVED EQUAL 3. FULLY SPRINKLERED: NO b. PRODUCT LINE - SITELINE WOOD AURALAST PINE, ULTIMATE WOOD, OR APPROVED EQUAL 4. NUMBER OF STORIES: 3 c. FENESTRATIONS SHALL HAVE A MAXIMUM U-FACTOR OF 0.38 FOR FIXED FENESTRATIONS, AND 0.45 FOR OPERABLE 5. FIRE RATED ASSEMBLY: (PER IBC TABLE 601 & 602) FENESTRATIONS. AND A MAXIMUM SHGC OF 0.40. – STRUCTURAL FRAMING: O HOURS REQUIRED, EXISTING TO REMAIN -- SELECTIVE REMOVAL AND REPLACEMENT OF DETERIORATED SIDING ALONG THE NORTH, EAST, AND WEST ELEVATIONS OF THE - EXTERIOR BEARING WALLS: 2 HOURS REQUIRED, EXISTING TO REMAIN BUILDING. - INTERIOR BEARING WALLS: O HOURS REQUIRED, EXISTING TO REMAIN -- REMOVE LOOSE AND PEELING PAINT FROM THE SIDING AND POWER WASH TO REMOVE CONTAMINANTS PRIOR TO APPLICATION - NON BEARING PARTITIONS (INTERIORS): O HOURS REQUIRED, EXISTING TO REMAIN OF TWO (2) COATS OF EXTERIOR GRADE PAINT, OWNER TO SELECT COLOR(S). -- REPLACEMENT OF BUILDING SEALANTS INCLUDING AROUND DOORS, WINDOWS, PENETRATIONS, DISSIMILAR MATERIALS, ETC. - FLOOR/CEILING CONSTRUCTION: O HOURS REQUIRED, EXISTING TO REMAIN -- SELECTIVE TUCKPOINTING AND BRICK REPLACEMENT. AT THE DIRECTION OF THE CONSULTANT – ROOF/CEILING CONSTRUCTION: O HOURS REQUIRED, EXISTING TO REMAIN 2. <u>BUILDING 1228</u> BUILDING LOCATED IN A HISTORIC DISTRICT WITHIN THE DISTRICT OF COLUMBIA FACADE REHABILITATION 7. APPLICABLE BUILDING CODES: -- SELECTIVE TUCKPOINTING AND BRICK REPLACEMENT, AT THE DIRECTION OF THE CONSULTANT. - 2015 INTERNATIONAL BUILDING CODE -- REMOVAL AND REPLACEMENT OF BUILDING SEALANTS - 2017 DISTRICT OF COLUMBIA BUILDING CODE 3. <u>BUILDING 1234</u> 2017 DISTRICT OF COLUMBIA EXISTING BUILDING CODE - FACADE REHABILITATION 2017 DISTRICT OF COLUMBIA ENERGY CONSERVATION CODE -- SELECTIVE TUCKPOINTING AND BRICK REPLACEMENT, AT THE DIRECTION OF THE CONSULTANT. BUILDING SQUARE FEET WILL NOT CHANGE -- REMOVAL AND REPLACEMENT OF BUILDING SEALANTS. BUILDING 1220-1226 D. -- REMOVAL AND REPLACEMENT OF THE SEALANTS ON THE GROUND FLOOR GLASS SHED ROOF AND THE INSTALLATION OF USE GROUP: B (BUSINESS) THROUGHWALL FLASHING ABOVE THE SHED ROOF INTERSECTION(S) WITH THE BRICK FACADE. TYPE OF CONSTRUCTION: VB -- REMOVE AND REINSTALL/REPLACE EXISTING CHAIN LINK FENCING, AS REQUIRED, FOR ACCESS. FULLY SPRINKLERED: NO 3. - METAL ROOF REHABILITATION NUMBER OF STORIES: 3 4. -- REPLACE DAMAGED SNOW GUARDS AT THE DIRECTION OF THE CONSULTANT. 5. FIRE RATED ASSEMBLY: (PER IBC TABLE 601 & 602) -- CLEAN, SCOUR, AND PAINT THE METAL ROOFS WITH TWO (2) COATS OF APPROVED DIRECT-TO-METAL PAINT IN A COLOR – STRUCTURAL FRAMING: O HOURS REQUIRED, EXISTING TO REMAIN - EXTERIOR BEARING WALLS: SELECTED BY THE OWNER. 0 HOURS REQUIRED, EXISTING TO REMAIN - METAL ROOF-RELATED MASONRY - INTERIOR BEARING WALLS: O HOURS REQUIRED, EXISTING TO REMAIN -- SELECTIVE TUCKPOINTING AND BRICK REPLACEMENT ON TUCKPOINTING ABOVE ROOFLINE, AT THE DIRECTION OF THE - NON BEARING PARTITIONS (INTERIORS): O HOURS REQUIRED, EXISTING TO REMAIN CONSULTANT. – FLOOR/CEILING CONSTRUCTION: 0 HOURS REQUIRED, EXISTING TO REMAIN -- APPLICATION OF CLEAR PENETRATING SEALER ON BRICK MASONRY ABOVE METAL ROOF (CHIMNEYS, SIDEWALLS, ETC.). – ROOF/CEILING CONSTRUCTION: O HOURS REQUIRED, EXISTING TO REMAIN -- REPLACEMENT OF BUILDING SEALANTS. BUILDING LOCATED IN A HISTORIC DISTRICT WITHIN THE DISTRICT OF COLUMBIA 4. <u>BUILDING 1236</u> APPLICABLE BUILDING CODES: FACADE REHABILITATION 2015 INTERNATIONAL BUILDING CODE -- SELECTIVE TUCKPOINTING AND MASONRY REPLACEMENT, AT THE DIRECTION OF THE CONSULTANT. 2017 DISTRICT OF COLUMBIA BUILDING CODE -- FACADE SEALANT REPLACEMENT 2017 DISTRICT OF COLUMBIA EXISTING BUILDING CODE -- REMOVAL OF EXISTING LOOSE AND PEELING PAINT, PRESSURE WASHING, PRIMING, AND APPLICATION OF TWO COATS OF PAINT – 2017 DISTRICT OF COLUMBIA ENERGY CONSERVATION CODE TO THE BRICK, WINDOWS, DOORS, TRIM, ETC, COLOR(S) TO BE APPROVED BY THE OWNER. 8. BUILDING SQUARE FEET WILL NOT CHANGE a. MASONRY PAINT - BASF MASTERPROTECT 400


- II. SCOPE OF WORK:

 - - - b. TRIM/WINDOWS/DOOR PAINT SHERWIN WILLIAMS RESILIENCE.
 - BASEMENT WATERPROOFING REHABILITATION -- ON EAST AND NORTH ELEVATIONS OF THE BUILDING, REMOVE AND REPLACE THE SIDEWALKS, STAIRS, RETAINING WALLS, ETC. TO REHABILITATE THE BELOW GRADE WATERPROOFING. REMOVAL OF EXISTING DAMPPROOFING BY SANDBLASTING AND THE APPLICATION OF A HYDRAULIC CEMENT PARGING COAT TO CREATE A CONTINUOUS SURFACE.
 - -- APPLICATION OF AQUAFIN 1K AND 2K/M IN OWNER SELECTED COLOR(S). -- RESTORATION OF EXISTING SIDEWALK, STAIRS, ETC. TO MATCH EXISTING CONDITIONS.
 - -- EXTENT OF WORK AREAS SHALL BE THE OUTSIDE CORNER AT SOUTHEAST CORNER OF THE BUILDING TO THE STAIRS/CHIMNEY ON THE NORTH ELEVATION OF THE BUILDING.
 - -- AQUAFIN SHALL BE APPLIED FROM THE FOOTER UP TO THE TERMINATION OF THE EXISTING PARGING AND TRANSITION TO BRICK (SEVERAL FEET ABOVE THE LEVEL OF THE SIDEWALK).
 - -- INSTALL REGLET-MOUNTED COUNTERFLASHING TO COVER THE TERMINATION OF THE MEMBRANE.


CORPORATE OFFICE: CORPORATE OFFICE: 1451 DOLLEY MADISON BLVD., SUITE 300 MCLEAN, VIRGINIA 22101 MARYLAND OFFICE: 8821 ENDLESS OCEAN WAY COLUMBIA, MARYLAND 21045 TEL: 703–917–0464 KEB ADDRESS: WWW.CSGENGINEER.COM
STAMP:
NO. PE 10610 NO. PE 100 NO. PE 100 NO
PROJECT TITLE AND LOCATION:
BUILDING ENVELOPE REHABILITATIONS HAMILTON COURTS 1220–1236 31ST STREET, NW WASHINGTON, DC
CSG PROJECT #: DRAWN BY:
16-114MTCDATE:APPROVED BY:
02-01-2021 RMRJ SCALE:
NOT TO SCALE REVISIONS: DATE DESCRIPTION
DRAWING TITLE: PROJECT INFORMATION/ SCOPE OF WORK/CODE ANALYSIS
SHEET NUMBER:
002

- 1. CONTRACTOR TO VERIFY FIELD CONDITIONS AND DIMENSIONS.
- VICINITY PLAN AS DEPICTED BELOW IS FROM GOOGLE MAPS®.
 LABELED BUILDINGS INCLUDED IN PHASE 4.



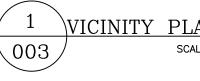

VICINITY PLAN – PHASE 4 SCALE: N.T.S.

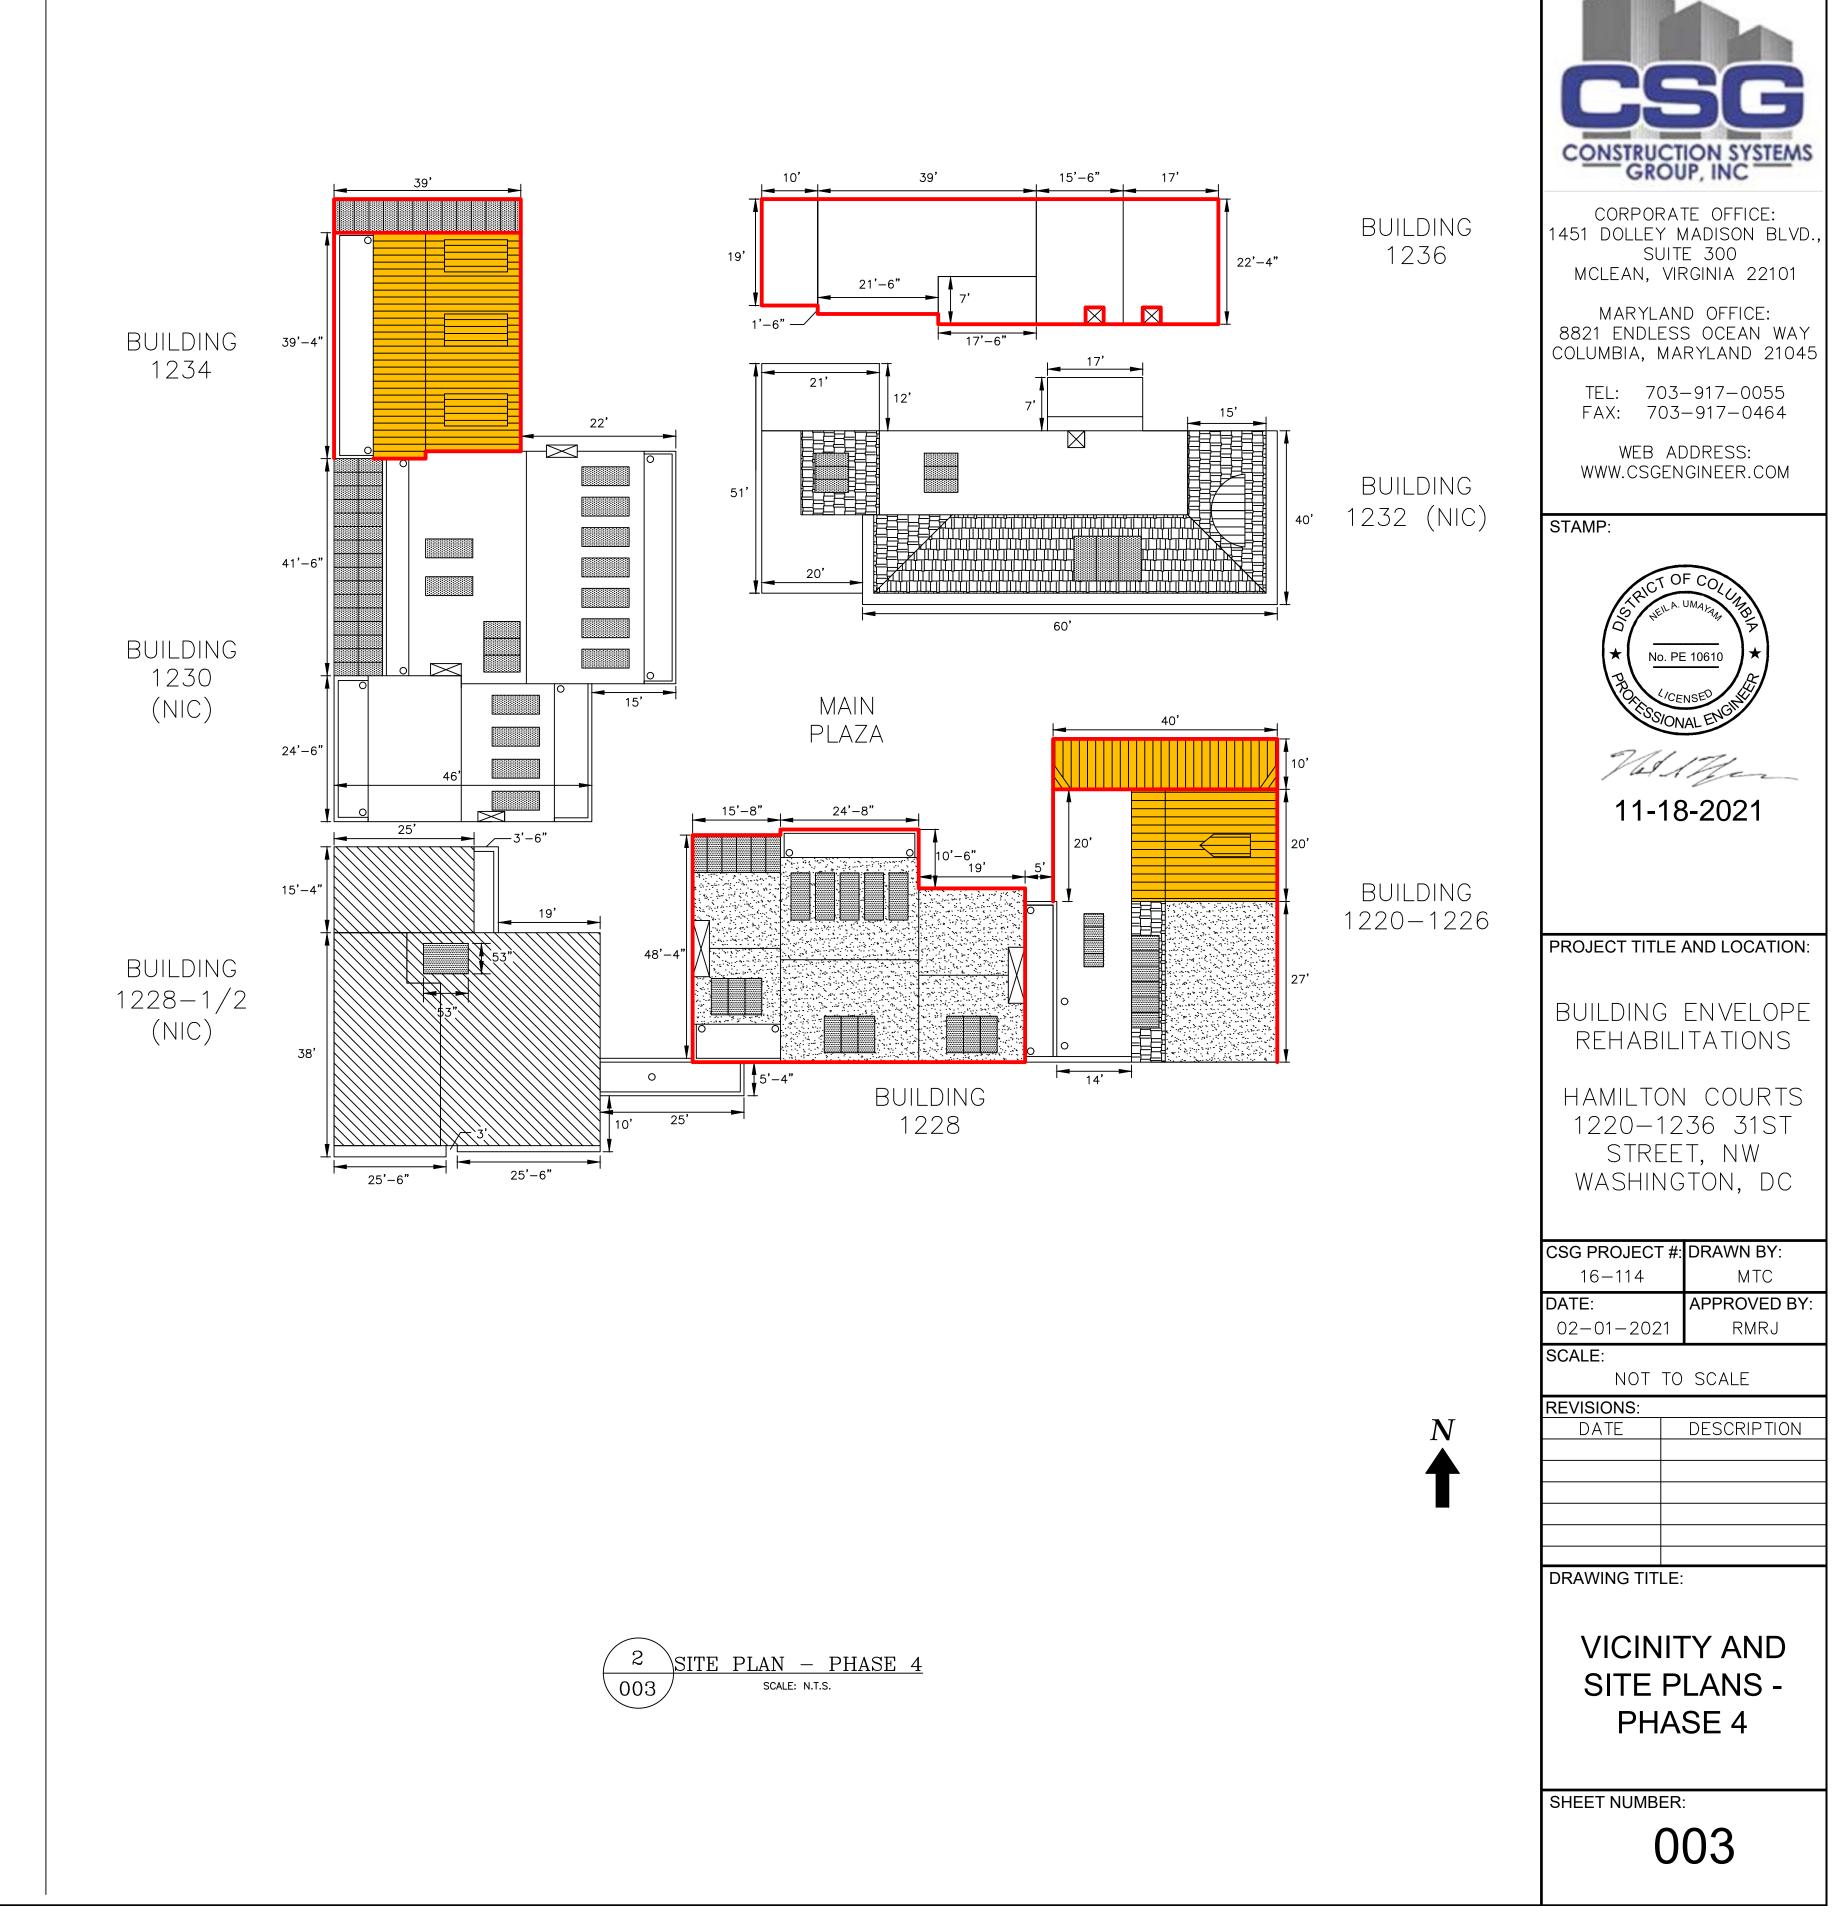

- 2. HIGHLIGHTED SECTIONS REFER TO WORK TO BE PERFORMED IN PHASE 4. 3. NIC REFERS TO BUILDINGS TO BUILDINGS THAT ARE A PART OF HAMILTON COURT BUT NOT IN CONTRACT TO RECEIVE WORK DURING PHASE 4.
- 1. CONTRACTOR TO VERIFY FIELD CONDITIONS AND DIMENSIONS.

NOTES:


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EAST ELEVATION



SOUTH ELEVATION



NOTE: CONTRACTOR TO VERIFY FIELD CONDITIONS AND DIMENSIONS.

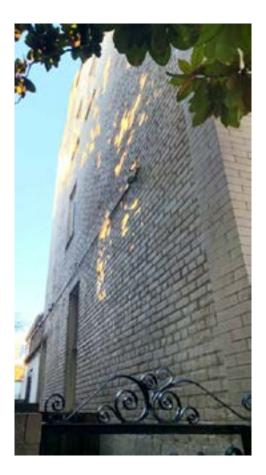





WEST ELEVATION

NORTH ELEVATION

NOTE: CONTRACTOR TO VERIFY FIELD CONDITIONS AND DIMENSIONS.



WEST ELEVATION





EAST ELEVATION

WEST ELEVATION




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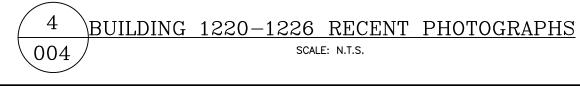








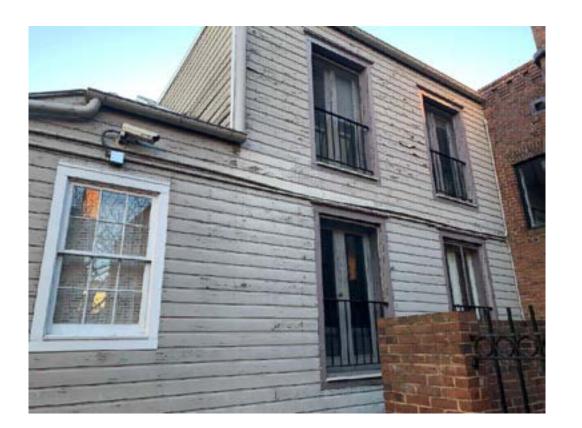





SOUTH ELEVATION



EAST ELEVATION







NORTH ELEVATION

CONSTRUCTION SYSTEMS GROUP, INC


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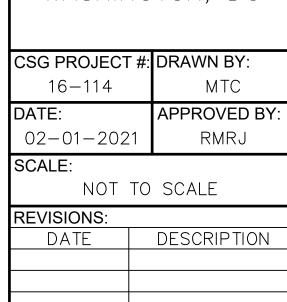
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PROJECT TITLE AND LOCATION:

BUILDING ENVELOPE REHABILITATIONS

HAMILTON COURTS 1220–1236 31ST STREET, NW WASHINGTON, DC



DRAWING TITLE: BUILDINGS 1230, 1234, 1228, 1220-1226 RECENT PHOTOGRAPHS

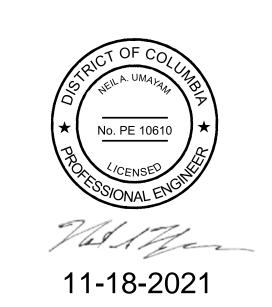SHEET NUMBER:

004

Hamilton Court

PHASE 4: BUILDING ITEM INVENTORY

#	Description	Current Condition/Materials	Recent Existing Condition Photo	Overview
1	Building 1236: Facades	 The majority of exterior walls consists of painted brick masonry. The paint is delaminating and there are cracked brick and deteriorated mortar joints. Sealants (i.e., caulking around windows/doors) are failing in cohesion. The paint is flaking on the windows, doors, and trim. 		 Aesthetic appearance for the contractor of the new may please see details on a Façade sealant replate color but be silicone. Repainting brick we approved color to may approved color to may approve color to may approve the color of the contractor of the contractor
2	Building 1236: Below Grade Waterproofing	 Waterproofing has failed on the north and east elevations of the structure at the basement level. This is allowing for water infiltration into the basement unit. 	The ship of the second second second	 Aesthetic appearance f Extent of work areas of the building to the building (See Sheet . On east and north ele brick pavers, concret below grade waterpression of existing application of a hydre continuous surface selected color(s). Action termination of the existing conditions.

Hamilton Court

PHASE 4: BUILDING ITEM INVENTORY

#	Description	Current Condition/Materials	Recent Existing Condition Photo	Overview of Prop
3	Building 1236: Flat Roofs	 Existing modified bitumen roof is in serviceable condition, but the flashings at the chimney and fire escape securement points are deteriorated. 		Aesthetic appearance • Replace flashings the chimney.
4	Building 1236: Chimneys	 The two chimneys on the south elevation are rotating above the roofline. Please see Sheet A008 for more photos/information. 		 Aesthetic appearance Rebuild the mason the roof membra reinstallation with please see sheet A0 Paint with BASF N to match brick faça
5	Building 1228: Facades	 Exterior facades consist of unpainted brick masonry. There are select deteriorated mortar joints and cracked brick. Sealants (i.e., caulking around windows/doors) are failing in cohesion. 		 Aesthetic appearance Selective tuckpoin Once the contract joints and brick w Record. The m Cement/Lime/Sand Façade sealant/cau existing color but b

iew of Proposed Scope of Work ce from the Exterior will not change

nting and brick replacement on an allowance basis. ctor accesses the facades, the deteriorated mortar will be marked for replacement by the Engineer of mortar shall be Type N Portland Cement and Lime. on A004.

placement. The new sealant shall match the existing ne based (i.e., Dow Coming 795). with BASF MasterProtect 400 coating in owner

match existing. indows, doors, and trim with Sherwin Williams ner approved colors.

e from the Exterior will not change

eas shall be the outside corner at southeast corner the stairs/chimney on the north elevation of the et A005 for more info).

elevations of the building, remove and replace the crete slabs, retaining walls, etc. to rehabilitate the

rproofing.

ing damp-proofing by sandblasting and the hydraulic cement parging coat to create a ce. Application of Aquafin 1k and 2k/m in owner

Aquafin shall be applied from the footer up to the

existing parging. sting concrete, pavers, etc. to match existing

Hamilton Court

PHASE 4: BUILDING ITEM INVENTORY

#	Description	Current Condition/Materials	Recent Existing Cond
6	Building 1234: Facades	 Exterior facades consist of unpainted brick masonry. There are select deteriorated mortar joints and cracked brick. Sealants (i.e., caulking around windows/doors) are failing in cohesion. 	
7	Building 1234: Glass Shed Roof	 Existing glass panel shed roof located on the north elevation of the building on the ground floor. Gaskets/wet glazing are at the end of their service life. Wall flashings missing at headwall above the glass shed roof. 	15 1
8	Building 1234: Metal Roof	 Existing standing seam metal roof is in satisfactory condition, but the paint is peeling. There are missing snow guards. 	

posed Scope of Work

nce from the Exterior will not change

igs for the fire escape securement points and around

nce from the Exterior will not change

onry on the two chimneys above the intersection with abrane. Existing masonry shall be salvaged for ith new mortar (Type N Portland Cement/Lime/Sand) t A008 for more information.

F MasterProtect 400 coating in owner approved color açade below.

nce from the Exterior will not change


ointing and brick replacement on an allowance basis. actor accesses the facades, the deteriorated mortar will be marked for replacement by the Engineer of new mortar shall be Type N Portland Sand. Please see details on A004.

caulking replacement. The new sealant shall match the out be silicone based (i.e., Dow Corning 795).


Hamilton Court


PHASE 4: BUILDING ITEM INVENTORY

#	Description	•	Current Condition/Materials	Recent Existing Condition Photo	Overview of Proposed Scope of Work
9	Building 1220- 1226: Windows and Balcony Doors	•	The existing wood windows (operable and inoperable) and Juliette balcony doors in a deteriorated and rotted condition (See A007 for more photographs) Sealants (i.e., caulking around windows/doors) are failing in cohesion.		 Aesthetic appearance from the Exterior will not change Replace wood windows and Juliette balcony doors with new units from Marvin's Ultimate Wood product line (or approved equal), new units to be primed from manufacturer and receive two (2) coats of paint onsite to match existing colors. New windows/doors shall match profile and appearance of existing window units. Please see Sheet A003 and A003.1 for more information. New perimeter sealants (i.e., caulking) will be installed in conjunction with the window/Juliette balcony door replacements.
10	Building 1220- 1226: Metal Roof	•	Existing standing seam metal roof is in serviceable condition, but the paint is peeling. There are missing snow guards.		 Aesthetic appearance from the Exterior will not change Replace missing snow guards. Selective repairs to the metal roof. Prepare and re-paint the metal roof in the color "gray" to match existing.
11	Building 1220- 1226: Facades	•	The facades consist of a combination of brick and wood siding. Sealants (i.e., caulking around windows/doors) are failing in cohesion. The brick has deteriorated mortar joints and cracked brick. The existing painted southern-pine siding (which is a drop channel style) has peeling paint and some limited rotted pieces.		 Aesthetic appearance from the Exterior will not change Selective tuckpointing and brick replacement on an allowance basis. Once the contractor accesses the facades, the deteriorated mortar joints and brick will be marked for replacement by the Engineer of Record. The new mortar shall be Type N Portland Cement/Lime/Sand. Please see details on A004. Façade sealant/caulking replacement. The new sealant shall match the existing color but be silicone based (i.e., Dow Corning 795). Selective siding replacement on an allowance basis. Once the contractor accesses the facades, the deteriorated siding will be marked for replacement by the Engineer of Records. The new siding is to match existing materials in composition, size, dimensions, and appearance. Please see A006 for existing and proposed siding. Repaint the siding and trim with Sherwin Williams Resilience paint in owner approved colors, to match existing.

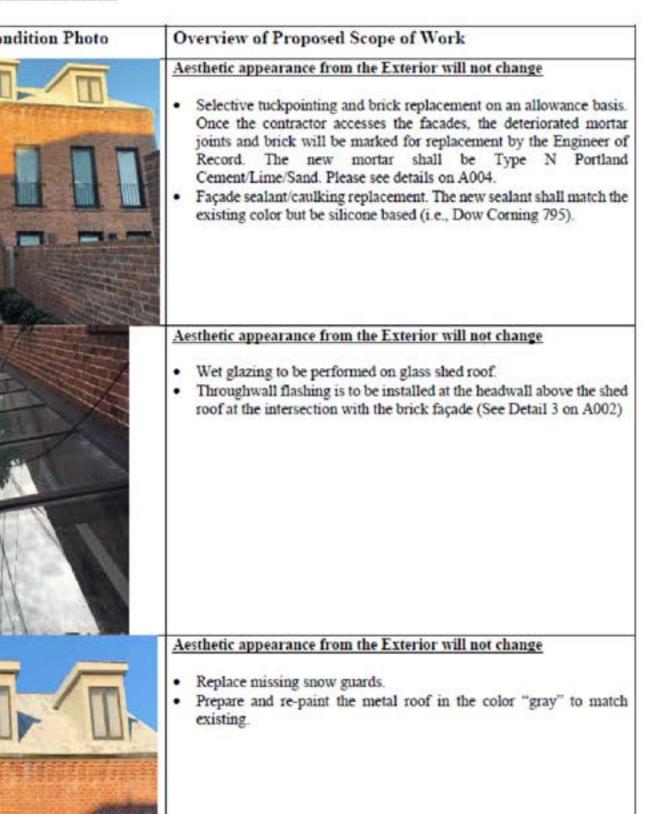

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BUILDING ENVELOPE REHABILITATIONS
HAMILTON COURTS 1220—1236 31ST STREET, NW WASHINGTON, DC
CSG PROJECT #: DRAWN BY: 16-114 MTC DATE: APPROVED BY:
02-01-2021 RMRJ SCALE:
NOT TO SCALE REVISIONS: DATE DESCRIPTION
DRAWING TITLE:
PHASE 4 BUILDING ITEM INVENTORY

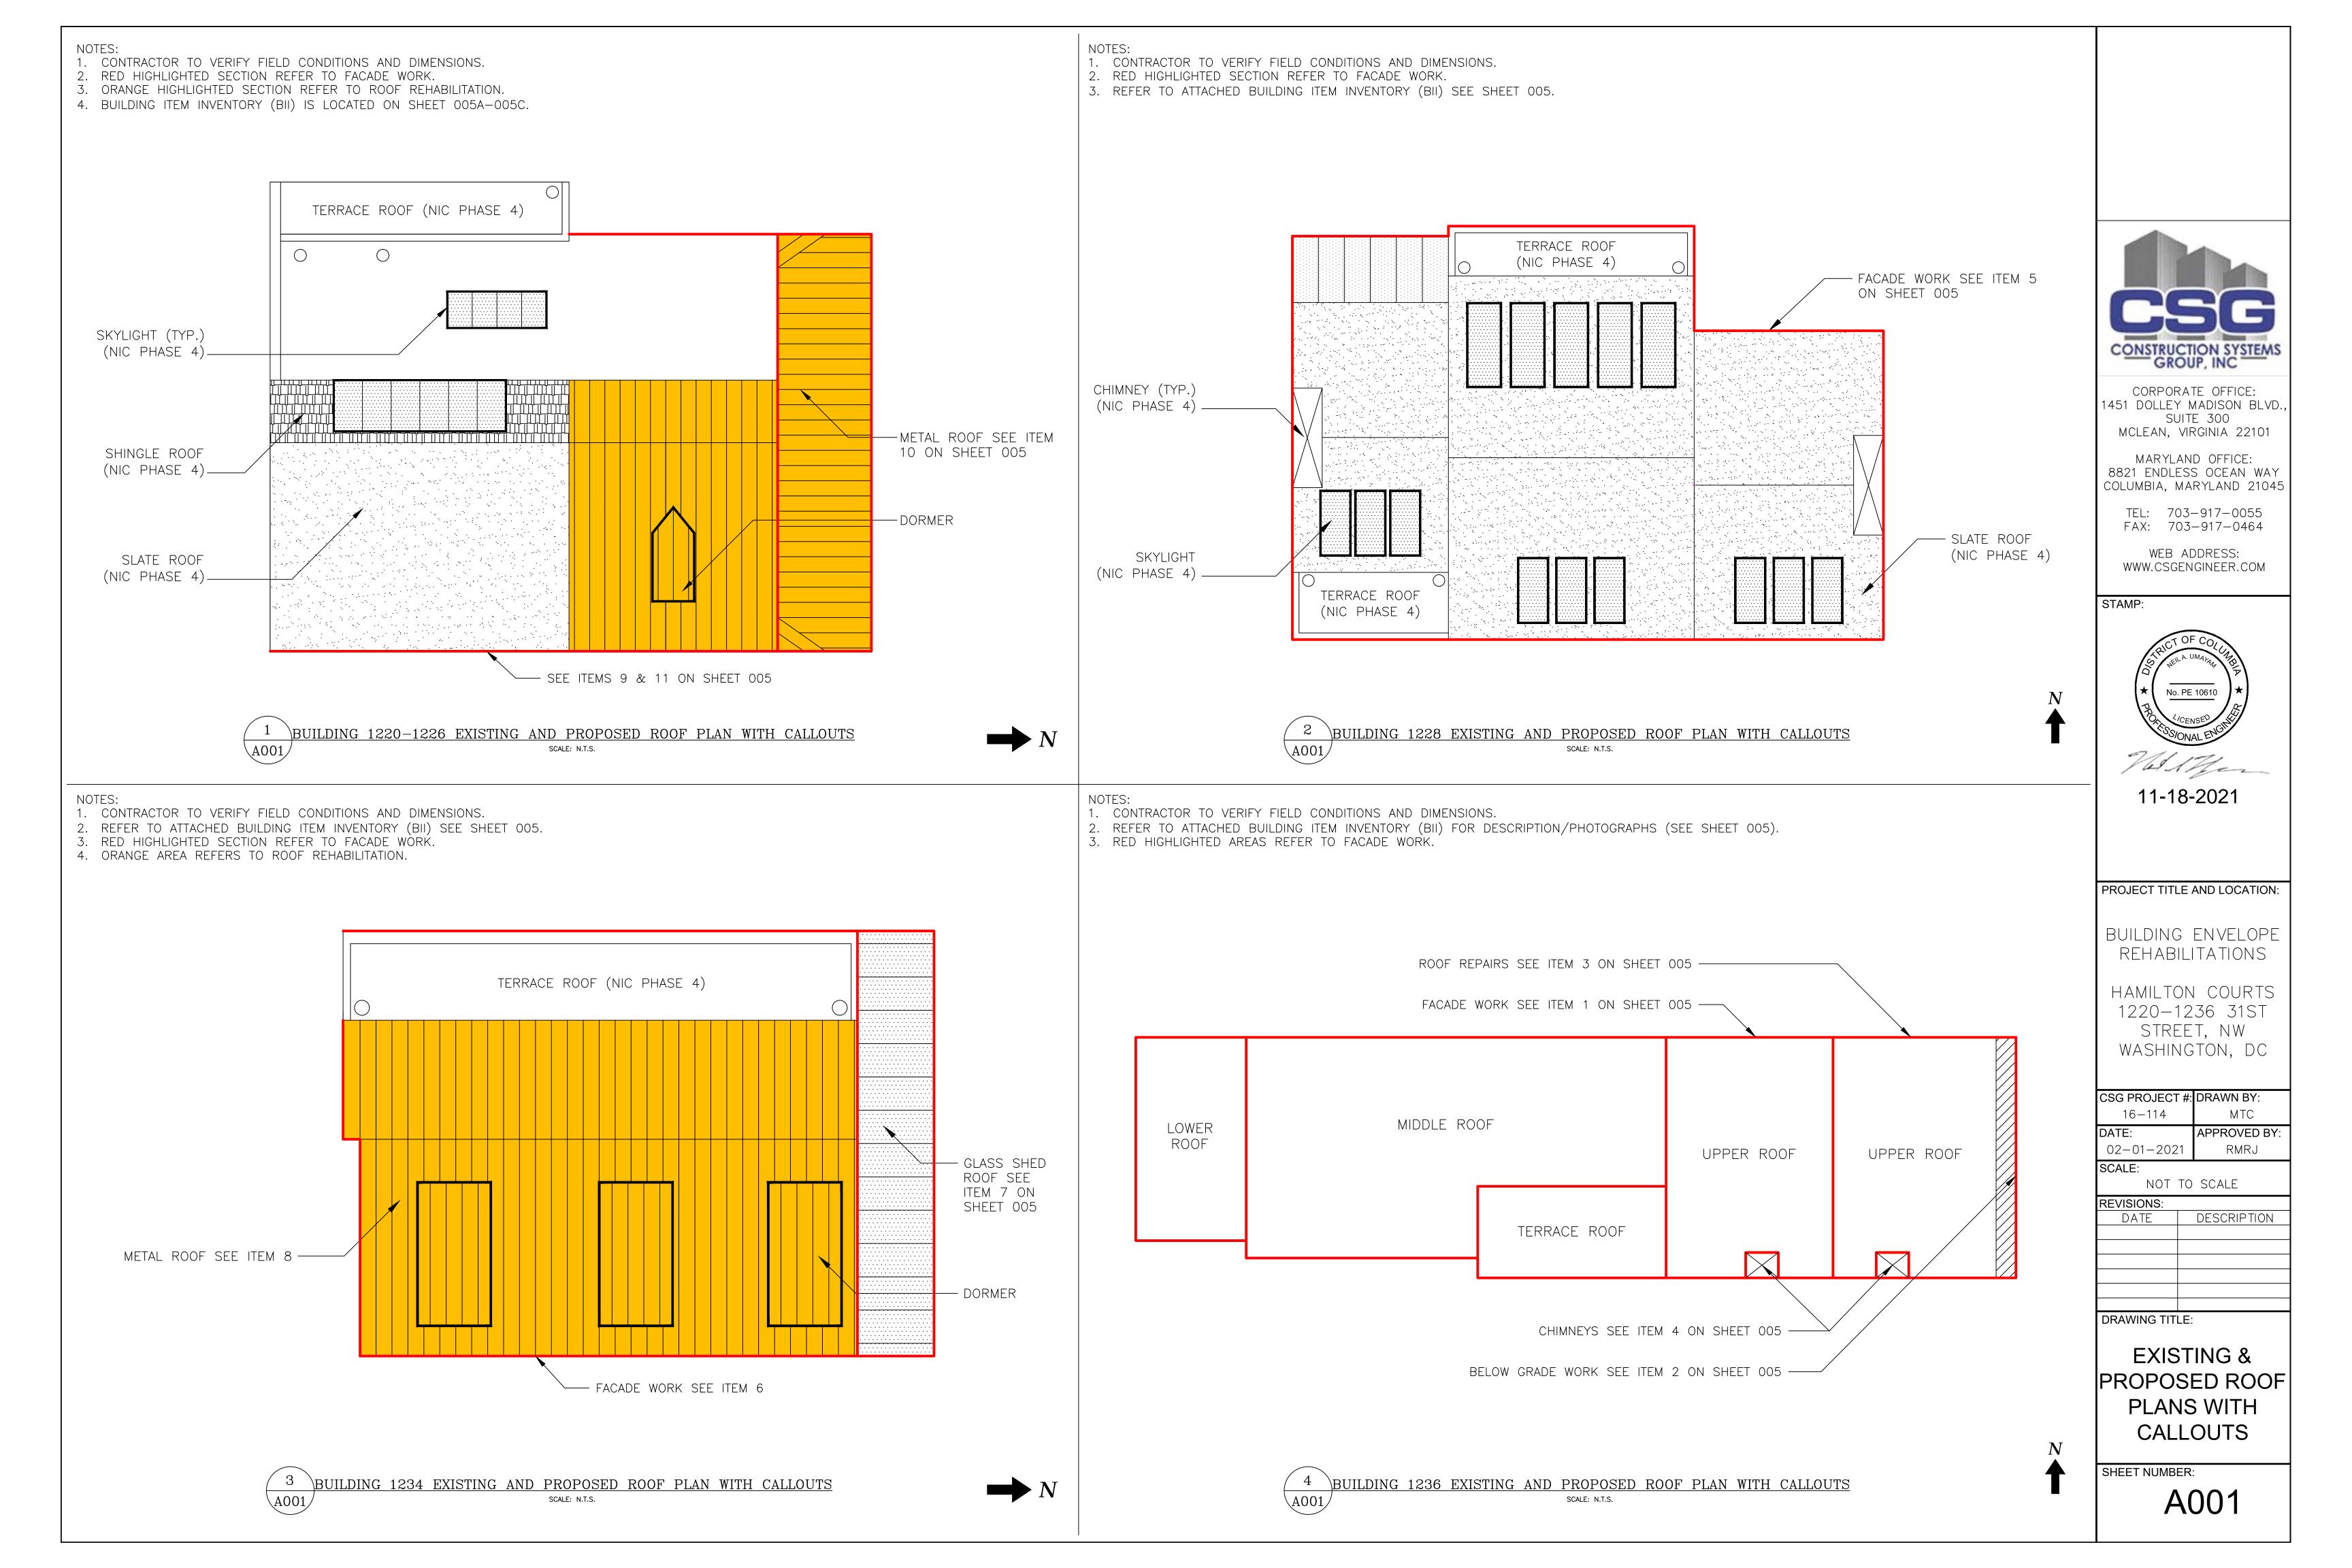

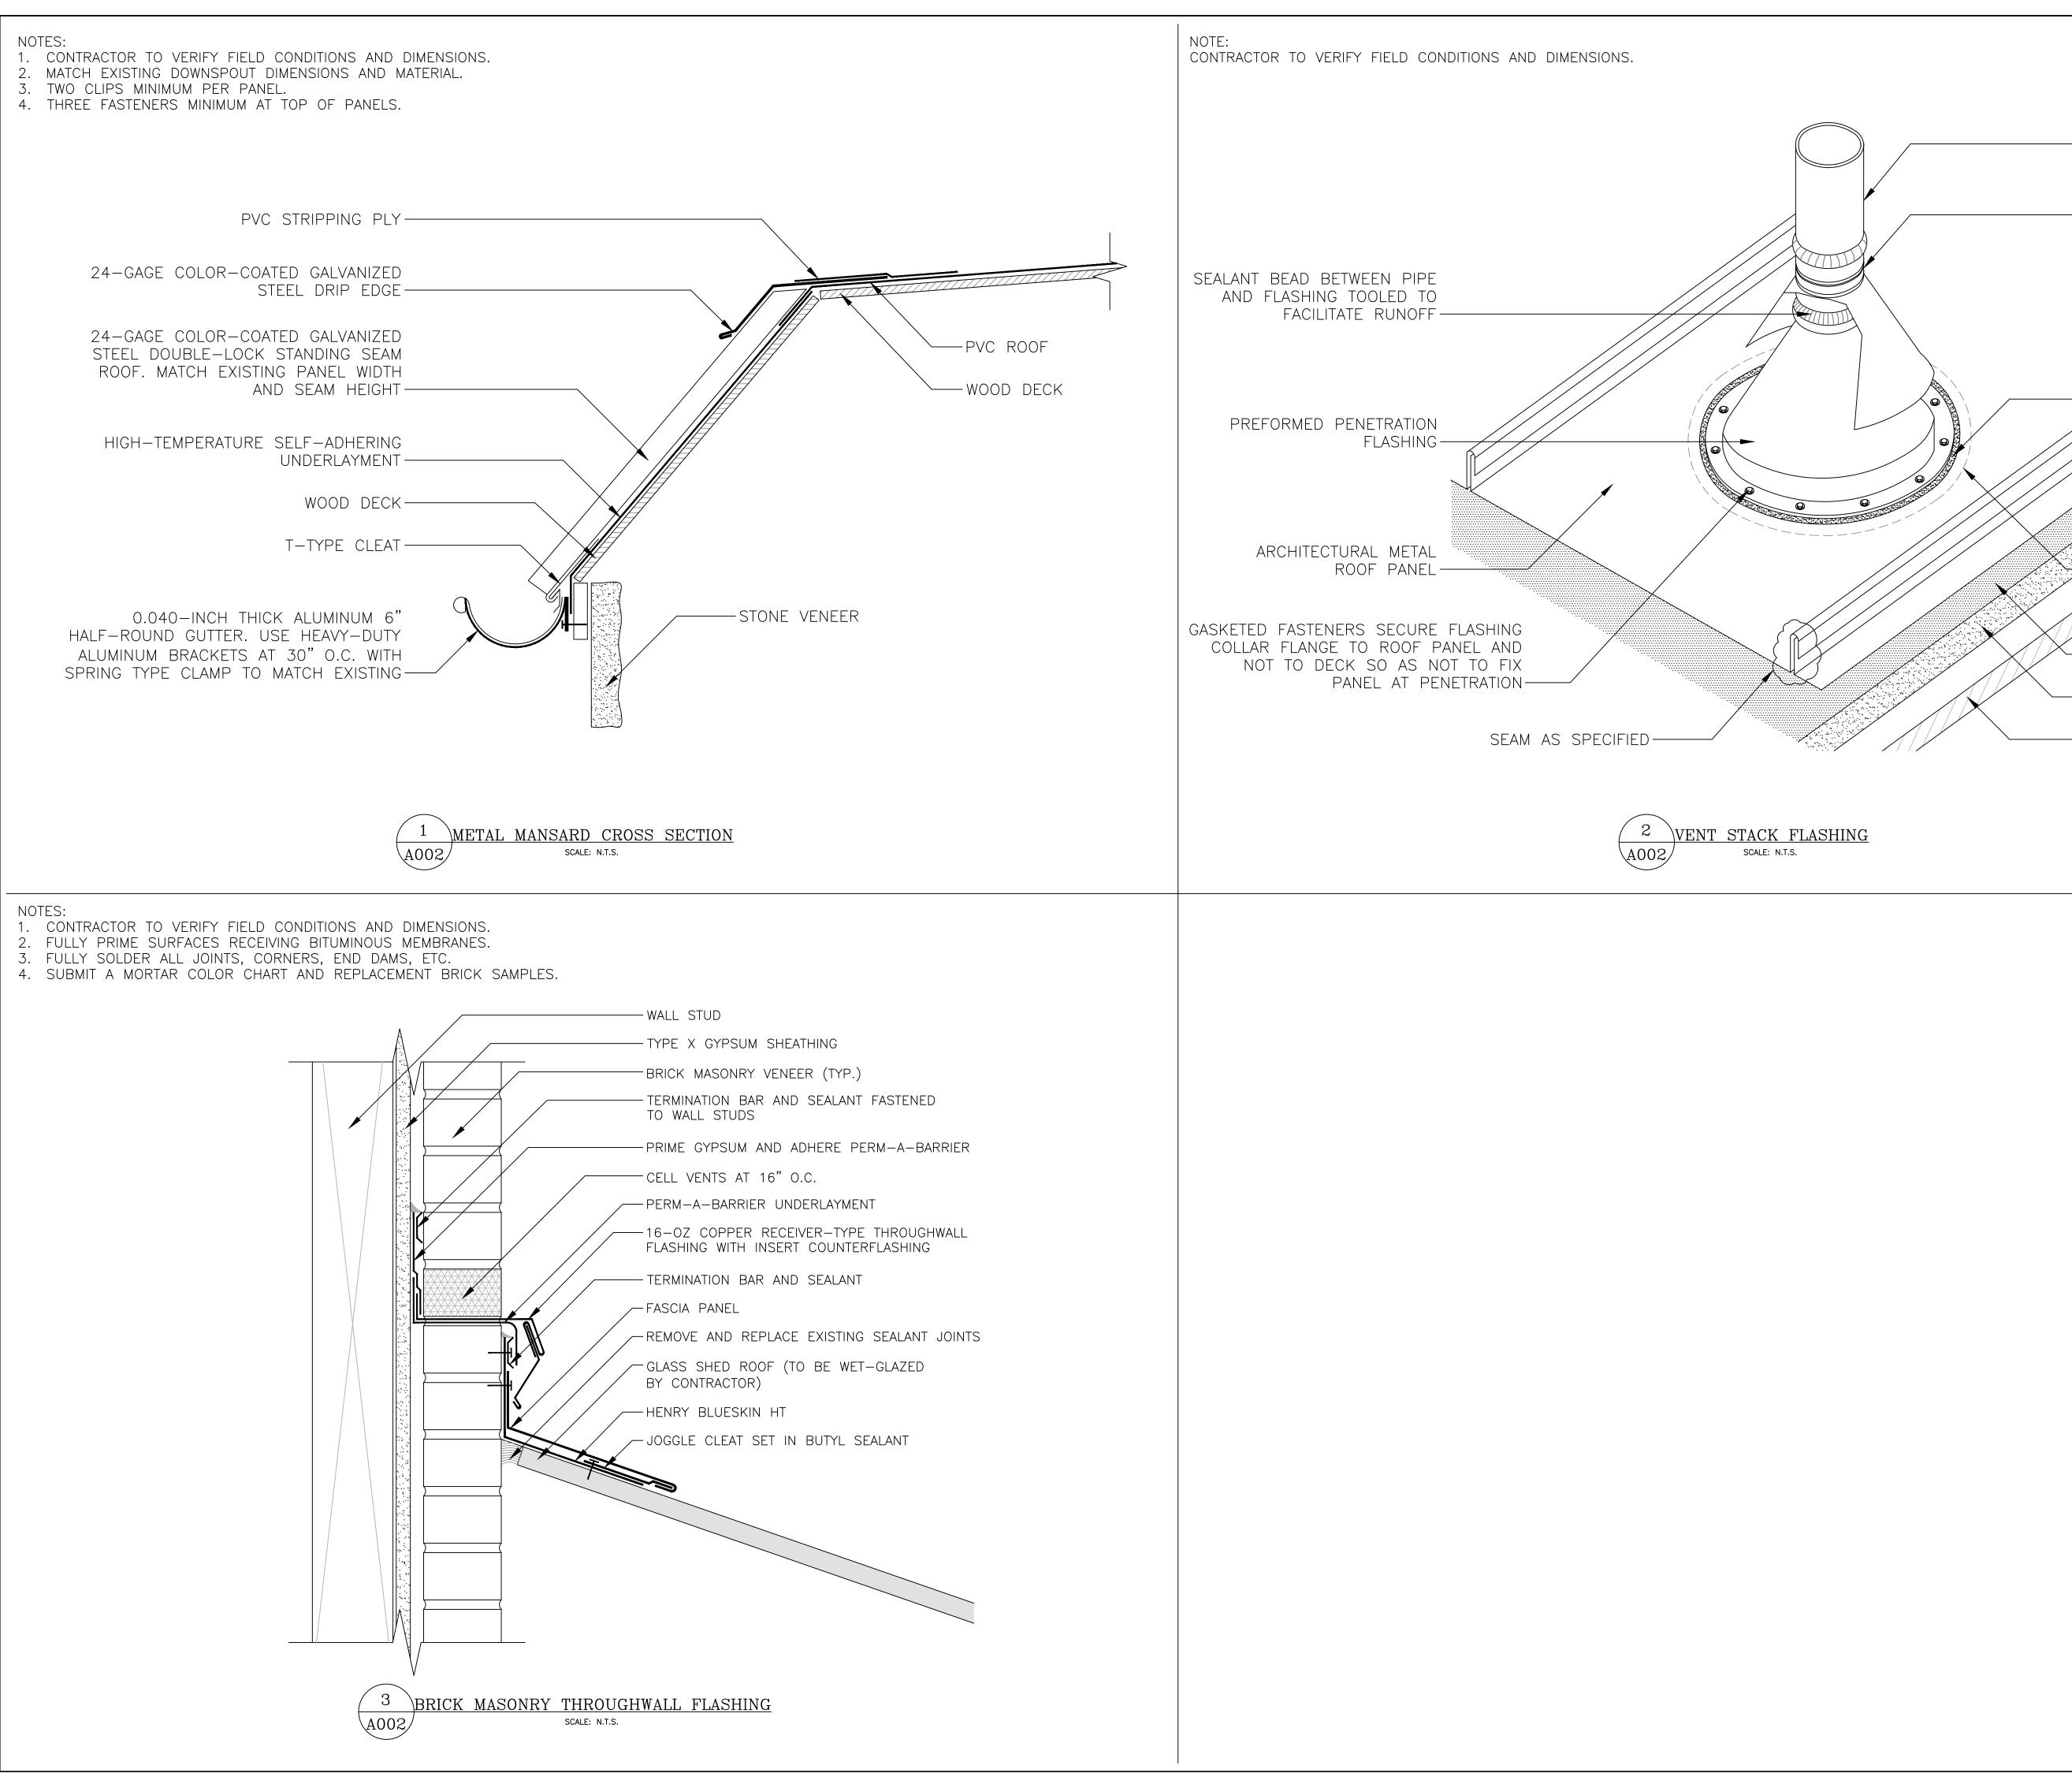

-VENT STACK

-WATERTIGHT SHEET METAL RAIN COLLAR WITH STAINLESS STEEL DRAWBAND OVERLAP FLASHING COLLAR 3" MIN.

-SET SECUREMENT RING IN CONTINUOUS BEAD OF SEALANT

- OPENING IN ROOF DECK

-SLIP SHEET

-UNDERLAYMENT

-WOOD DECK




CORPORATE OFFICE: 1451 DOLLEY MADISON BLVD., SUITE 300 MCLEAN, VIRGINIA 22101

MARYLAND OFFICE: 8821 ENDLESS OCEAN WAY COLUMBIA, MARYLAND 21045

TEL: 703-917-0055 FAX: 703-917-0464

WEB ADDRESS: WWW.CSGENGINEER.COM

STAMP:

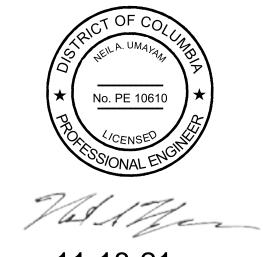

11-18-21

PROJECT TITLE AND LOCATION:

BUILDING ENVELOPE REHABILITATIONS

HAMILTON COURTS 1220–1236 31ST STREET, NW WASHINGTON, DC

CSG PROJECT #: DRAWN BY: 16-114 MTC APPROVED BY: DATE: 02-01-2021 RMRJ SCALE: NOT TO SCALE **REVISIONS**:

DESCRIPTION DATE

DRAWING TITLE:

DETAILS

A002


SHEET NUMBER:

MARVIN 🥥


Ultimate Wood Double Hung


Section Details: Operating

Scale: 3" = 1' 0"

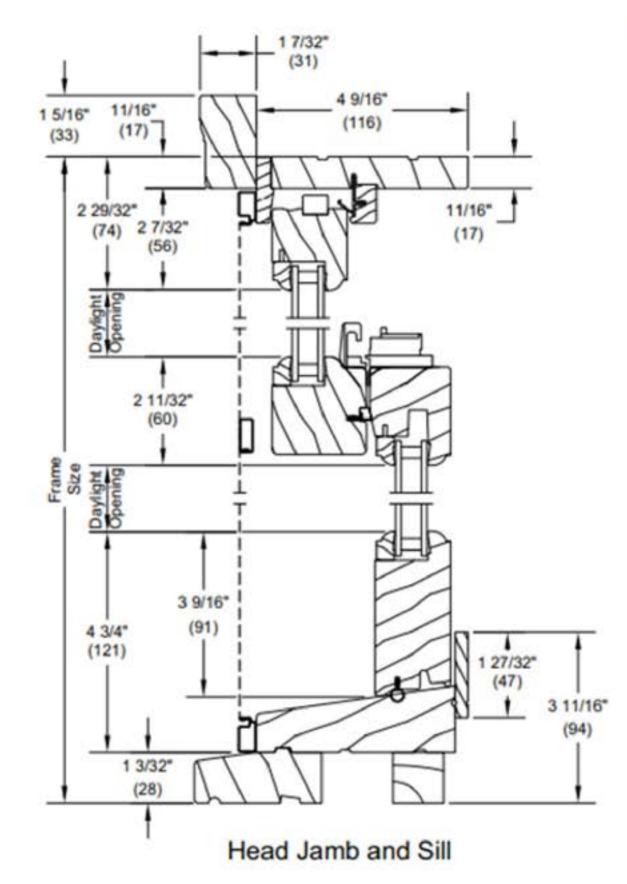


Double Hung

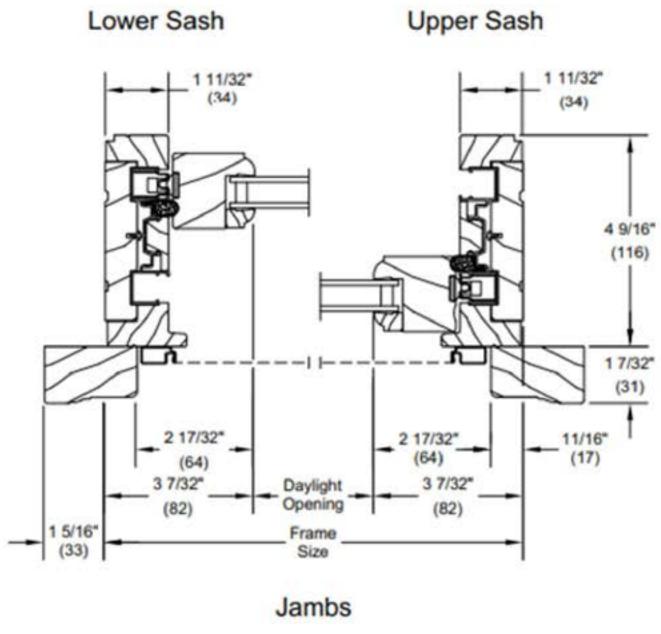

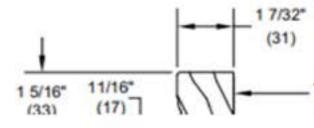




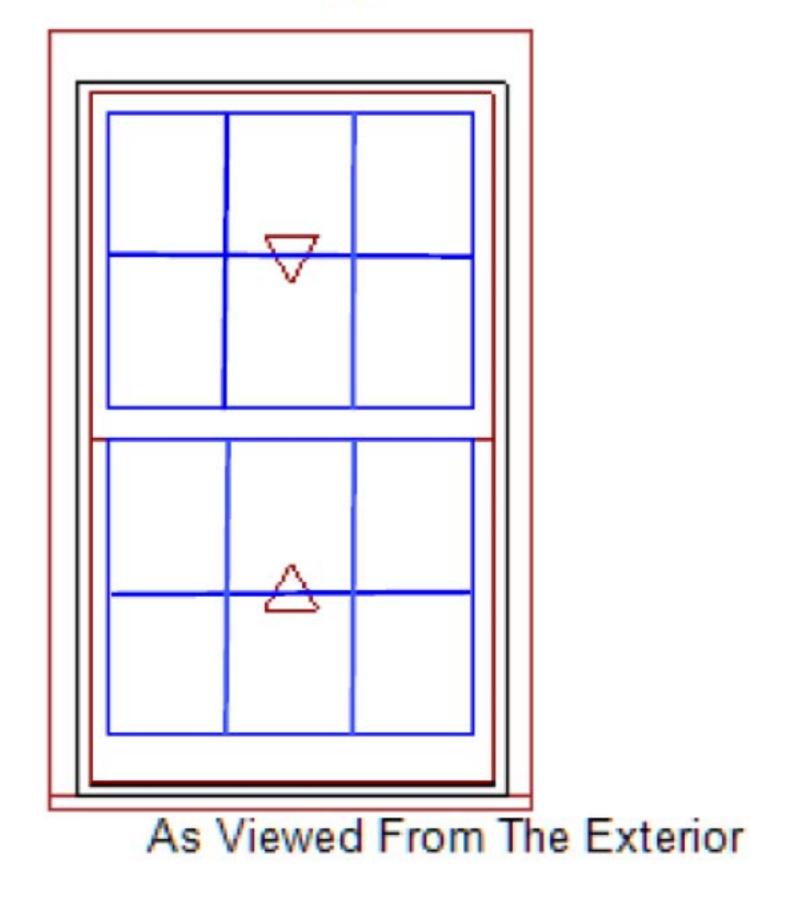

Primed Pine Interior Ultimate Wood Double Hung Top Sash Primed Pine Sash Exterior Primed Pine Sash Interior IG - Authentic Divided Lite Low E2 w/Argon Black Perimeter Bar **Ovolo Exterior Glazing Profile Ovolo Interior Glazing Profile** Bottom Sash Primed Pine Sash Exterior **Primed Pine Sash Interior** IG - Authentic Divided Lite Low E2 w/Argon Black Perimeter Bar Ovolo Exterior Glazing Profile Ovolo Interior Glazing Profile Satin Taupe Sash Lock Beige Jamb Hardware No Screen 4 9/16" Jambs Primed Pine 4" 5/4 Flat Casing - Top Primed Pine 2" 5/4 Flat Casing - Side Primed Pine Standard Subsill

4 9/16

Primed Pine Exterior

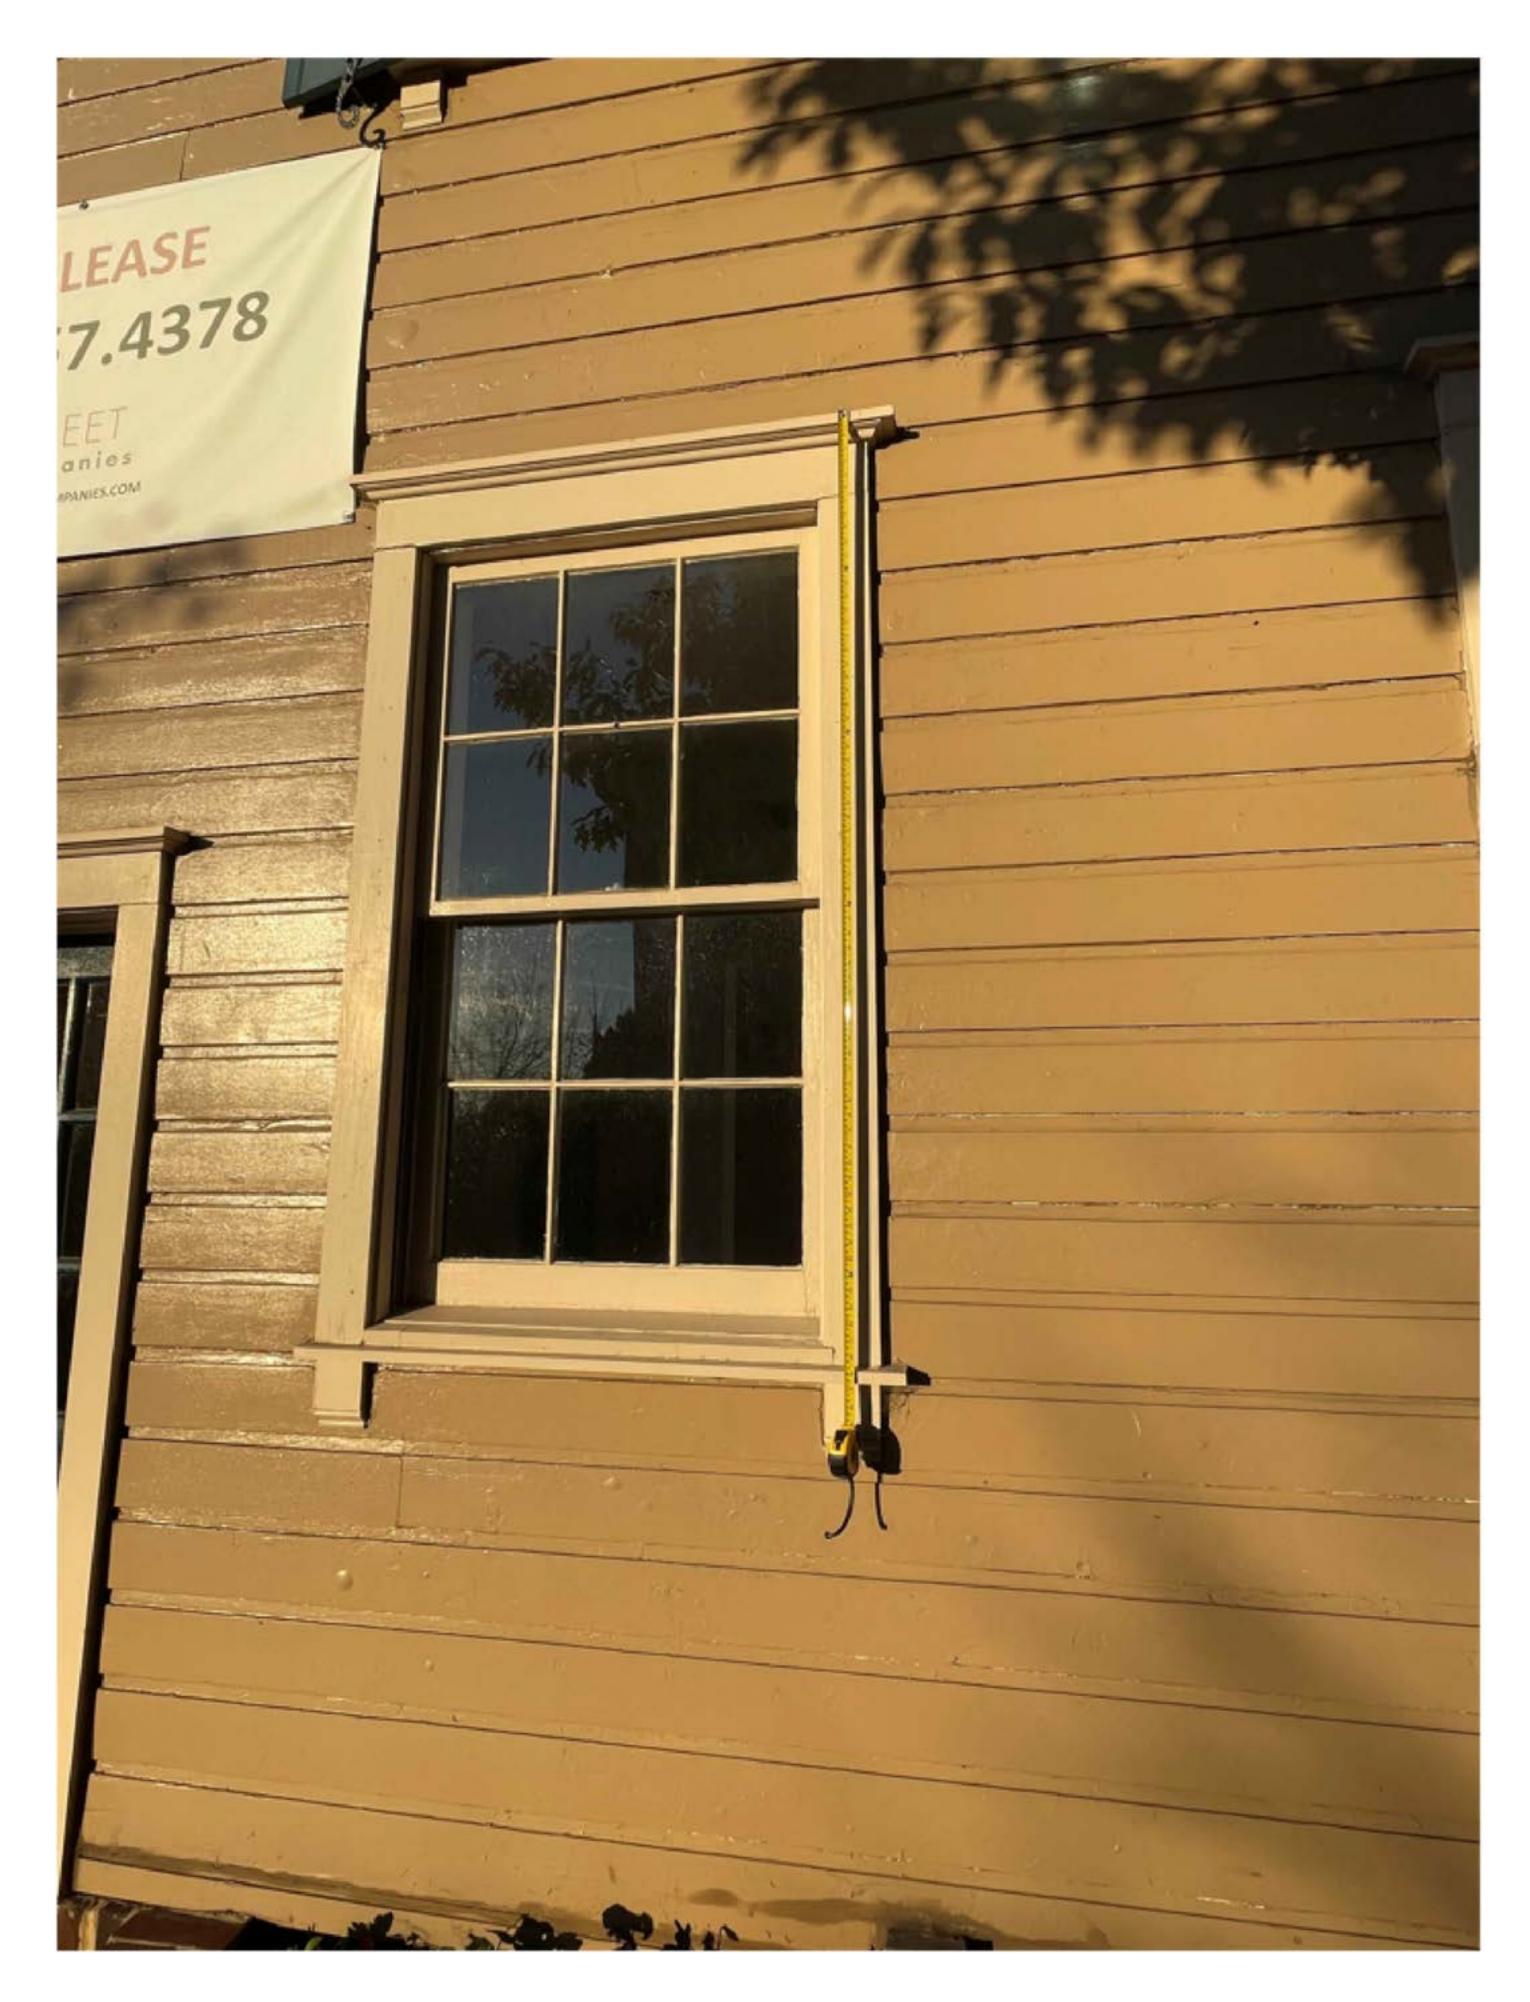


CONSTRUCTION SYSTEMS GROUP, INC
CORPORATE OFFICE: 1451 DOLLEY MADISON BLVD., SUITE 300 MCLEAN, VIRGINIA 22101
MARYLAND OFFICE: 8821 ENDLESS OCEAN WAY COLUMBIA, MARYLAND 21045
TEL: 703–917–0055 FAX: 703–917–0464
WEB ADDRESS: WWW.CSGENGINEER.COM
STAMP:
No. PE 10610 No. PE 10610 NO. PE 10610 NO. PE 10610 NO. PE 10610 NO. PE 10610 THE NO. PE 1000 THE NO. PE 1000 THE NO. PE 1000 THE
PROJECT TITLE AND LOCATION:
BUILDING ENVELOPE REHABILITATIONS
HAMILTON COURTS 1220—1236 31ST STREET, NW WASHINGTON, DC
CSG PROJECT #: DRAWN BY: 16-114 MTC
DATE: APPROVED BY: 02-01-2021 RMRJ
NOT TO SCALE REVISIONS:
DATE DESCRIPTION
DRAWING TITLE:
DOUBLE HUNG WINDOWS
SHEET NUMBER:




Ultimate Inswing Door


Inswing Section Details: Operating

Scale: 3" = 1' 0"

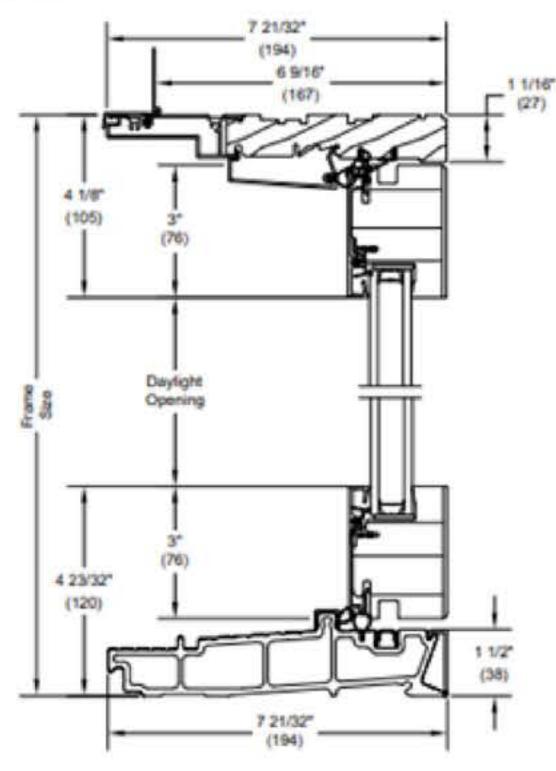


6 9/16" Head Jamb and Sill

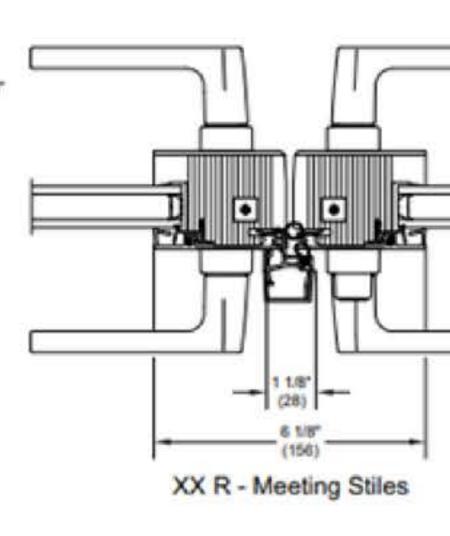


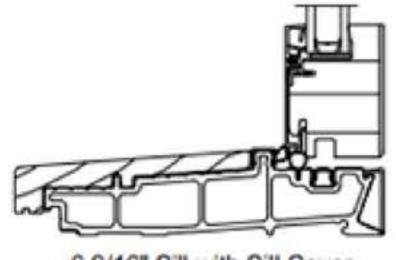


6 9/16" Sill with Sill Cover

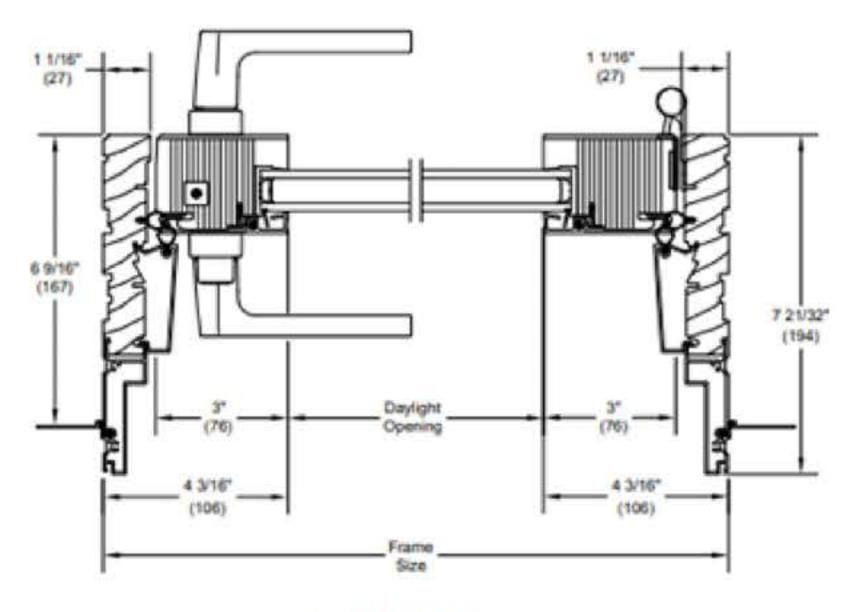

6 9/16" X R Jamb

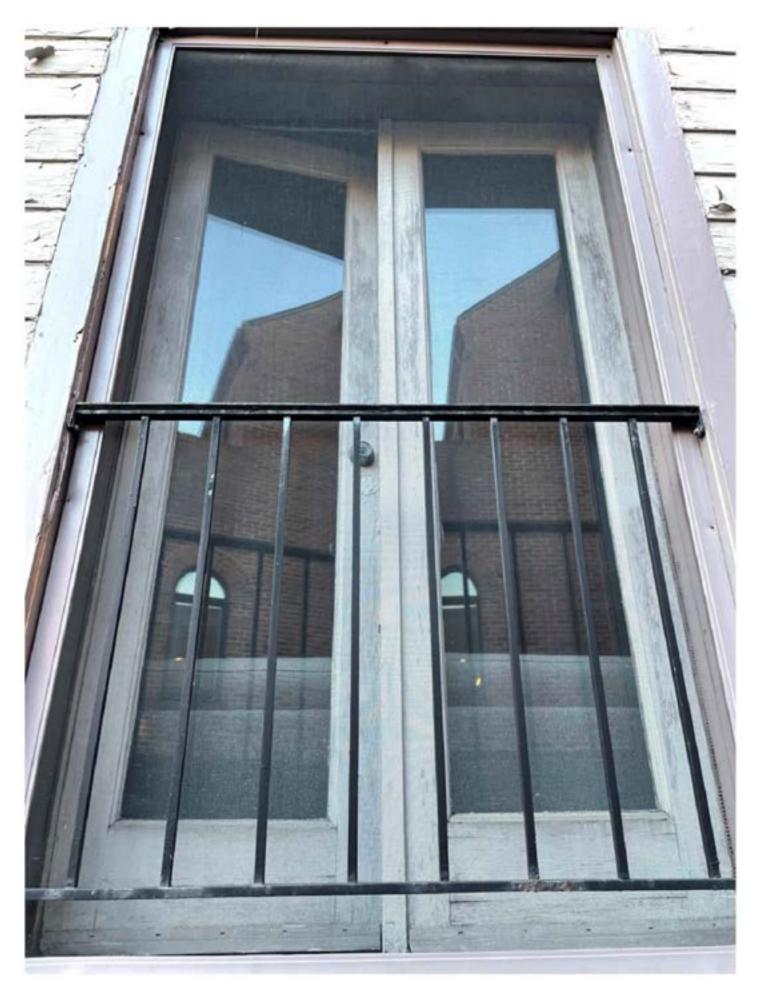

EXAMPLE OF EXISTING JULIETTE BALCONY DOOR

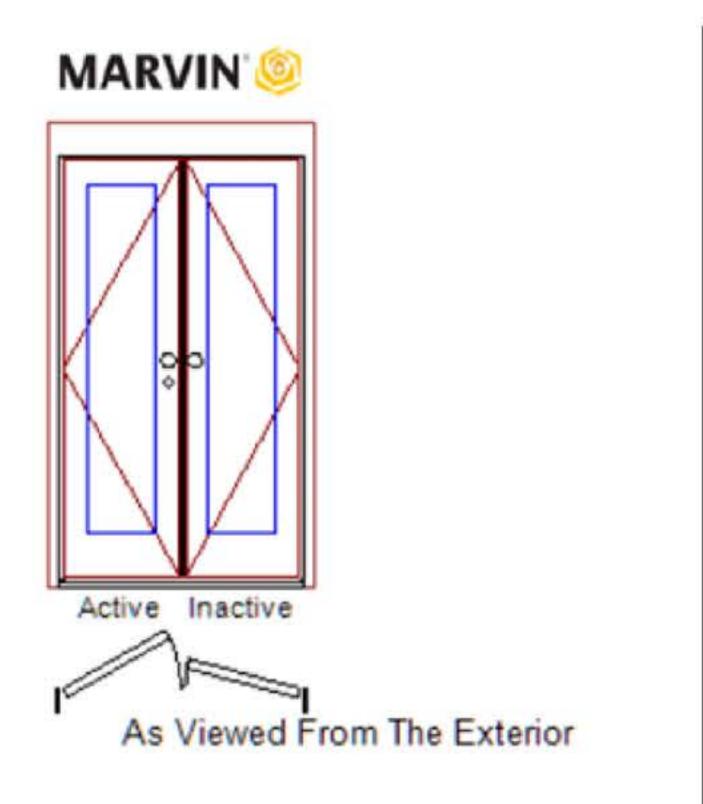


Primed Pine Exterior Primed Pine Interior Ultimate Wood Inswing French Door 4 9/16" - XX Left Hand Traditional Panels Left Panel Primed Pine Sash Exterior Primed Pine Sash Interior IG - 1 Lite Tempered Low E2 w/Argon Black Perimeter Bar **Ogee Interior Glazing Profile Right Panel** Primed Pine Sash Exterior Primed Pine Sash Interior IG - 1 Lite Tempered Low E2 w/Argon Black Perimeter Bar **Ogee Interior Glazing Profile** Traditional Lever(s) Multi-Point Lock on Active Panel Satin Taupe Active Exterior Handle Set on Active Panel Keyed Satin Taupe Active Interior Handle Set on Active Panel Satin Taupe Dummy Exterior Handle Set on Inactive Panel Satin Taupe Dummy Interior Handle Set on Inactive Panel Satin Taupe Adjustable Hinges 3 Per Panel


CONSTRUCTION SYSTEMS GROUP, INC
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TEL: 703-917-0055 FAX: 703-917-0464 WEB ADDRESS:
WWW.CSGENGINEER.COM STAMP:
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BUILDING ENVELOPE REHABILITATIONS
HAMILTON COURTS 1220—1236 31ST STREET, NW WASHINGTON, DC
CSG PROJECT #: DRAWN BY: 16-114 MTC DATE: APPROVED BY: 02-01-2021 RMRJ SCALE: NOT TO SCALE
REVISIONS: DATE DESCRIPTION
DRAWING TITLE:
JULIETTE BALCONY DOORS
SHEET NUMBER: A003.1




Section Details: Operating and Stationary / Picture - 3/4" (19) IG

Scale: 3" = 1' 0"

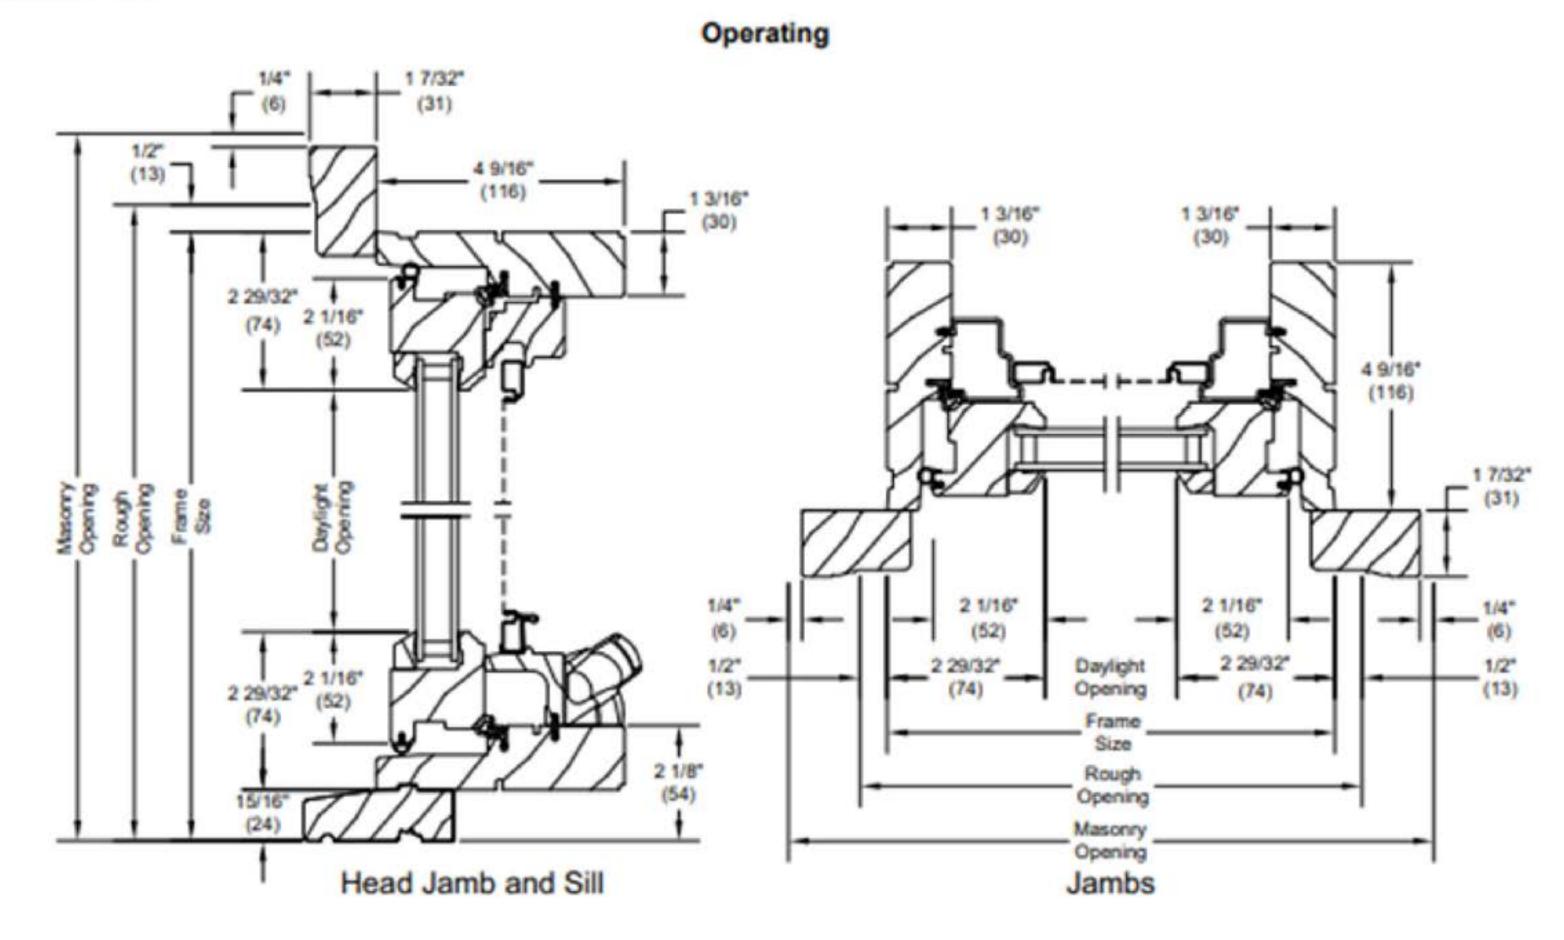

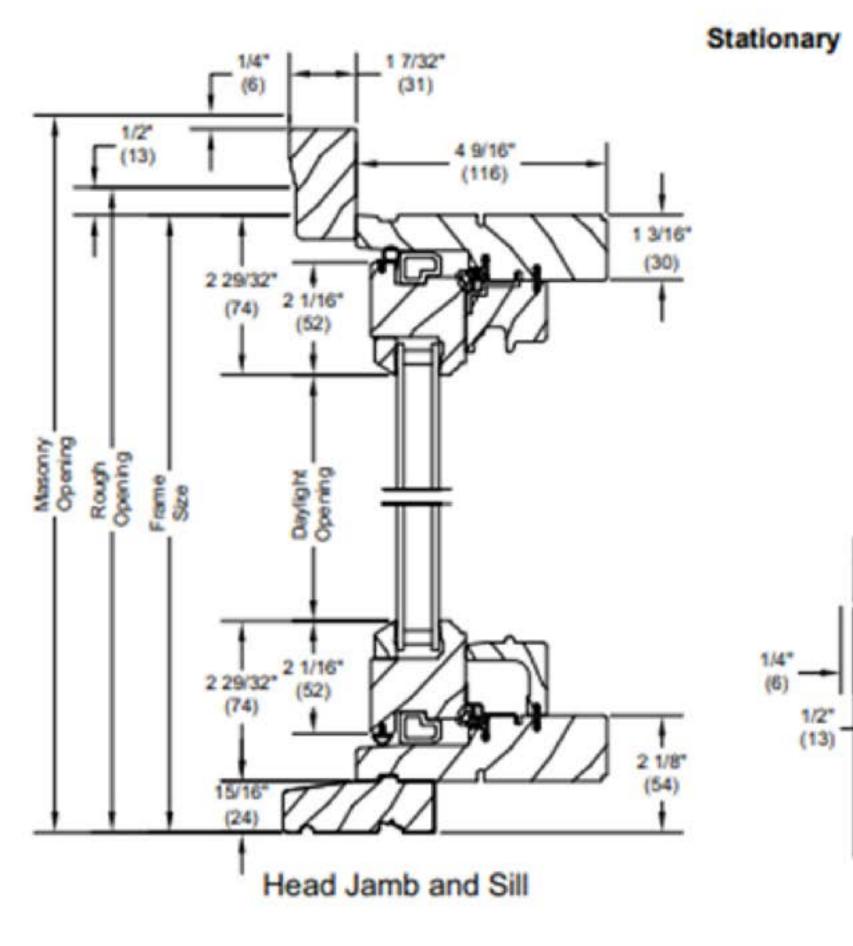

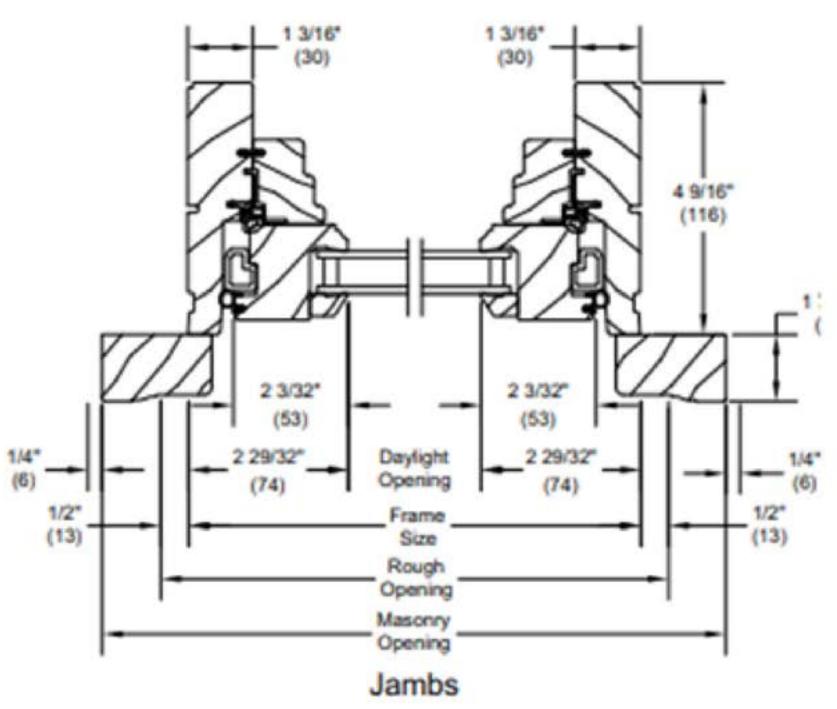


Ultimate Wood Casement, Awning and Picture



EXAMPLE OF EXISTING JULIETTE BALCONY DOOR




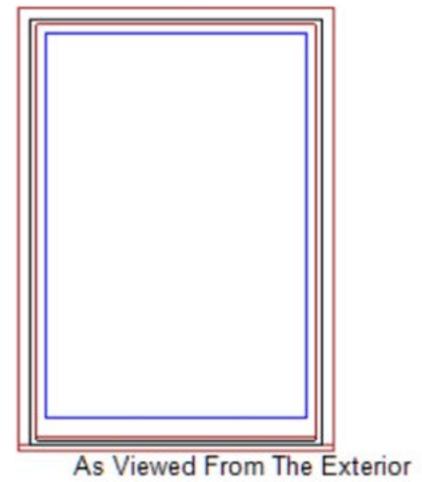

Primed Pine Exterior Primed Pine Interior Ultimate Wood Double Hung Picture 1 5/8 inch Sash ***Sash Ship Loose Primed Pine Sash Exterior Primed Pine Sash Interior IG - 1 Lite Tempered Low E2 w/Argon Black Perimeter Bar **Ovolo Exterior Glazing Profile Ovolo Interior Glazing Profile** 5 1/2" Jambs Primed Pine 2" 5/4 Flat Casing Primed Pine Standard Subsill Non Finger-Jointed Subsill Non Finger-Jointed Sill No Installation Method ***Note: Unit Availability and Price is Subject to Change

CONSTRUCTION SYSTEMS GROUP, INC
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No. PE 10610 PROTOF COLUMBER NO. PE 10610 PROTOF COLUMBER NO. PE 10610 PROTOF COLUMBER NO. PE 10610 PROTOF COLUMBER PROTOF COLUMBER P
November 22, 2021
PROJECT TITLE AND LOCATION:
BUILDING ENVELOPE REHABILITATIONS
HAMILTON COURTS 1220—1236 31ST STREET, NW WASHINGTON, DC
CSG PROJECT #: DRAWN BY: 16-114 MTC
DATE: APPROVED BY: 02-01-2021 RMRJ
SCALE: NOT TO SCALE REVISIONS:
DATE DESCRIPTION
DRAWING TITLE:
FIXED PICTURE WINDOW
SHEET NUMBER:

MARVIN 🥘

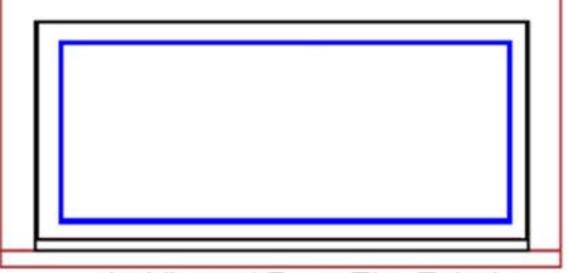

As Viewed From The Exterior

Primed Pine Exterior Primed Pine Interior Ultimate Wood Transom/Picture Primed Pine Sash Exterior **Primed Pine Sash Interior** IG - 3/4" - 1 Lite Tempered Low E2 **Black Perimeter Bar Ovolo Interior Glazing Profile** Standard Bottom Rail Beige Weather Strip Satin Taupe Folding Handle Satin Taupe Multi - Point Lock Interior Wood Screen Charcoal Hi-Transparency Fbrgls Mesh Primed Pine **Ovolo Interior Screen Profile** 7" Jambs Primed Pine 2" 5/4 Flat Casing Primed Pine Standard Subsill Non Finger-Jointed Subsill








Ultimate Wood Casement, Awning and Picture Section Details: Operating and Stationary / Picture - 3/4" (19) IG

Scale: 3" = 1' 0"


Operating

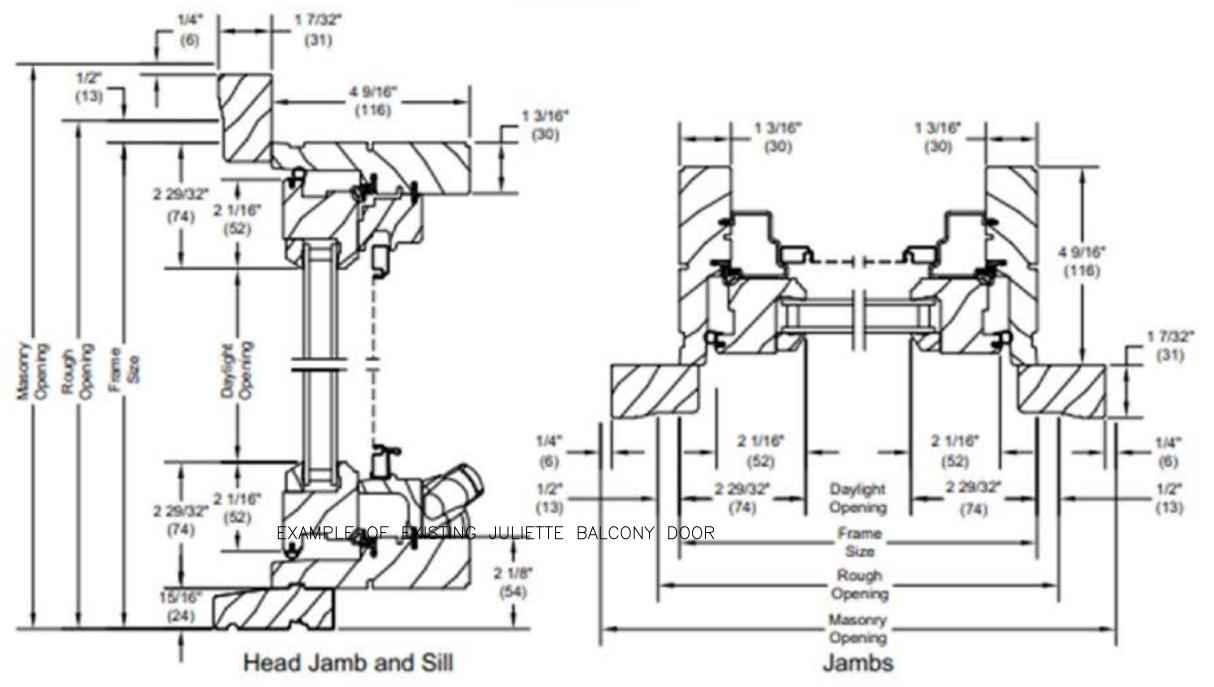

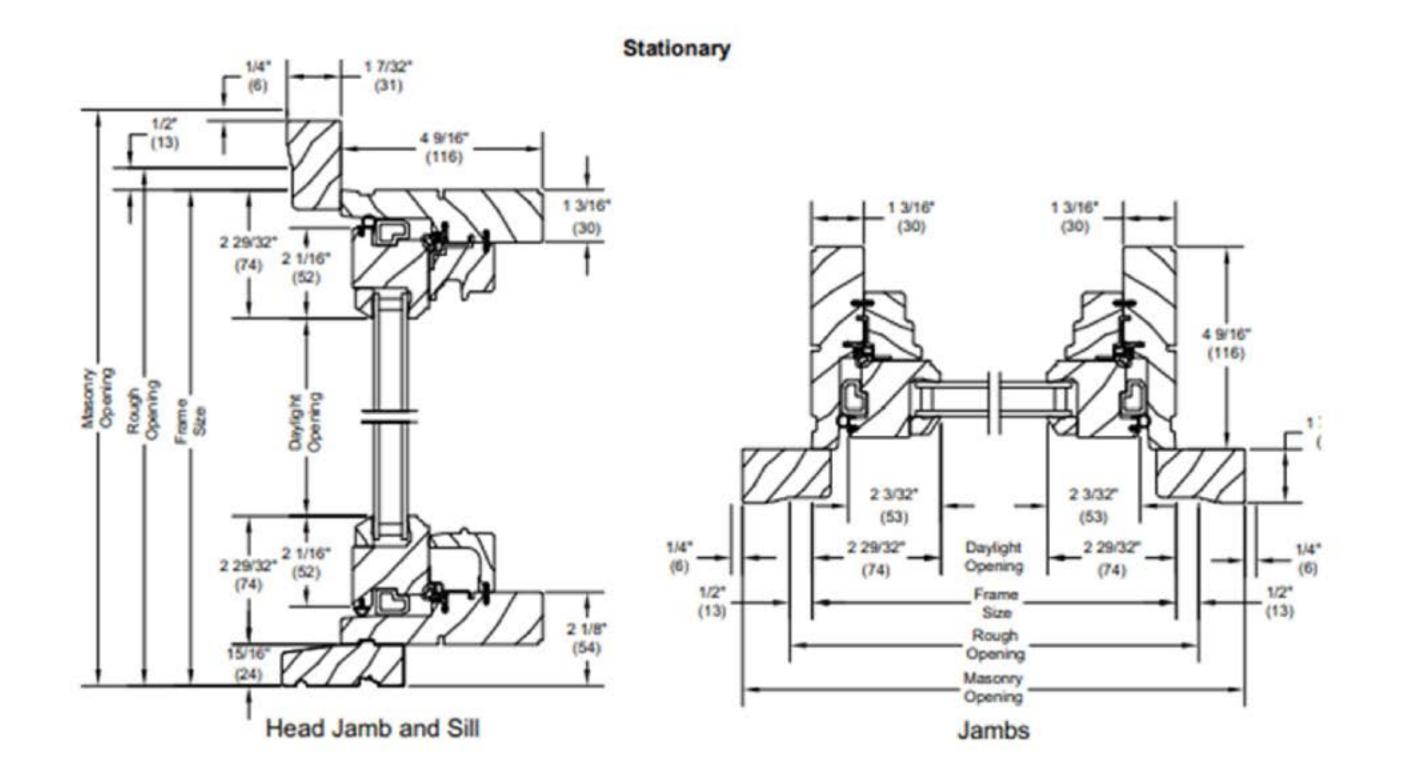

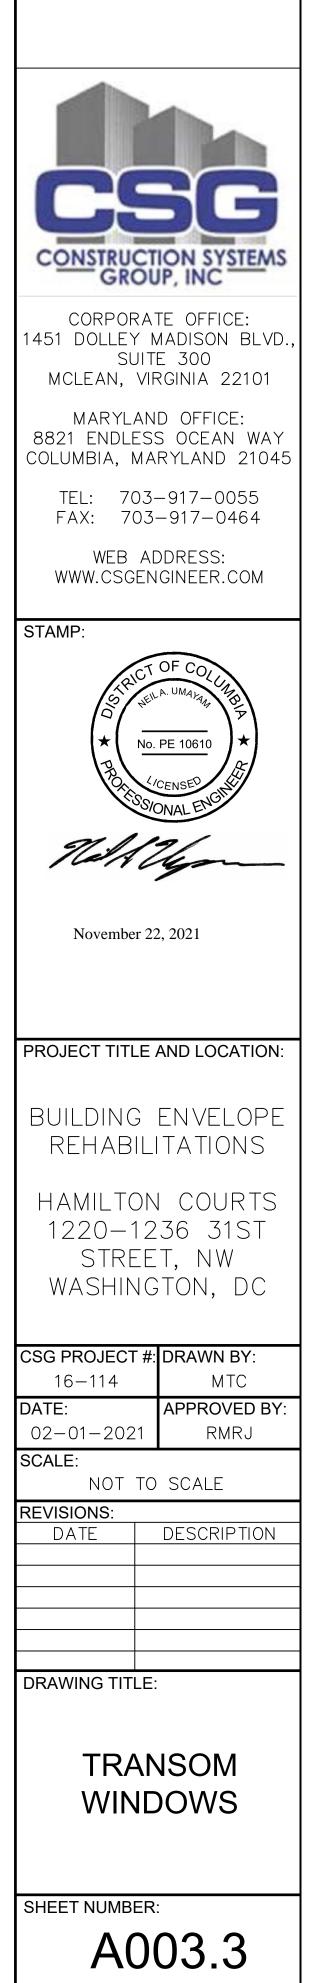



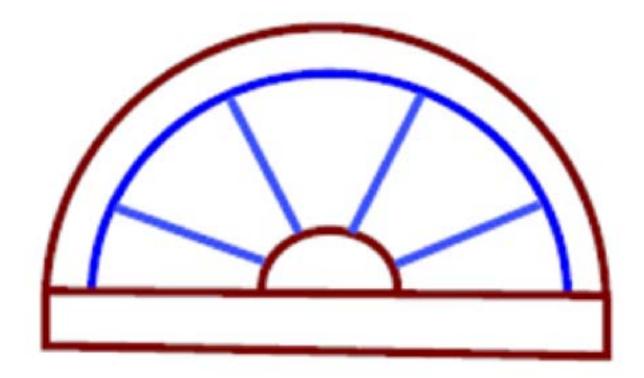


Primed Pine Exterior Primed Pine Interior Ultimate Wood Picture Window ***Sash Ship Loose Primed Pine Sash Exterior Primed Pine Sash Interior Authentic Divided Lite Tempered Low E2 w/Argon Black Perimeter Bar **Ovolo Exterior Glazing Profile Ovolo Interior Glazing Profile** 5 1/2" Jambs Primed Pine 2" 5/4 Flat Casing Primed Pine Standard Subsill Non Finger-Jointed Subsill Non Finger-Jointed Sill No Installation Method ***Note: Unit Availability and Price is Subject to Change


MARVIN 🥘


Ultimate Wood Casement, Awning and Picture

Section Details: Operating and Stationary / Picture - 3/4" (19) IG

Scale: 3" = 1' 0"

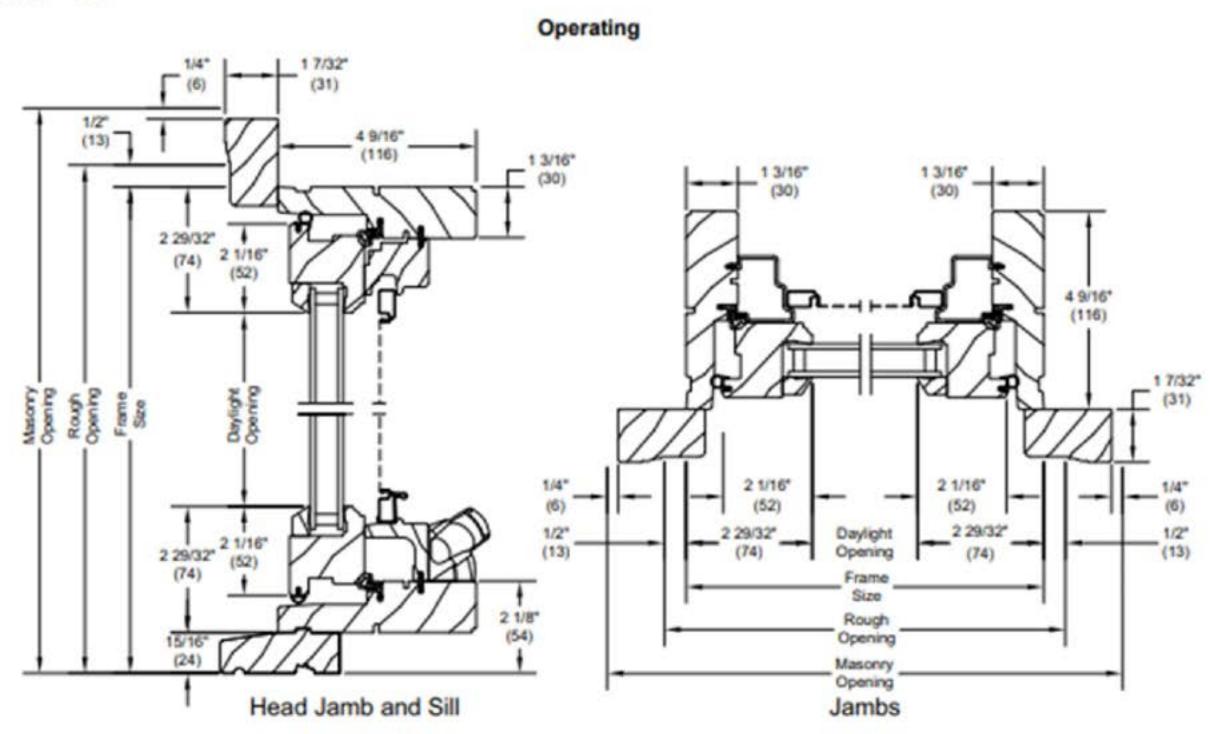

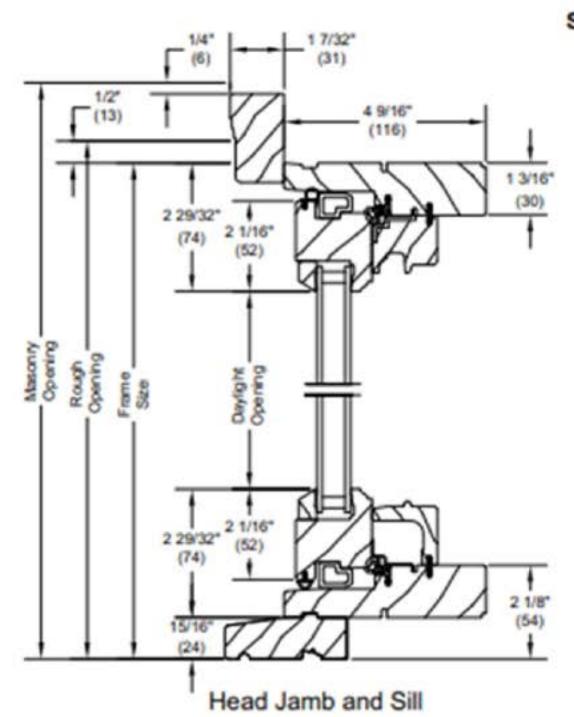

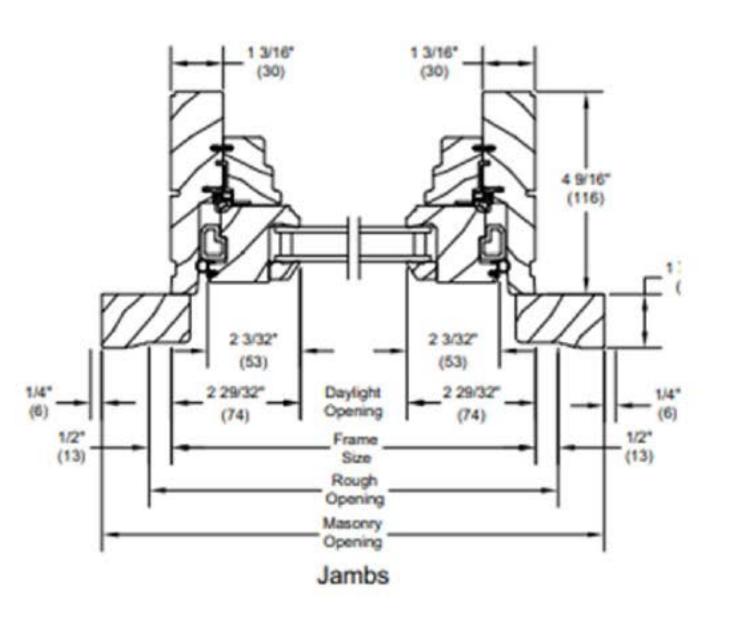

Stationary


CONSTRUCTION SYSTEMS GROUP, INC
CORPORATE OFFICE: 1451 DOLLEY MADISON BLVD., SUITE 300 MCLEAN, VIRGINIA 22101
MARYLAND OFFICE: 8821 ENDLESS OCEAN WAY COLUMBIA, MARYLAND 21045
TEL: 703-917-0055 FAX: 703-917-0464
WEB ADDRESS: WWW.CSGENGINEER.COM
STAMP:
No. PE 10610 ROMAL ENGINE November 22, 2021
PROJECT TITLE AND LOCATION:
BUILDING ENVELOPE REHABILITATIONS
HAMILTON COURTS 1220—1236 31ST STREET, NW WASHINGTON, DC
CSG PROJECT #: DRAWN BY: 16-114 MTC DATE: APPROVED BY: 02-01-2021 RMRJ
SCALE: NOT TO SCALE REVISIONS:
DATE DESCRIPTION
DRAWING TITLE:
HALF-ROUND WINDOW
SHEET NUMBER:
A003.4



EXAMPLE OF ROT AT SILL



EXAMPLE OF ROT AT SILL

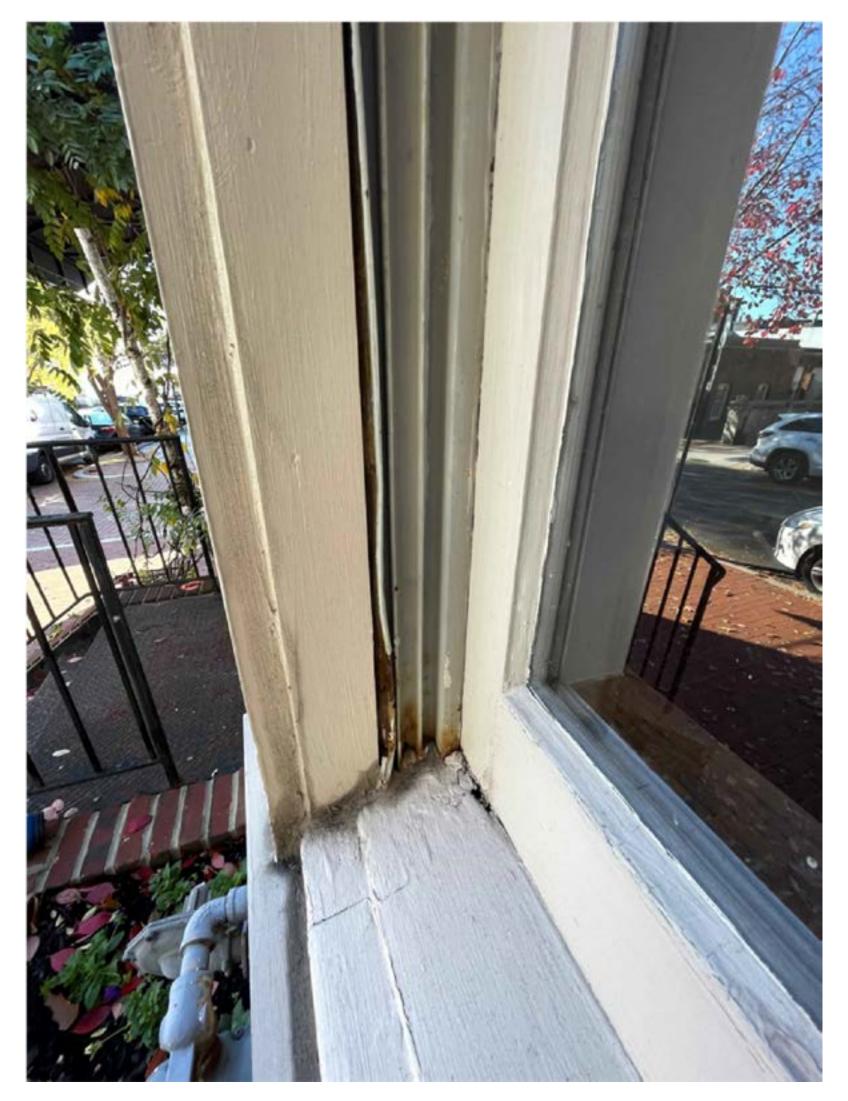



EXAMPLE OF WARPED/ROTTED METAL TRACK



EXAMPLE OF ROT AT JAMB

CONSTRUCTION SYSTEMS	
GROUP, INC	
CORPORATE OFFICE: 1451 DOLLEY MADISON BLVD., SUITE 300 MCLEAN, VIRGINIA 22101	
MARYLAND OFFICE: 8821 ENDLESS OCEAN WAY COLUMBIA, MARYLAND 21045	
TEL: 703–917–0055 FAX: 703–917–0464	
WEB ADDRESS: WWW.CSGENGINEER.COM	
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November 21, 2021	
PROJECT TITLE AND LOCATION:	
BUILDING ENVELOPE REHABILITATIONS	
HAMILTON COURTS 1220—1236 31ST STREET, NW WASHINGTON, DC	
CSG PROJECT #: DRAWN BY:	
16-114 MTC DATE: APPROVED BY: 02-01-2021 RMRJ	
SCALE: NOT TO SCALE	
REVISIONS:DATEDESCRIPTION	
DRAWING TITLE:	
EXISTING WINDOW CONDITION PHOTOS	
SHEET NUMBER: A003.5	

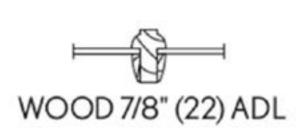

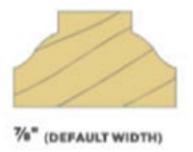

Authentic Divided Lite (ADL)



energy efficiency.


Separate pieces of glass are glazed between muntin bars the way windows have been made since the beginning but with Marvin's updated design to increase




CLOSEUP OF EXISTING MUNTIN




EXISTING MUNTIN CONDITION

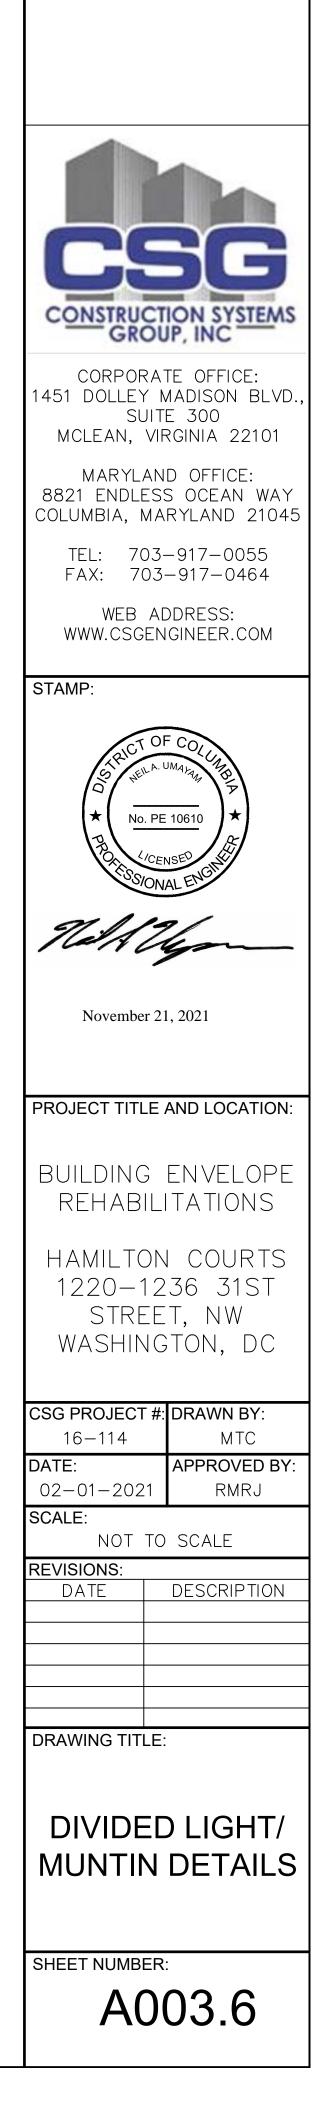

NOTE:

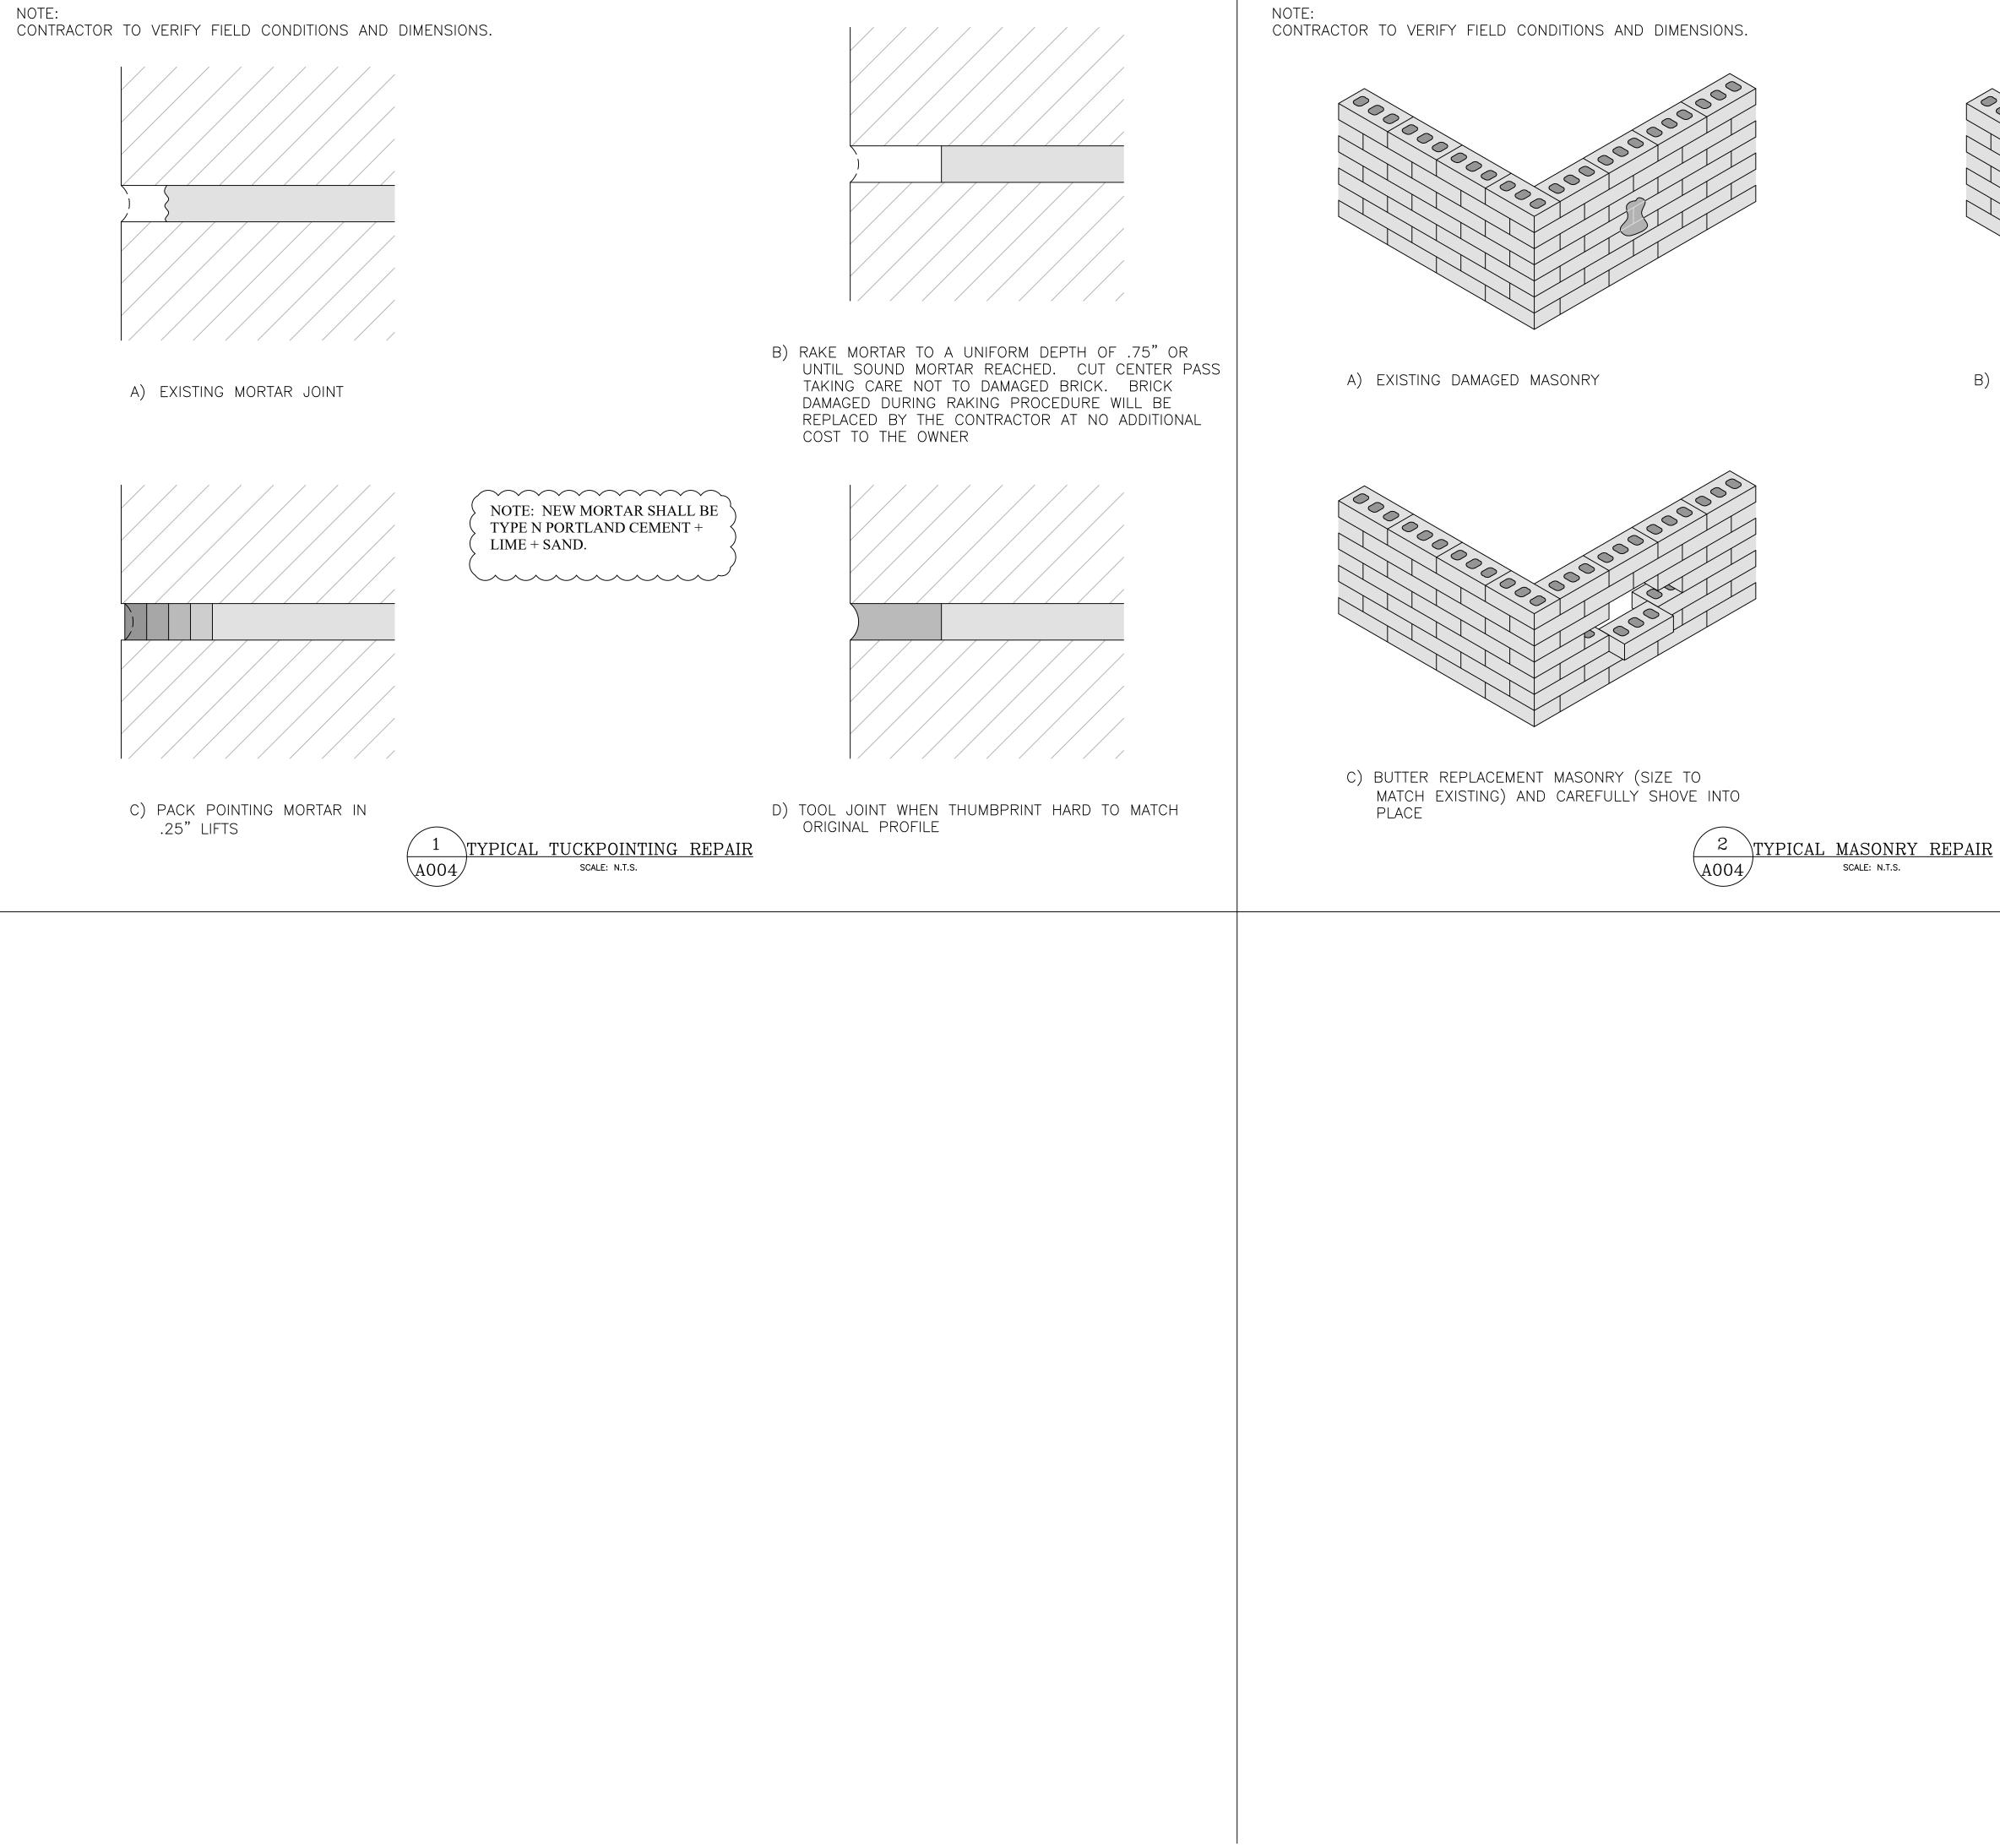


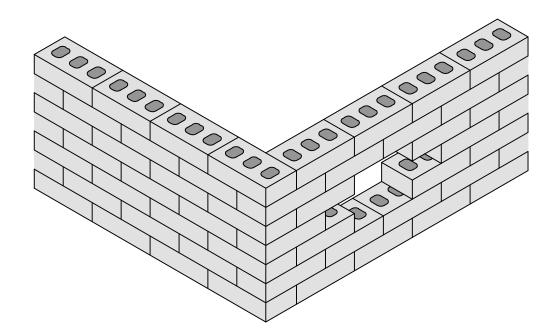

B) REMOVE MASONRY AND MORTAR

NOTE: NEW MORTAR SHALL BE TYPE N PORTLAND CEMENT + LIME + SAND.

CORPORATE OFFICE: ACCORPORATE OFFICE: 1451 DOLLEY MADISON BLVD., SUITE 300 MCLEAN, VIRGINIA 22101 MARYLAND OFFICE: 8821 ENDLESS OCEAN WAY COLUMBIA, MARYLAND 21045 TEL: 703-917-0055
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BUILDING ENVELOPE REHABILITATIONS
HAMILTON COURTS 1220—1236 31ST STREET, NW WASHINGTON, DC
CSG PROJECT #: DRAWN BY:
16-114 MTC DATE: APPROVED BY: 02-01-2021 RMRJ
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REVISIONS:
DATE DESCRIPTION
DRAWING TITLE:

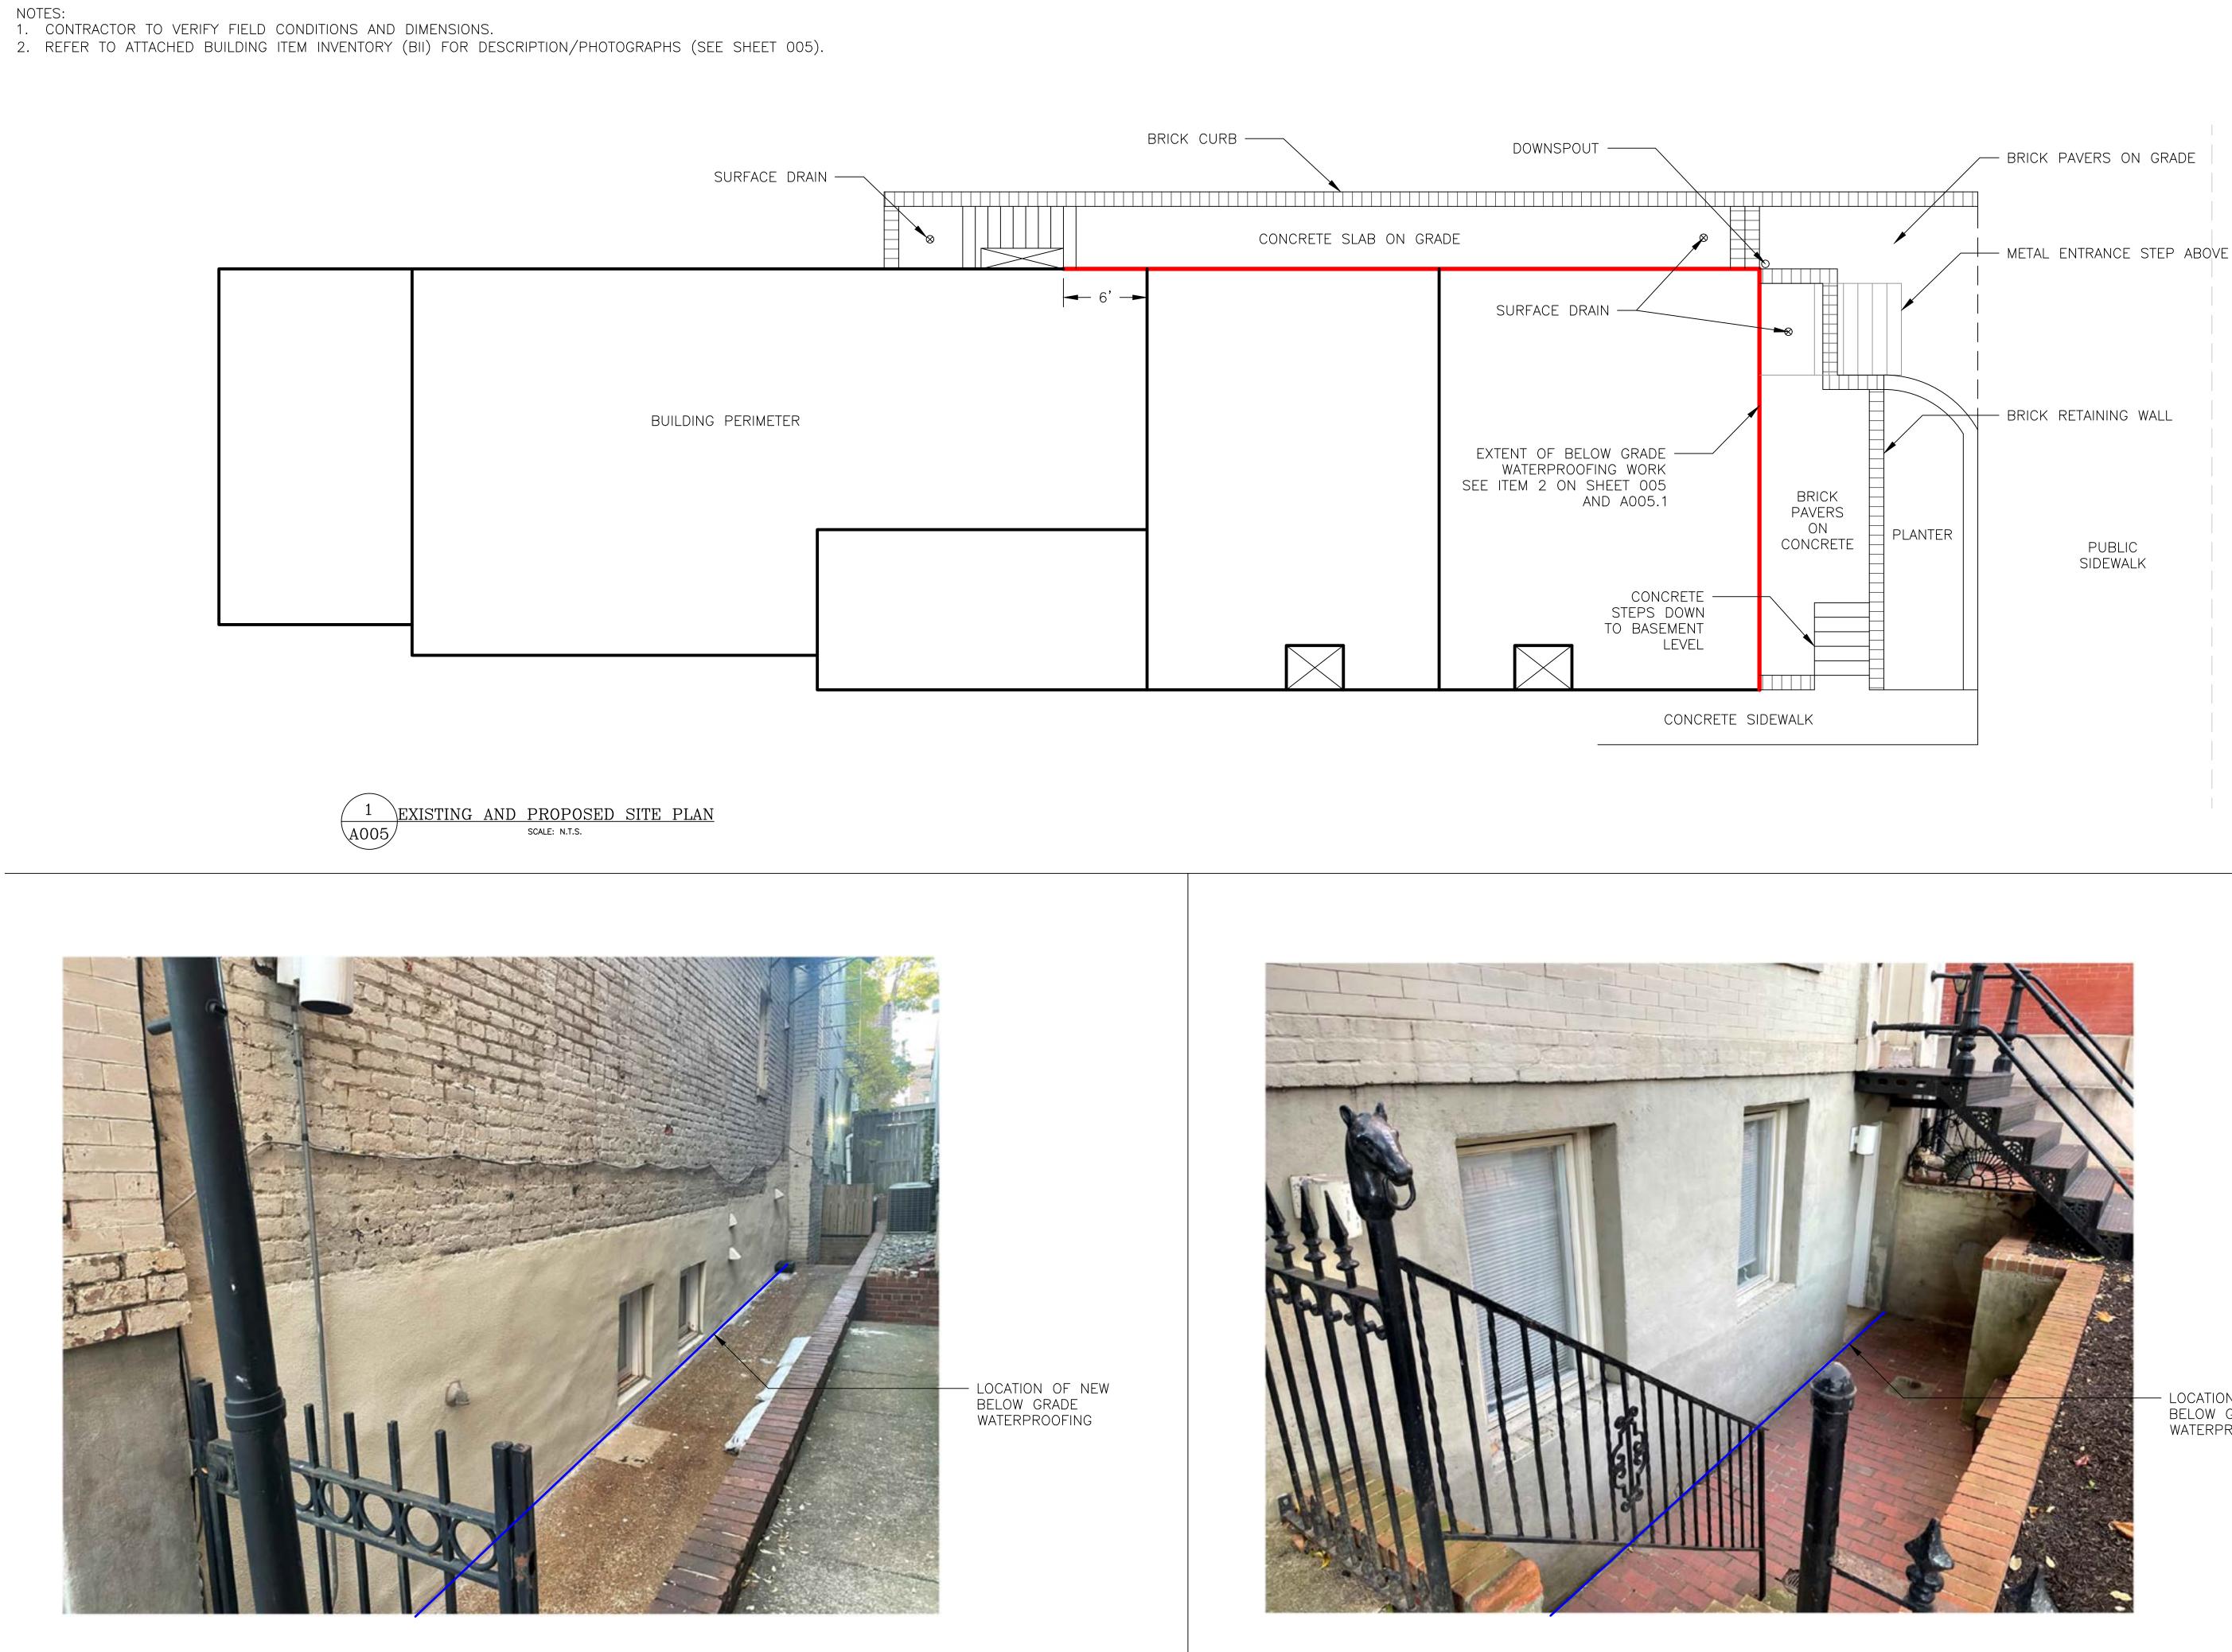





– LOCATION OF NEW BELOW GRADE WATERPROOFING

31ST

STREET NW

N

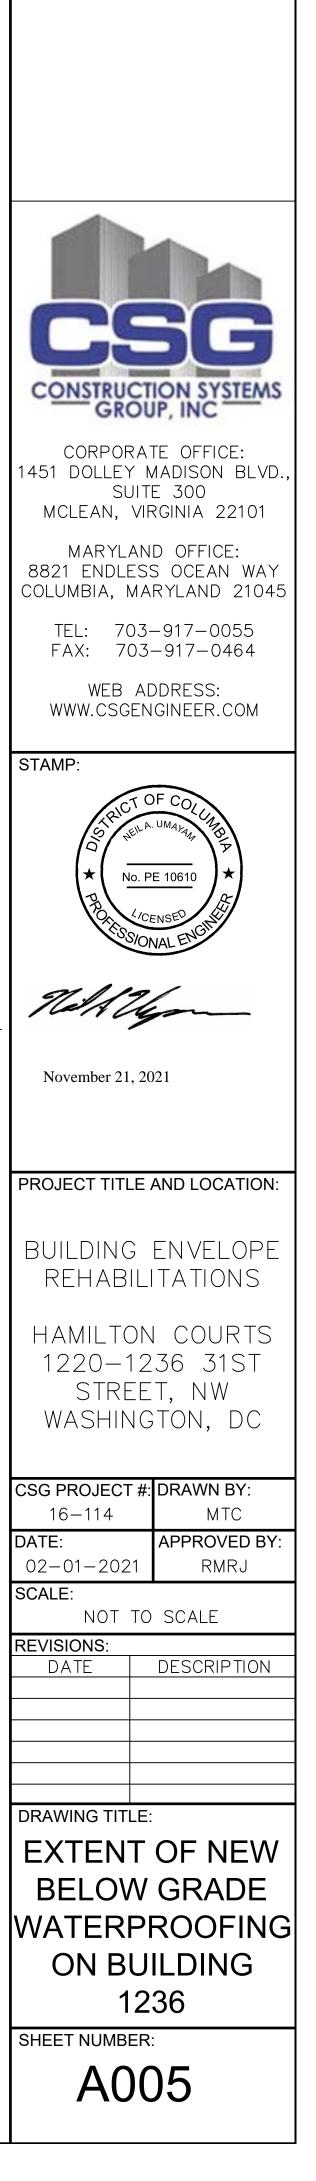

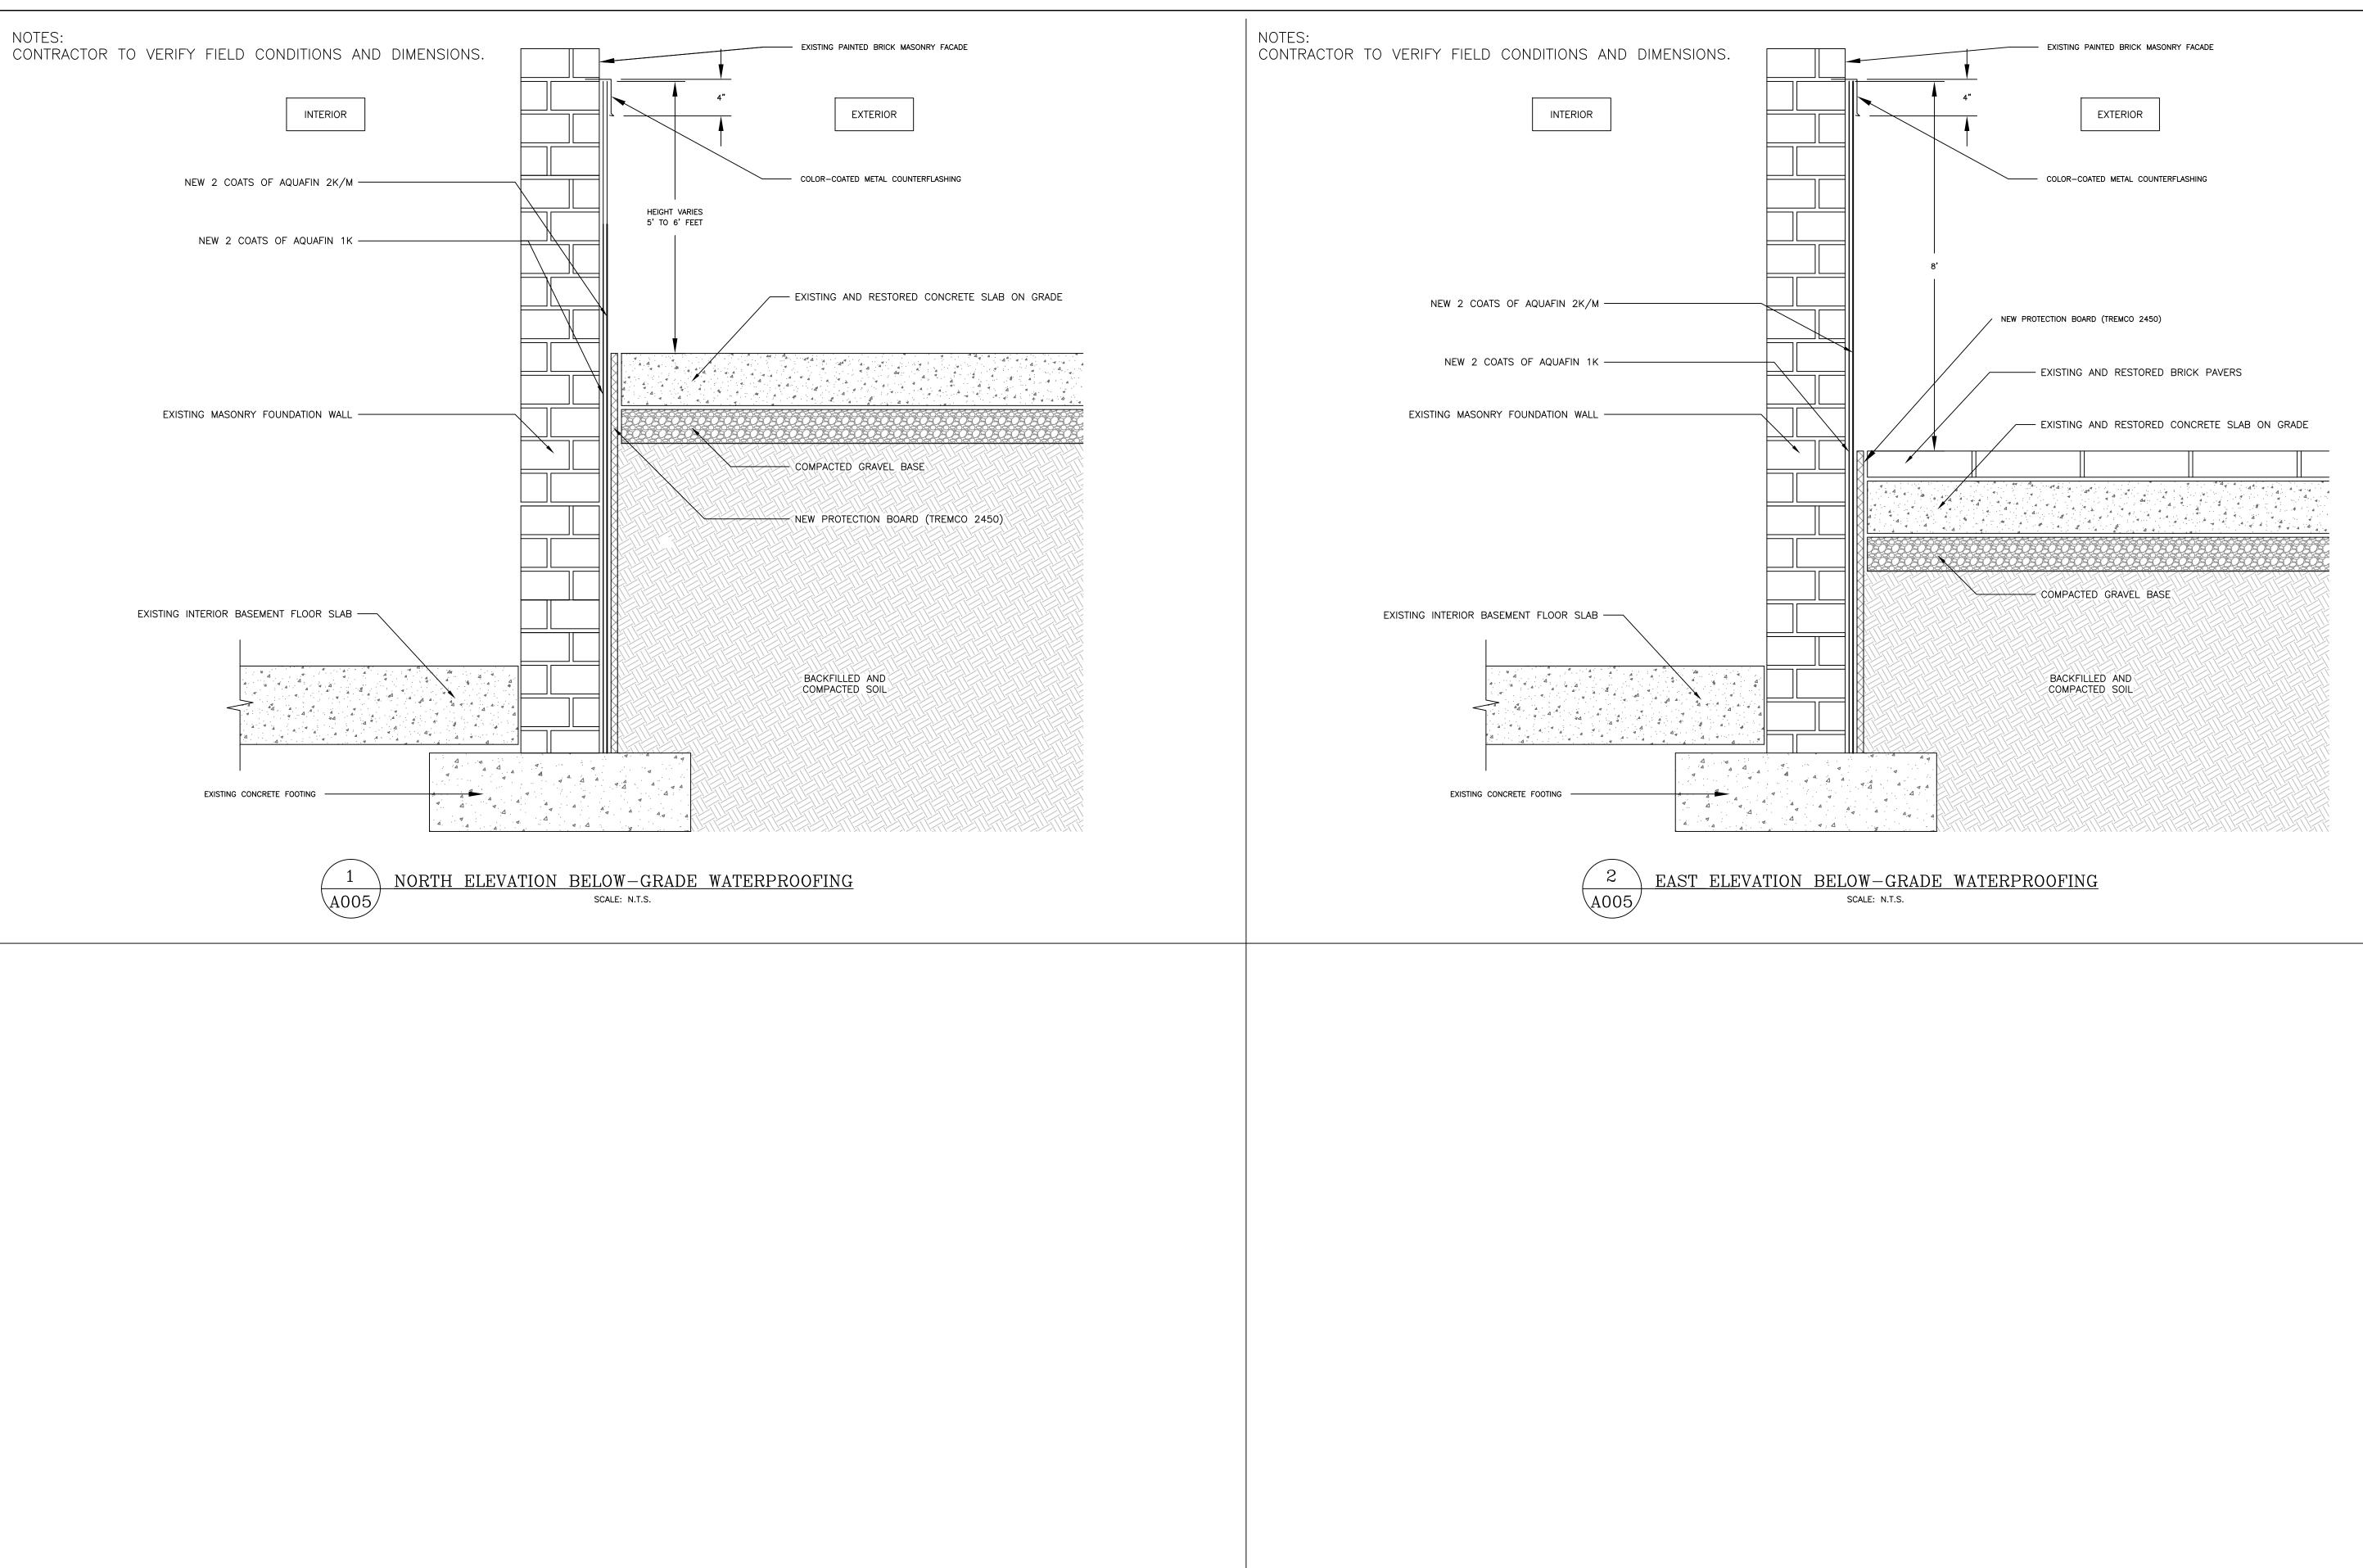

CONSTRUCTION SYSTEMS GROUP, INC	
CORPORATE OFFICE: 1451 DOLLEY MADISON BLVD., SUITE 300 MCLEAN, VIRGINIA 22101 MARYLAND OFFICE: 8821 ENDLESS OCEAN WAY COLUMBIA, MARYLAND 21045	
TEL: 703-917-0055 FAX: 703-917-0464 WEB ADDRESS: WWW.CSGENGINEER.COM	
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PROJECT TITLE AND LOCATION: BUILDING ENVELOPE REHABILITATIONS HAMILTON COURTS 1220–1236 31ST STREET, NW WASHINGTON, DC	
CSG PROJECT #:DRAWN BY:16-114MTCDATE:APPROVED BY:02-01-2021RMRJSCALE:NOT TO SCALEREVISIONS:DATEDESCRIPTION	
BELOW GRADE WATERPROOFING DETAILS	
SHEET NUMBER: A005.1	












EXISTING CONDITION CLOSEUP WITH MEASUREMENTS 6 SCALE: N.T.S.

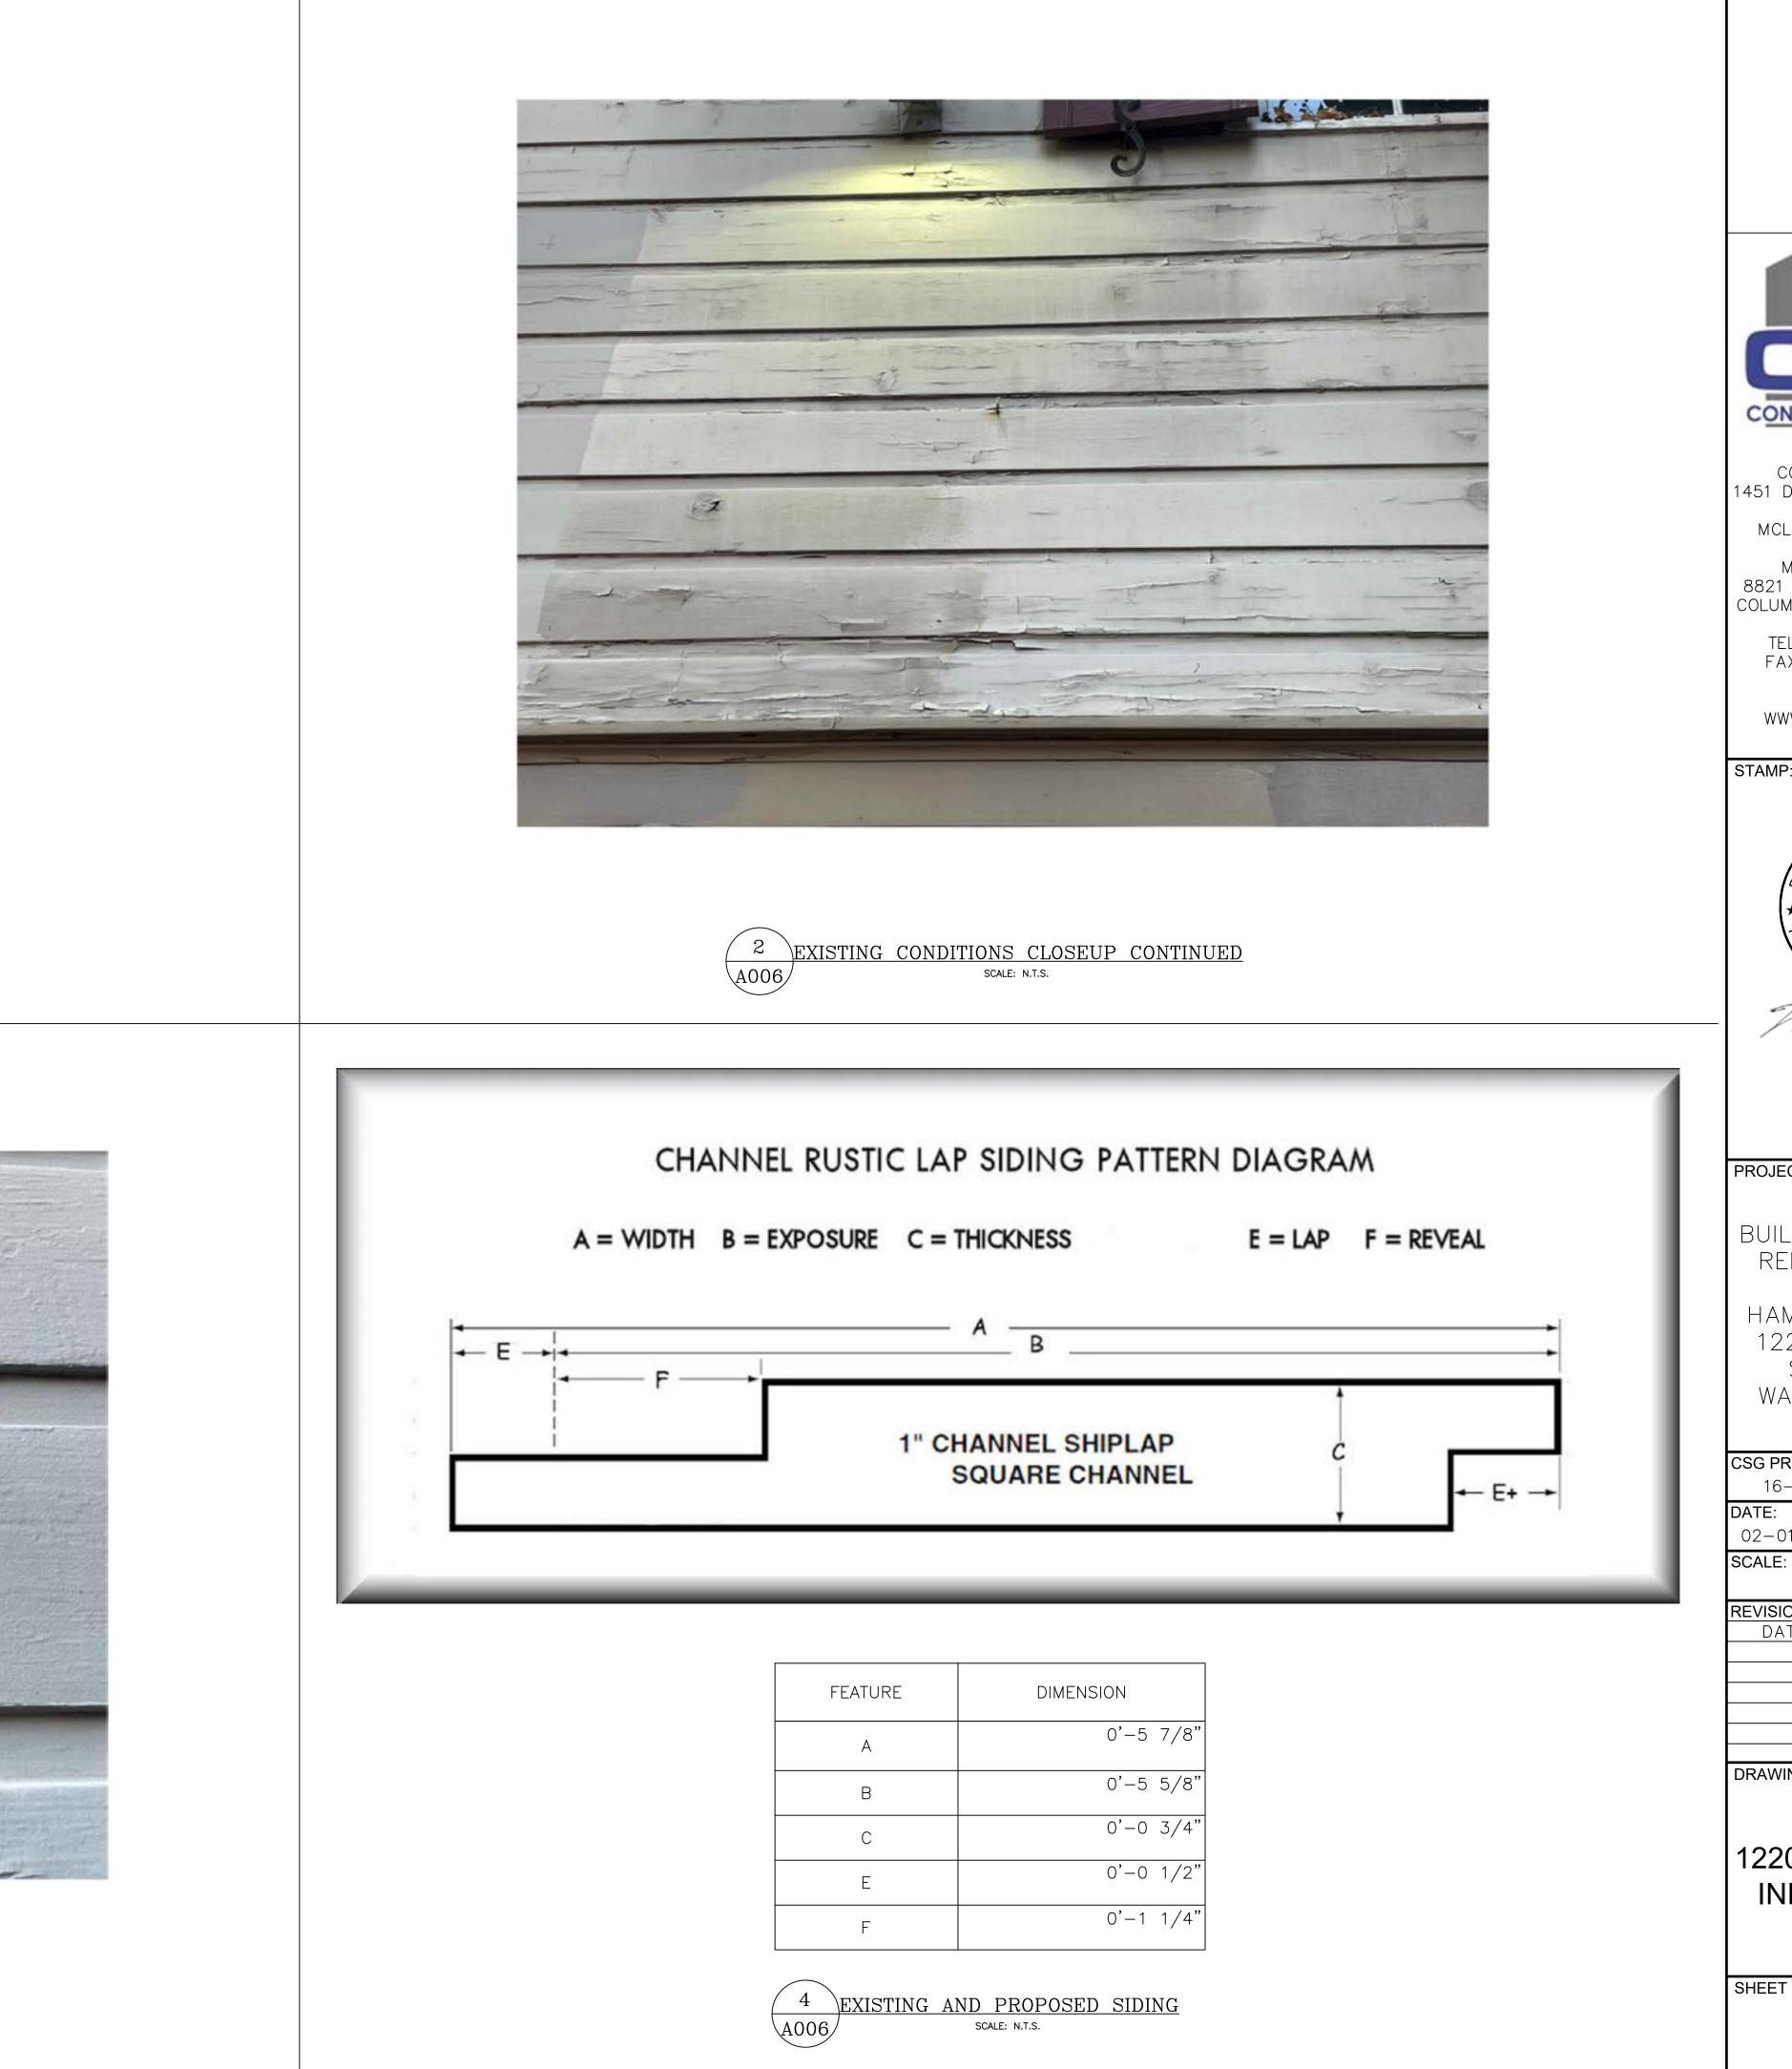

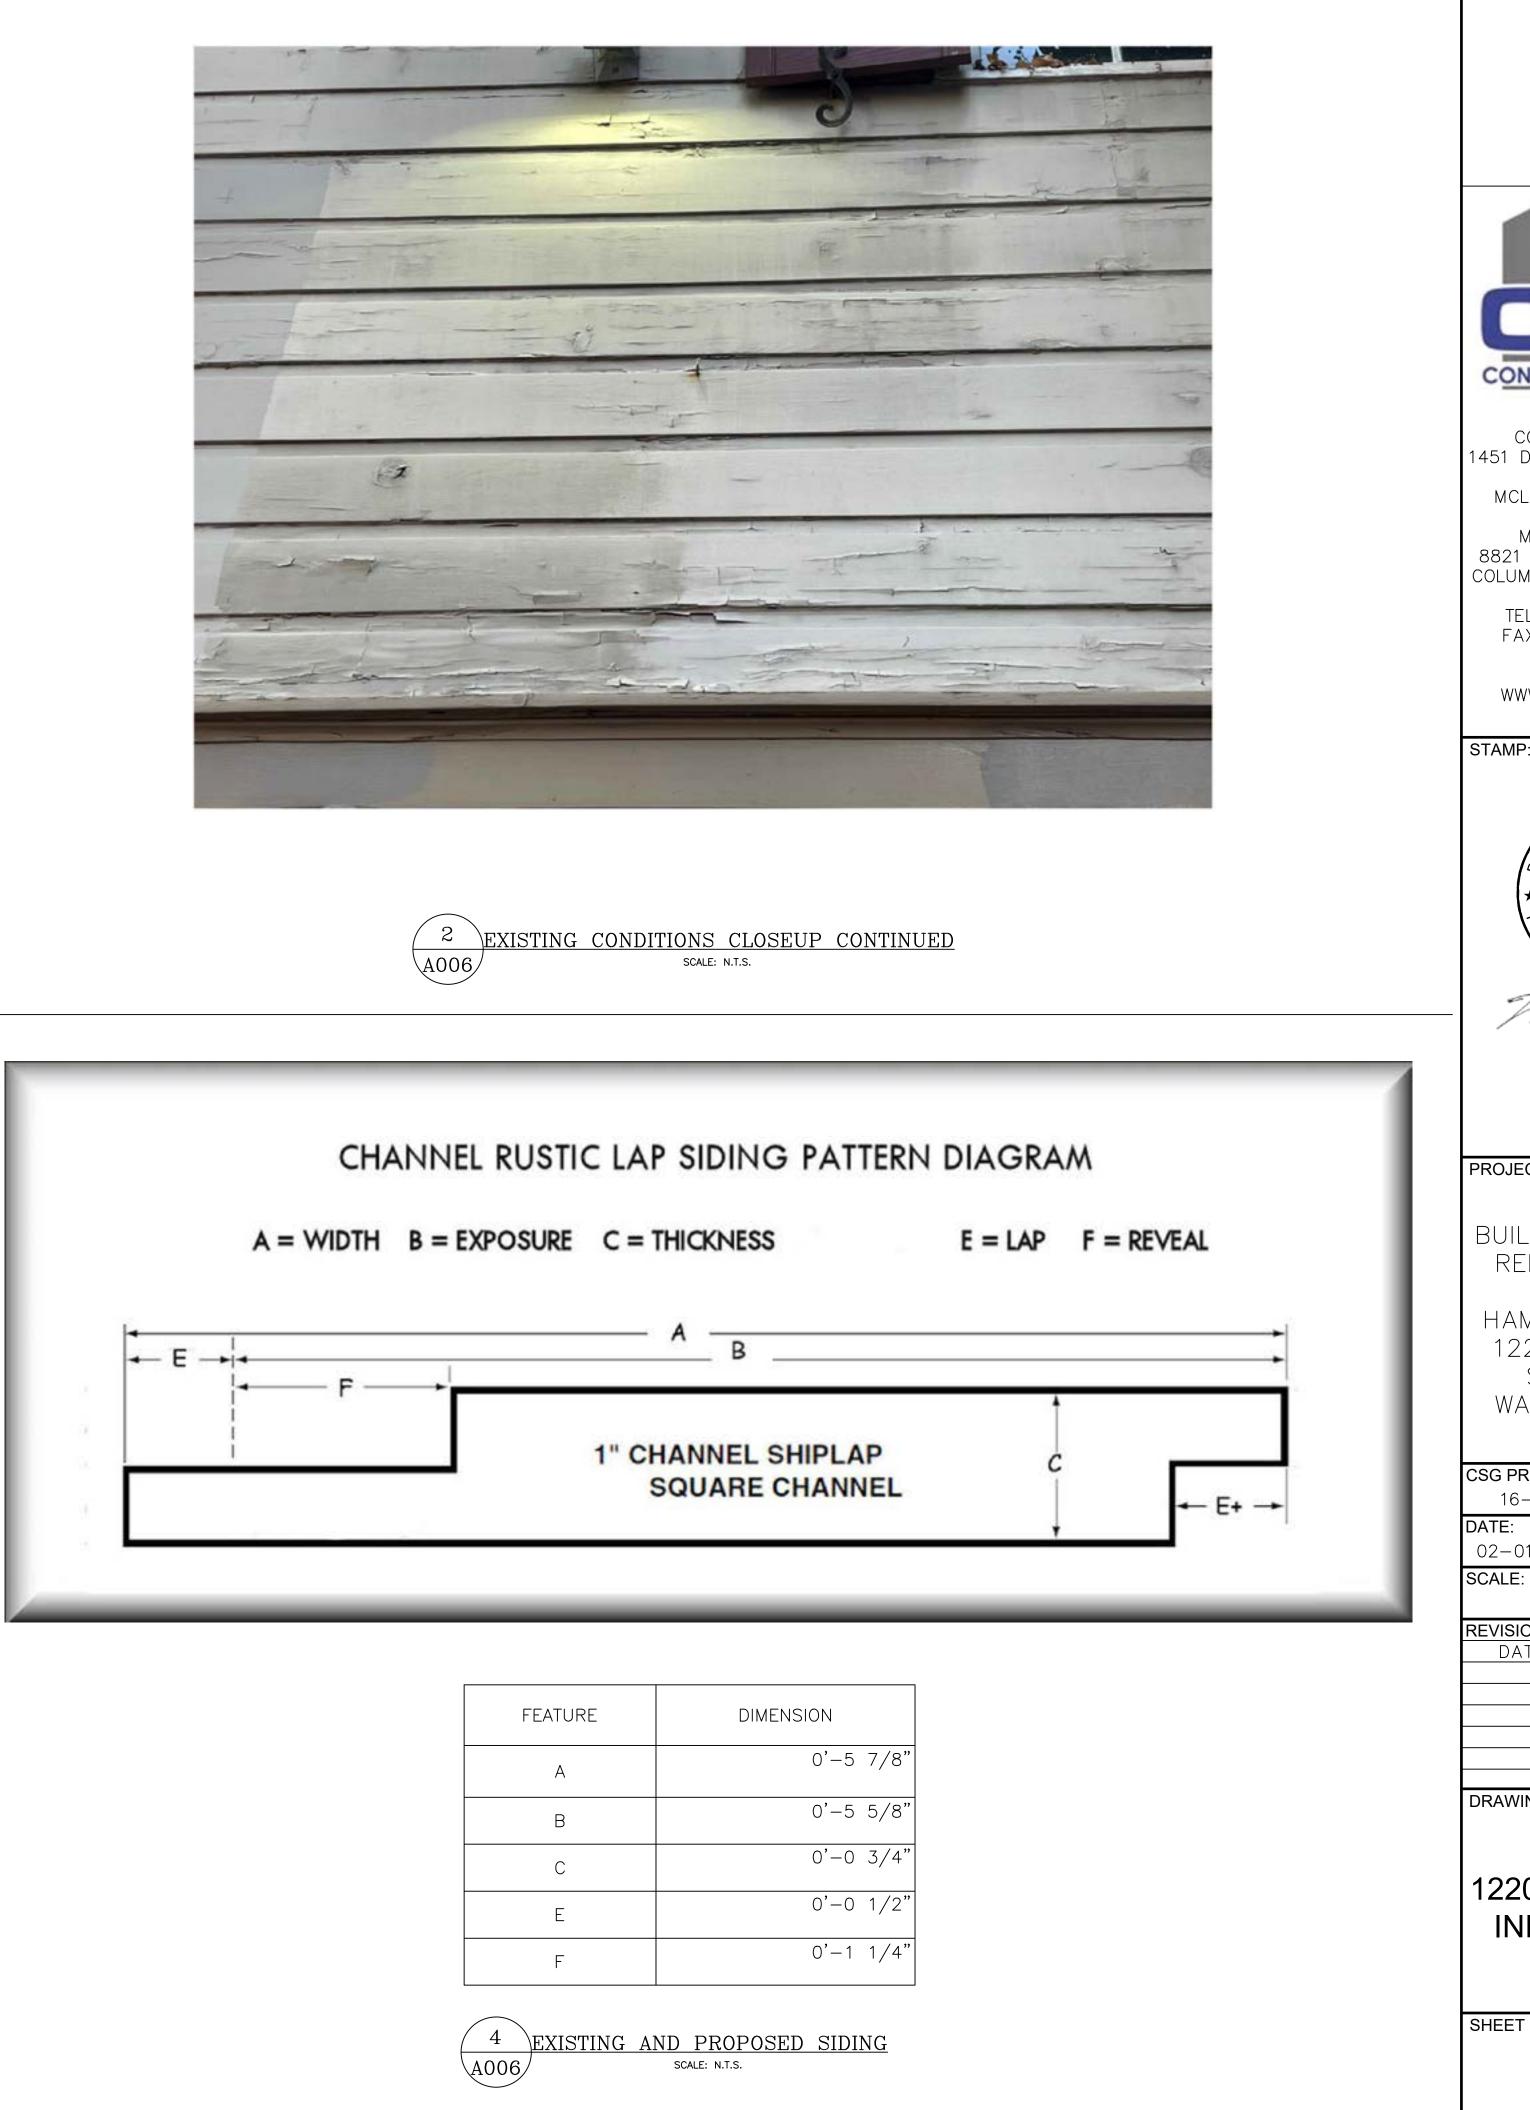

FEATURE	DIMEN
A	
В	
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E	
F	

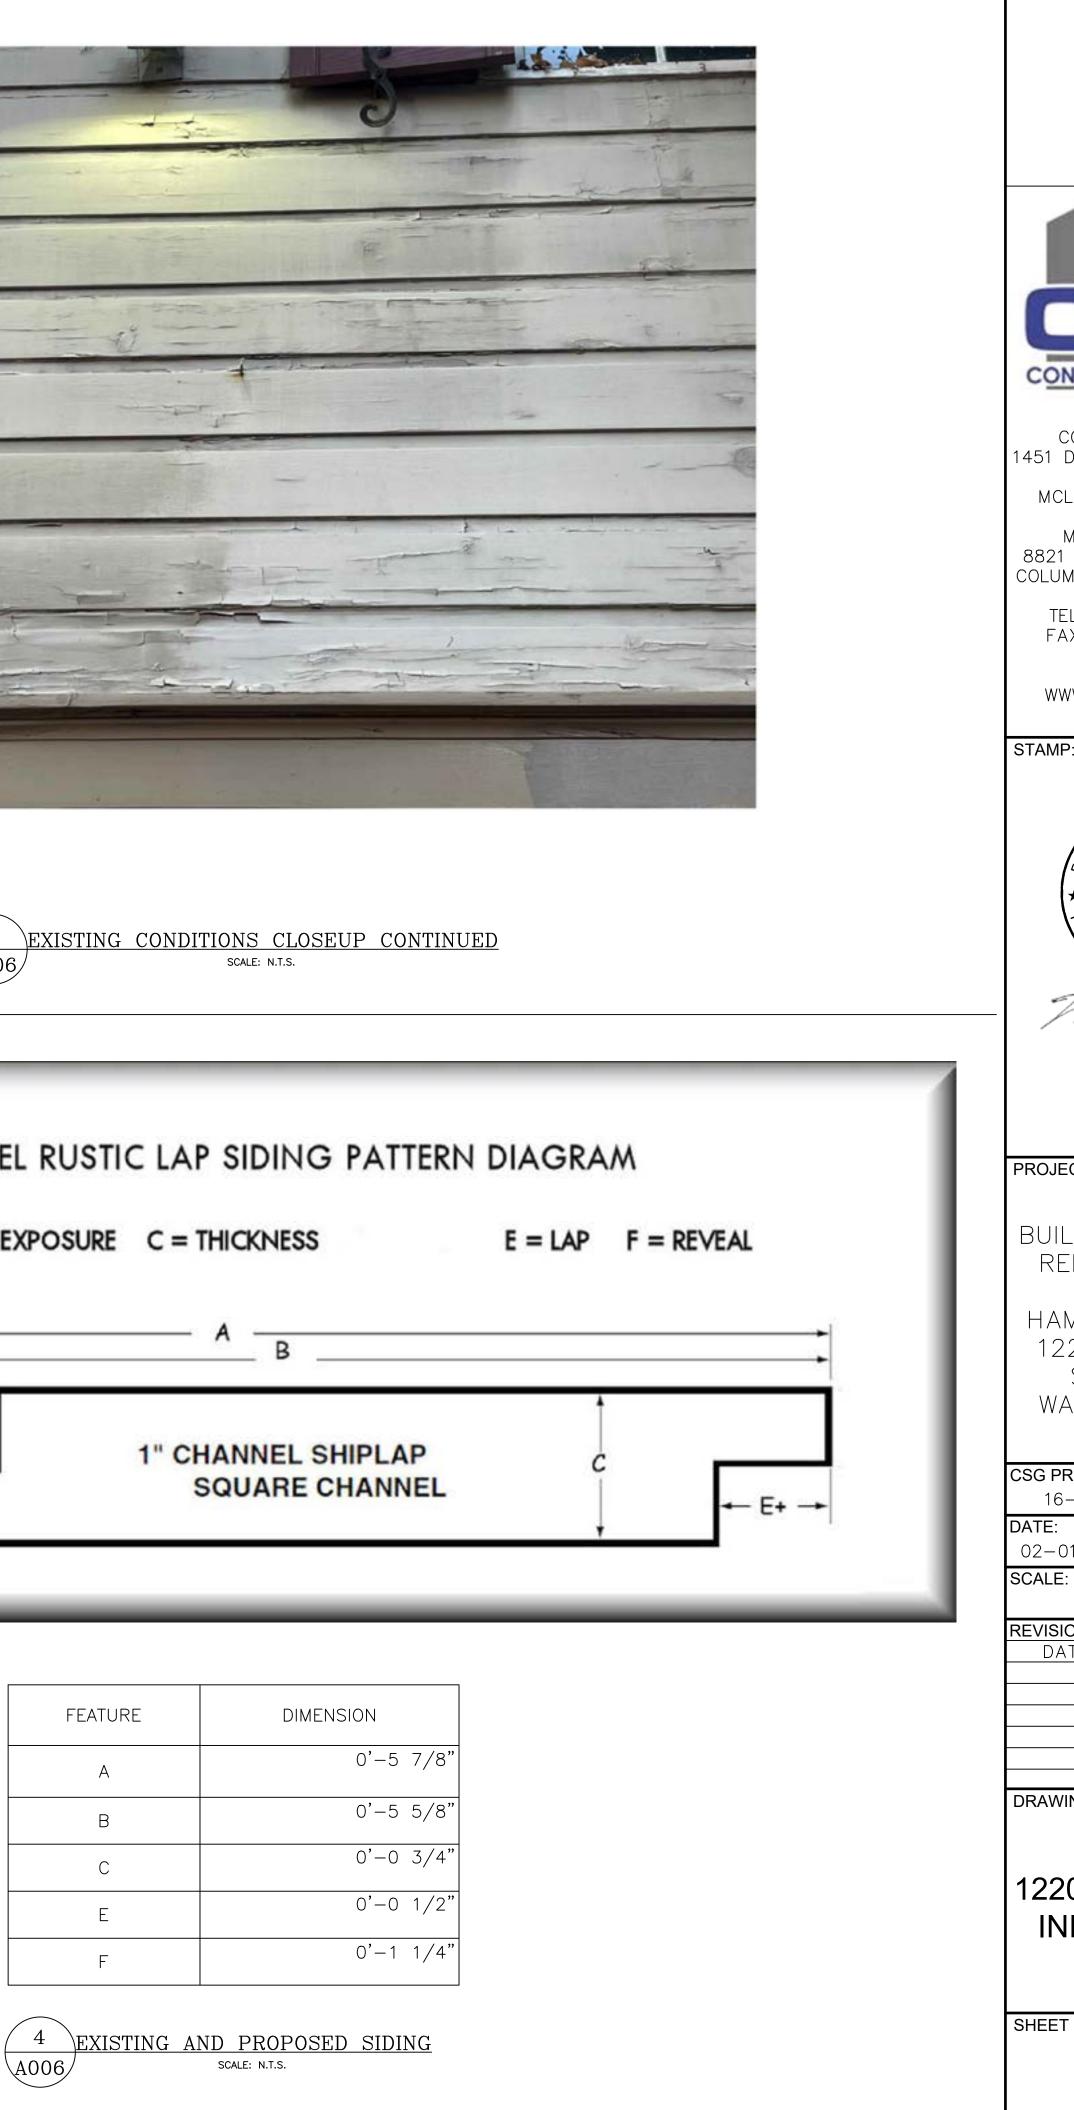

CSG
CONSTRUCTION SYSTEMS GROUP, INC
CORPORATE OFFICE: 1451 DOLLEY MADISON BLVD., SUITE 300
MCLEAN, VIRGINIA 22101 Maryland office:
8821 ENDLESS OCEAN WAY COLUMBIA, MARYLAND 21045
TEL: 703-917-0055 FAX: 703-917-0464
WEB ADDRESS: WWW.CSGENGINEER.COM
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11-18-2021
PROJECT TITLE AND LOCATION:
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BUILDING ENVELOPE REHABILITATIONS HAMILTON COURTS
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BUILDING ENVELOPE REHABILITATIONS HAMILTON COURTS 1220–1236 31ST STREET, NW WASHINGTON, DC CSG PROJECT # DRAWN BY: 16–114 MTC DATE: 02–01–2021 RMRJ SCALE:
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NOTE: "X" MARKS LOCATION OF WINDOWS AND JULIETTE BALCONY DOORS TO BE REPLACED.









2 BUILDING 1222 SCALE: N.T.S.

NOTE: "X" MARKS LOCATION OF WINDOWS AND JULIETTE BALCONY DOORS TO BE REPLACED.





4 BUILDING 1226 CONTINUED A004 SCALE: N.T.S. A004

CORPORATE OFFICE: CORPORATE OFFICE: 1451 DOLLEY MADISON BLVD., SUITE 300 MCLEAN, VIRGINIA 22101 MARYLAND OFFICE: 8821 ENDLESS OCEAN WAY COLUMBIA, MARYLAND 21045 TEL: 703–917–0055 FAX: 703–917–0464 WEB ADDRESS: WWW.CSGENGINEER.COM	
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PROJECT TITLE AND LOCATION:	
BUILDING ENVELOPE REHABILITATIONS	
HAMILTON COURTS 1220-1236 31ST STREET, NW WASHINGTON, DC	
CSG PROJECT #: DRAWN BY: 16-114 MTC	
DATE: APPROVED BY: 02-01-2021 RMRJ	
SCALE: NOT TO SCALE	
REVISIONS: DATE DESCRIPTION	
DRAWING TITLE:	
1220-1226 WINDOW REPLACEMENT	
SHEET NUMBER: A007	

NOTE: OUTLINED AREAS ARE LOCATIONS WHERE EXTERIOR WYTHE WILL BE REMOVED, SALVAGED AND REINSTALLED WITH TYPE N PORTLAND CEMENT/LIME/SAND MORTAR.






NOTE:


 3
 VIEW OF BOTH CHIMNEYS FROM THE GROUND


 A008
 SCALE: N.T.S.

NOTE: OUTLINED AREAS ARE LOCATIONS WHERE EXTERIOR WYTHE WILL BE REMOVED, SALVAGED AND REINSTALLED WITH TYPE N PORTLAND CEMENT/LIME/SAND MORTAR.

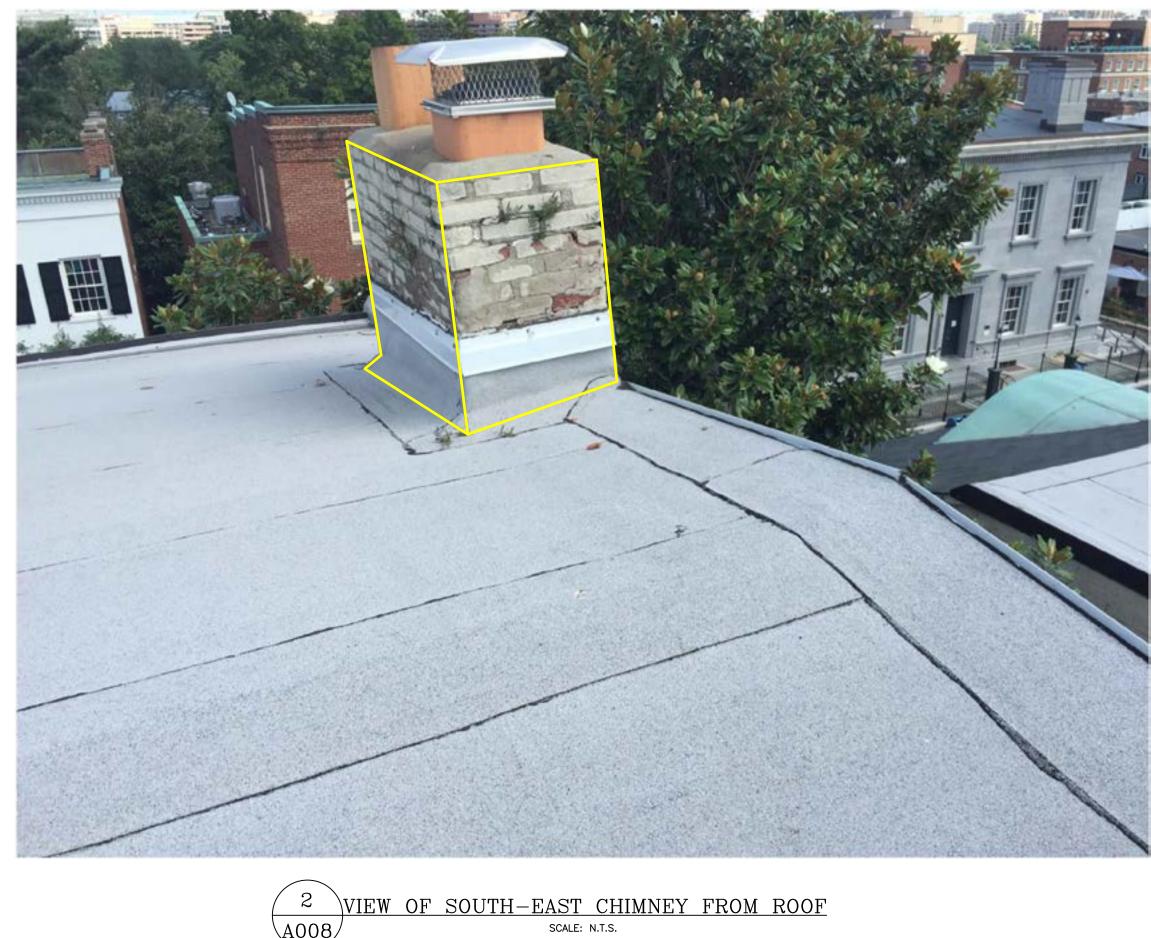

NOTE: HATCHED AREAS ARE LOCATIONS WHERE EXTERIOR BRICK WYTHE WILL BE REMOVED, SALVAGED AND REINSTALLED WITH TYPE N PORTLAND CEMENT/LIME/SAND MORTAR.

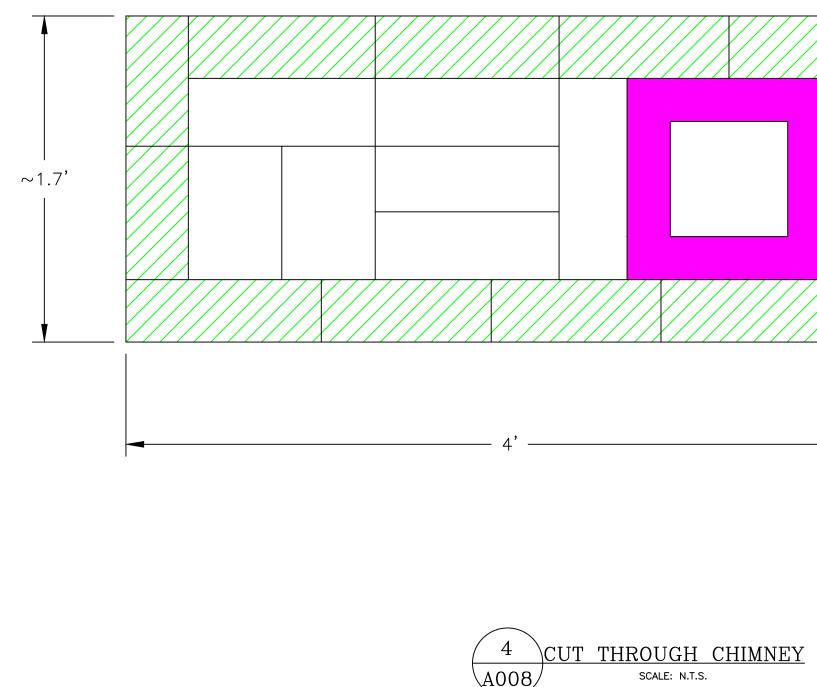

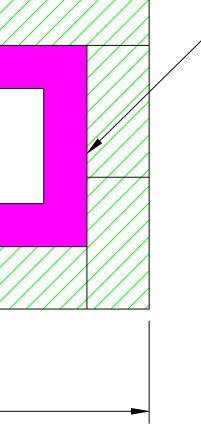

– EXISTING TERRACOTTA FLUE TO REMAIN

CSG	
CONSTRUCTION SYSTEMS	
GROUP, INC	
CORPORATE OFFICE: 1451 DOLLEY MADISON BLVD.,	
SUITE 300 MCLEAN, VIRGINIA 22101	
MARYLAND OFFICE: 8821 ENDLESS OCEAN WAY	
COLUMBIA, MARYLAND 21045	
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11-18-2021	
PROJECT TITLE AND LOCATION:	
BUILDING ENVELOPE REHABILITATIONS	
HAMILTON COURTS 1220-1236 31ST	
STREET, NW WASHINGTON, DC	
WASHINGTON, DC	
CSG PROJECT #: DRAWN BY:	
16-114MTCDATE:APPROVED BY:	
02-01-2021 RMRJ SCALE:	
NOT TO SCALE	
REVISIONS: DATE DESCRIPTION	
DRAWING TITLE:	
1236 CHIMNEY	
A008	