


## **SCOPE OF WORK:**

- 1) NEW CURVED TOP DORMERS ON SOUTH ELEVATION
- 2) NEW SINGLE 3' MULTI-LITE FRONT DOOR
- 3) NEW SHED DORMER ON NORTH ELEVATION
- 4) REPLACE REAR SECOND FLOOR WINDOWS WITH CASEMENT WINDOWS IN SAME MASONRY OPENING
- 5) NEW SKYLIGHT IN OUTDOOR ATRIUM
- 6) EXTEND PORTIONS OF ATRIUM WALLS UPWARDS TO SERVE NEW THIRD FLOOR
- 7) INTERIOR RENOVATION
- 8) INSTALL NEW RAIN CANOPY OVER FRONT DOOR

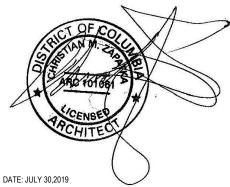

Architect Attestation Statement

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PROJECT DESIGNED TO THE FOLLOWING CODES:

DISTRICT OF COLUMBIA CONSTRUCTION CODES SUPPLEMENT OF 2013
2012 IRC - INTERNATIONAL RESIDENTIAL CODE, AMENDED BY RESIDENTIAL
CODE SUPPLEMENT OF 2013

2010 NFPA 13D - SPRINKLER SYSTEMS IN ONE AND TWO FAMILY DWELLINGS 2012 INTERNATIONAL ENERGY CONSERVATION CODE, AMENDED BY ENERGY CONSERVATION CODE SUPPLEMENT OF 2013

ALL DRAWINGS TO COMPLY WITH IECC IN ACCORDANCE WITH BUILDING CODE SUPPLEMENT OF 2013

2011 National Electric Code (NEC)



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A102 EXISTING ATTIC AND PROPOSED THIRD FLOOR PLANS

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P001 PLUMBING RISERS

P002 PLUMBING RISERS

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PROJECT:

KASSUM RESIDENCE 3045 WEST LANE KEYS, NW WASHINGTON, DC 20007 SQ: 1269 LOT:0350

DRAWING TITLE:

COVER SHEET



SUBMISSION:

PERMIT

DATE: MAY 14, 2020


SCALE: NTS = 1'-0"

0000








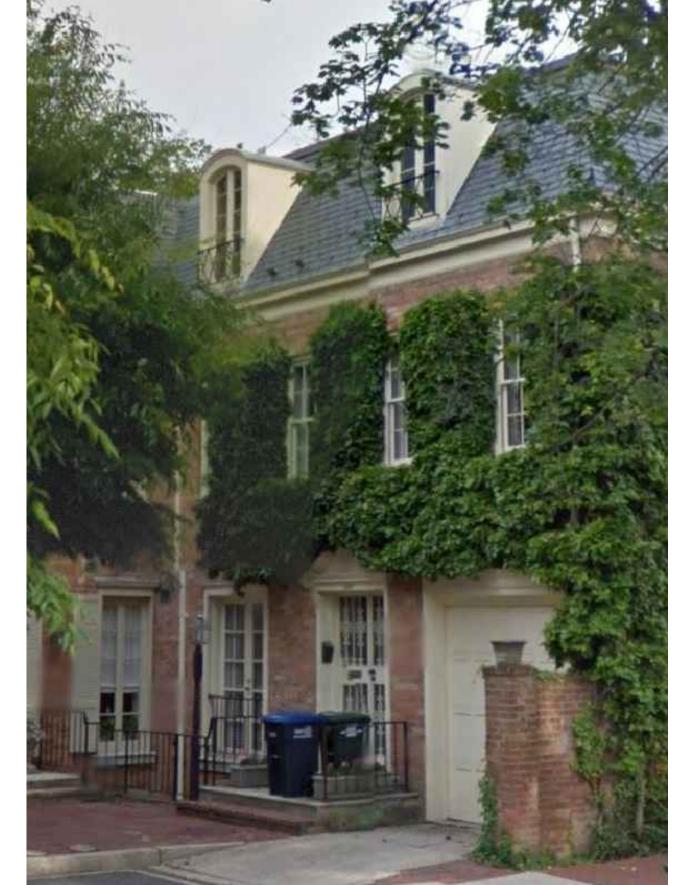


3 DORMERS OF NEIGHBORING HOUSES

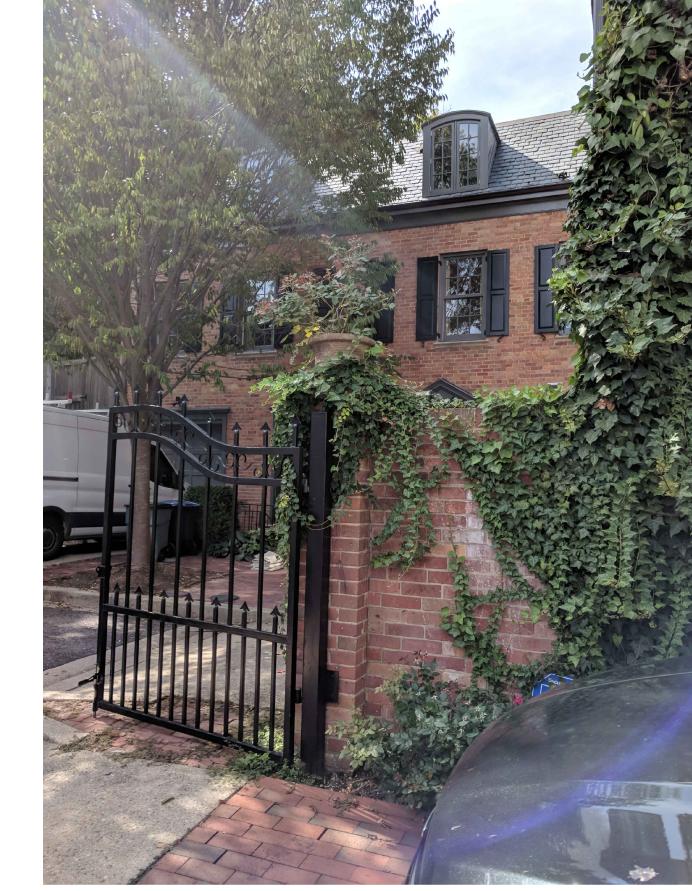




NORTH (REAR )VIEW

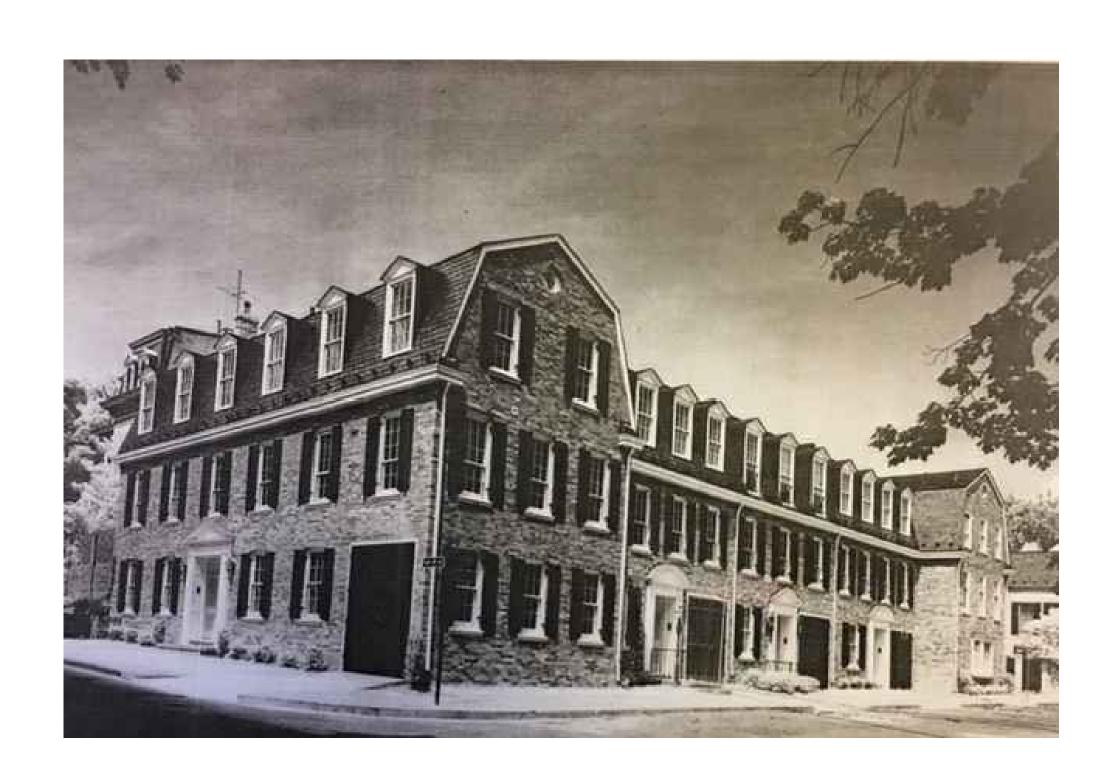



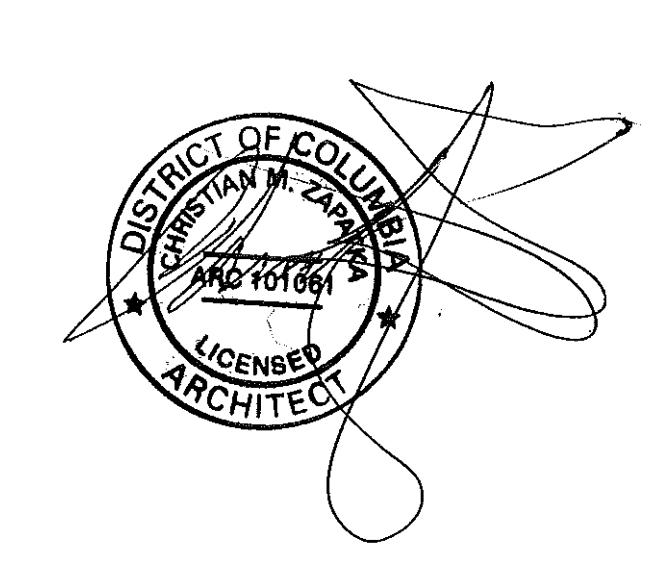

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PROJECT:

KASSUM
RESIDENCE
3045 WEST LANE KEYS,

RESIDENCE 3045 WEST LANE KEYS, NW WASHINGTON, DC 20007 SQ: 1269 LOT: 0350

PHOTO SHEET


DRAWING TITLE:

SUBMISSION:

PERMIT

DATE: MAY 14, 2020 SCALE: NA = 1'-0"

0002

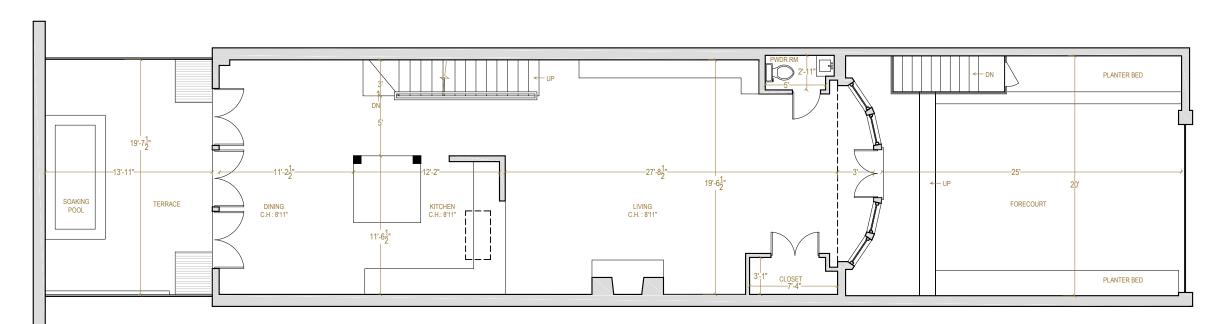

DATE: JULY 30, 2019

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KASSUM RESIDENCE 3045 WEST LANE KEYS, NW WASHINGTON, DC 20007

SQ: 1269 LOT: 0350

DRAWING TITLE:

CHRISTIAN ZAPATKA ARCHITECT, PLLC 1656 33rd STREET NW WASHINGTON DC 20007 202 333 2735


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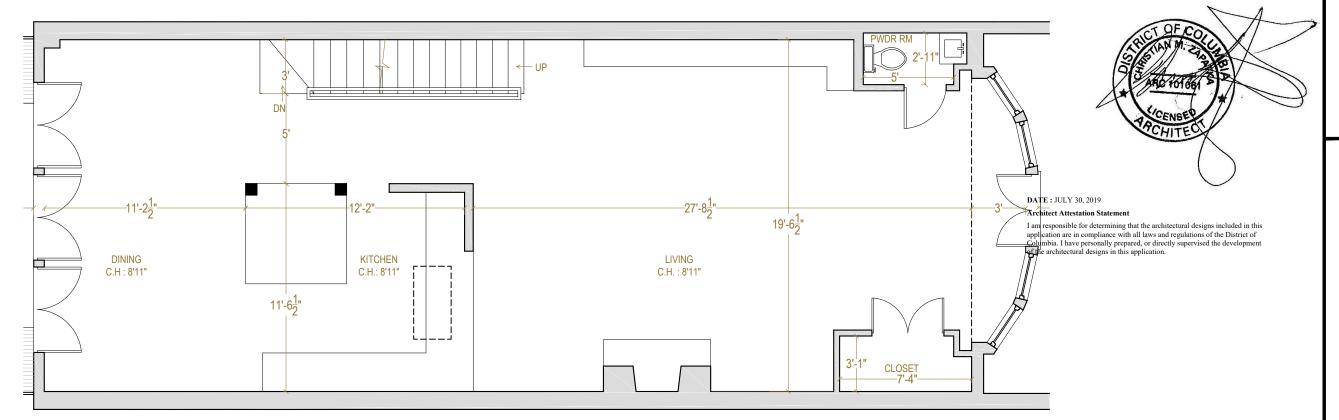
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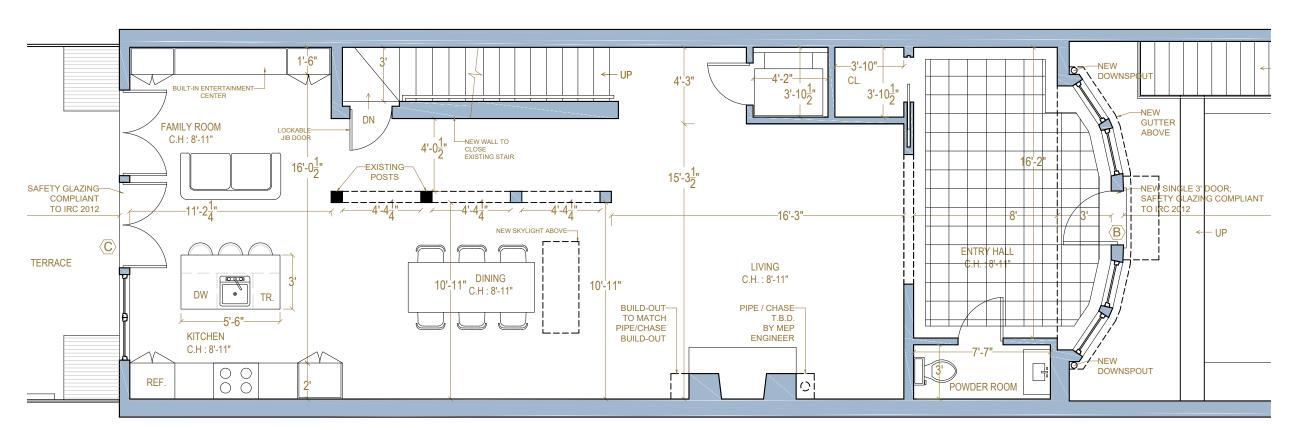
**EXISTING AND** PROPOSED SITE PLANS

SUBMISSION:

DATE: MAY 14, 2020 SCALE: 1/8" = 1'-0"





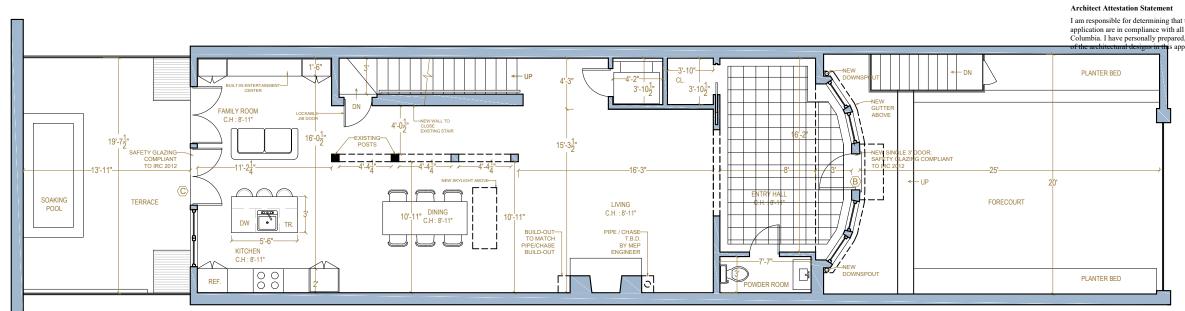

CHRISTIAN ZAPATKA ARCHITECT, PLLC 1656 33rd STREET NW WASHINGTON DC 20007 202 333 2735 PROJECT: KASSUM RESIDENCE 3045 WEST LANE KEYS, NW WASHINGTON, DC 20007 SQ: 1269 LOT: 0350

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DRAWING TITLE:

**EXISTING AND** PROPOSED FIRST FLOOR PLANS


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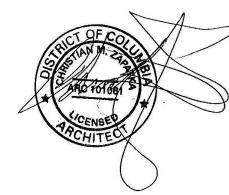
PERMIT

DATE: MAY 14, 2020 SCALE: 3/16" = 1'-0"

A100

PROPOSED



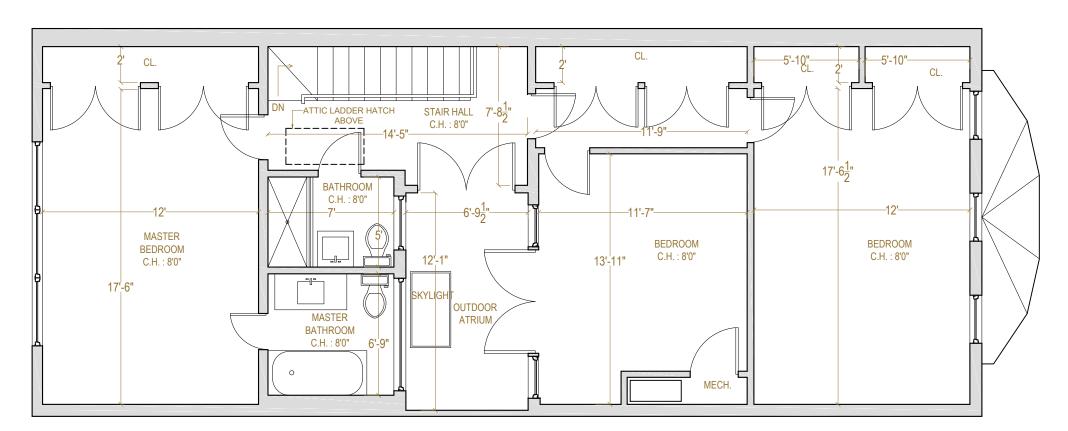

PROPOSED

\_\_\_\_\_

DRAWING TITLE:

CHRISTIAN ZAPATKA ARCHITECT, PLLC 1656 33rd STREET NW WASHINGTON DC 20007 202 333 2735

PROJECT:

KASSUM RESIDENCE

3045 WEST LANE KEYS, NW WASHINGTON, DC 20007

SQ: 1269 LOT: 0350

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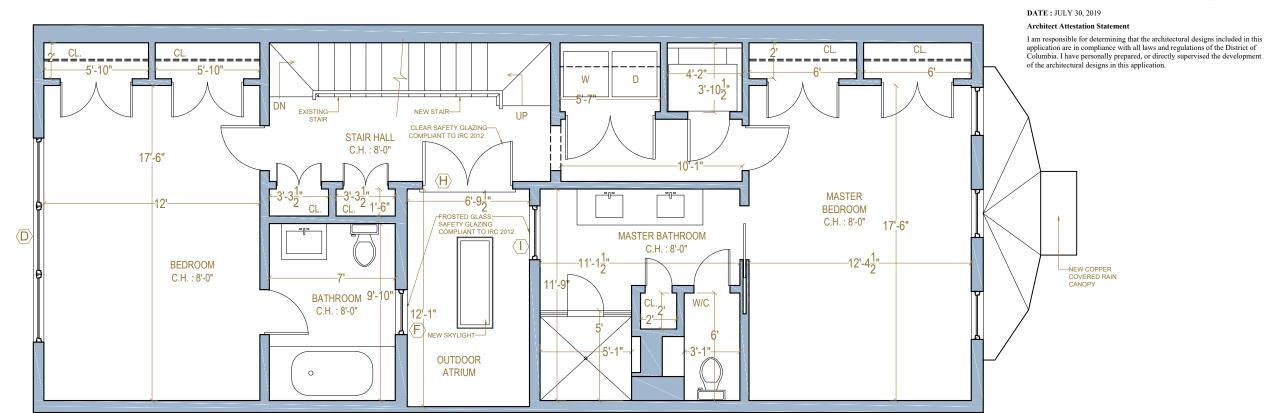
EXISTING AND PROPOSED SECOND FLOOR PLANS


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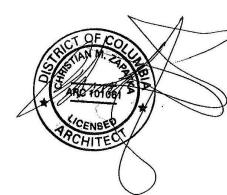
PERM

DATE: MAY 14, 2020

SCALE: 3/16" = 1'-0"





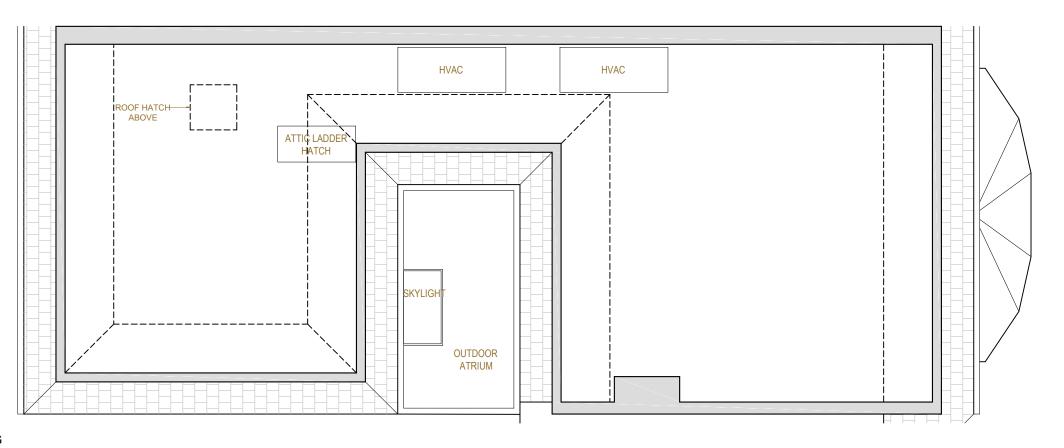

KASSUM RESIDENCE

3045 WEST LANE KEYS, NW WASHINGTON, DC 20007

SQ: 1269 LOT: 0350

DRAWING TITLE:

CHRISTIAN ZAPATKA ARCHITECT, PLLC 1656 33rd STREET NW WASHINGTON DC 20007 202 333 2735

PROJECT:


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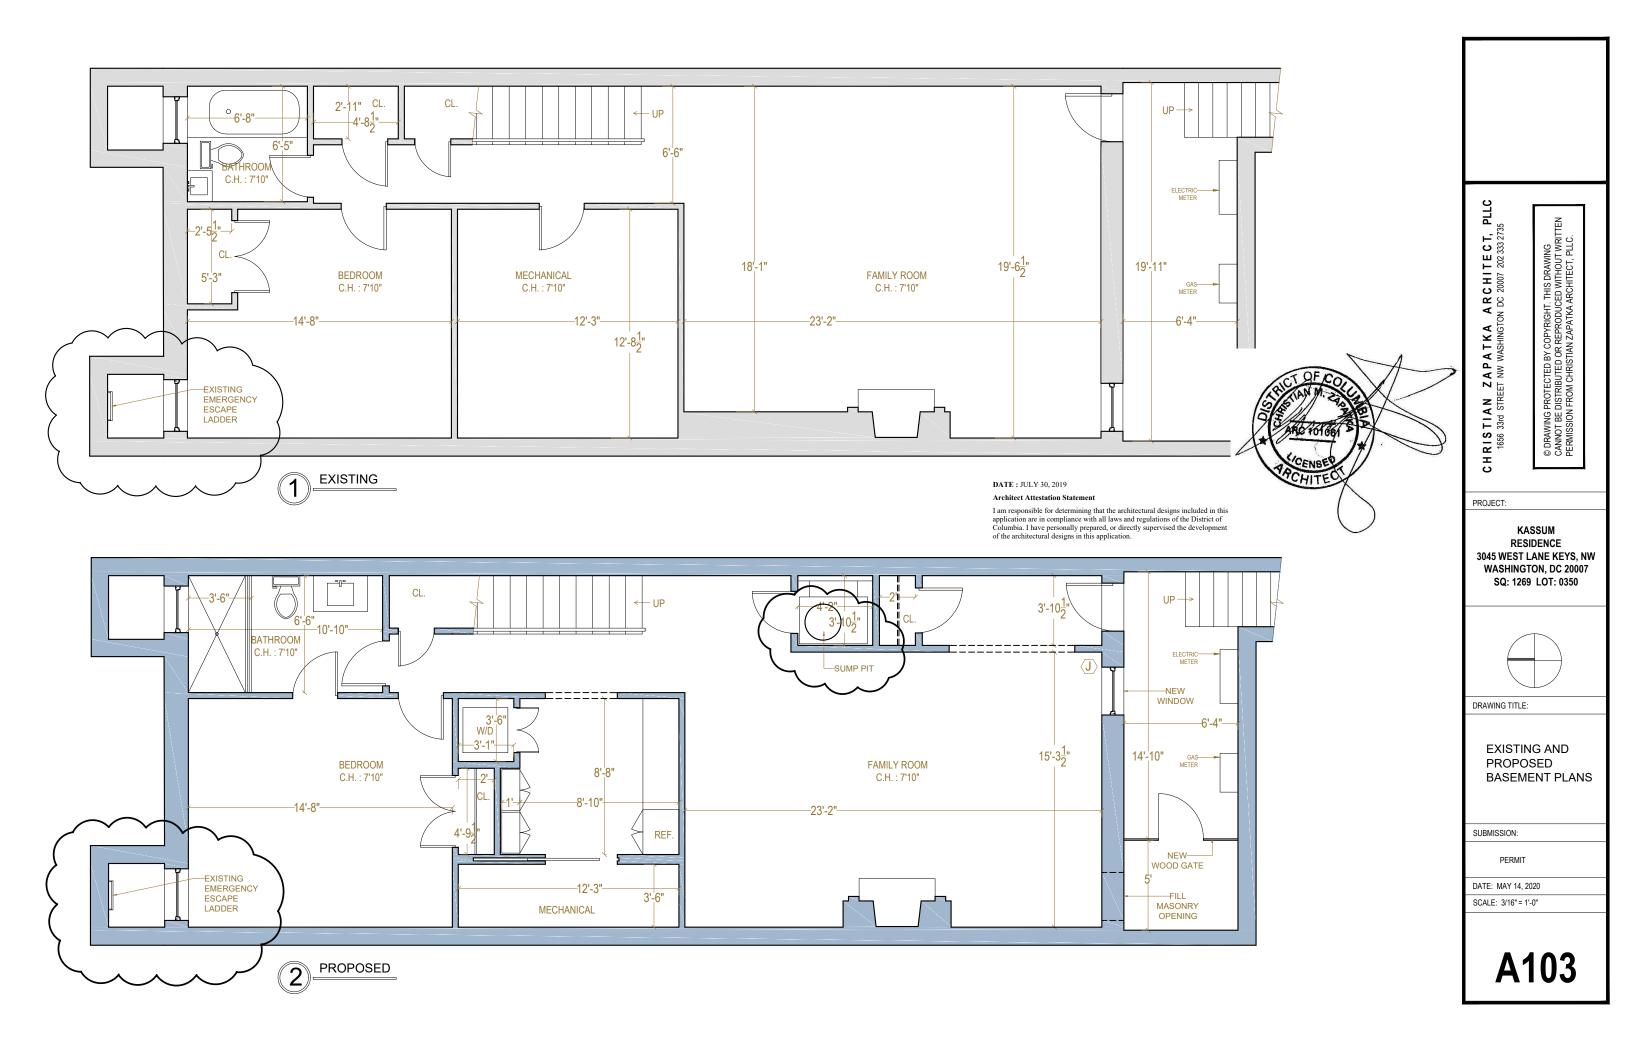
**EXISTING ATTIC** AND PROPOSED THIRD FLOOR **PLANS** 

SUBMISSION:


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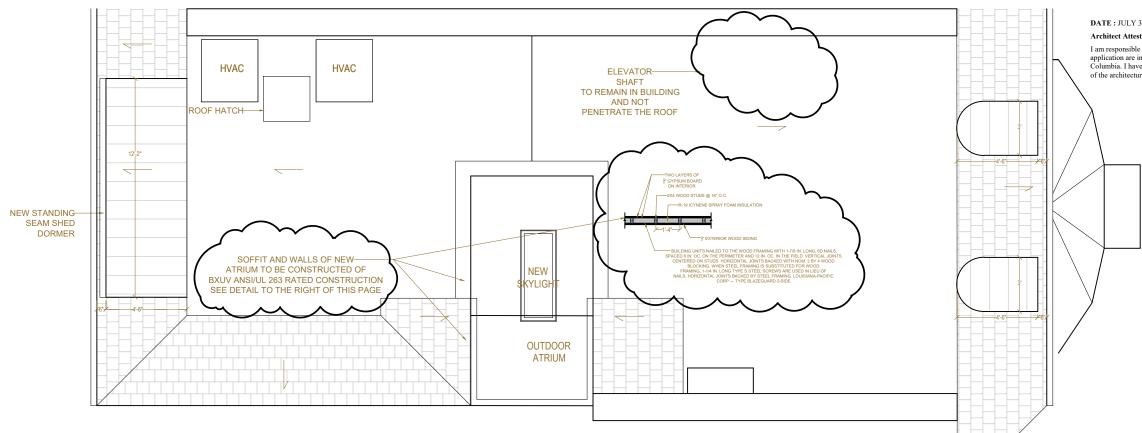
SCALE: 3/16" = 1'-0"





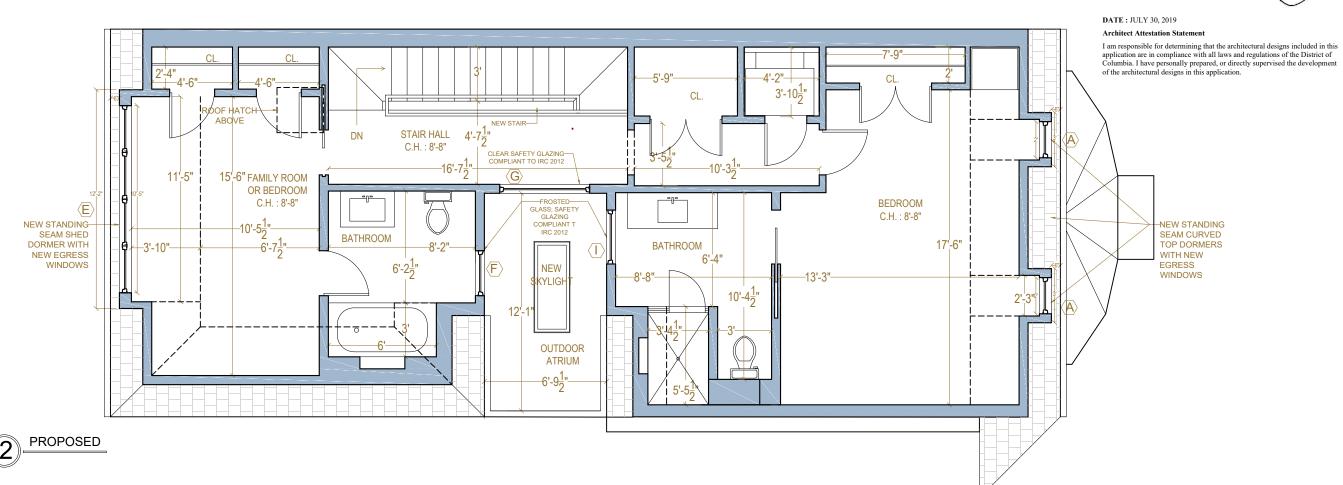



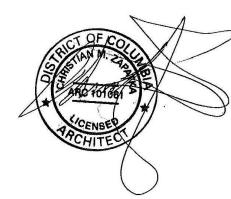

DATE: JULY 30, 2019


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PROJECT:

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KASSUM RESIDENCE 3045 WEST LANE KEYS, NW WASHINGTON, DC 20007 SQ: 1269 LOT: 0350



DRAWING TITLE:

**EXISTING AND** PROPOSED **ROOF PLANS** 

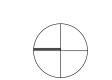SUBMISSION:

DATE: MAY 14, 2020

SCALE: 3/16" = 1'-0"



CHRISTIAN ZAPATKA ARCHITECT, PLLC 1656 33rd STREET NW WASHINGTON DC 20007 202 333 2735

PROJECT:

KASSUM RESIDENCE 3045 WEST LANE KEYS, NW WASHINGTON, DC 20007 SQ: 1269 LOT: 0350

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DRAWING TITLE:

**EXISTING AND** NEWLY PROPOSED SOUTH **ELEVATIONS** 

SUBMISSION:


DATE: MAY 4, 2020

SCALE: 1/4" = 1'-0"

**A200** 

PROPOSED SOUTH ELEVATION



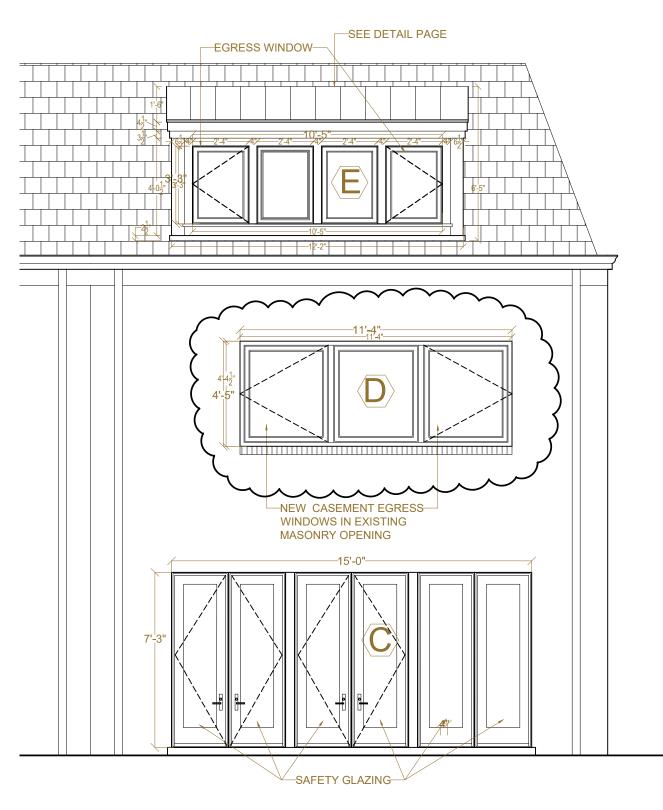

CHRISTIAN ZAPATKA ARCHITECT, PLLC 1656 33rd STREET NW WASHINGTON DC 20007 202 333 2735

PROJECT:

KASSUM RESIDENCE 3045 WEST LANE KEYS, NW WASHINGTON, DC 20007 SQ: 1269 LOT: 0350

DRAWING TITLE:

**EXISTING AND** NEWLY PROPOSED NORTH **ELEVATIONS** 

SUBMISSION:

DATE: MAY 4, 2020 SCALE: 1/4" = 1'-0"


A201

**EXISTING NORTH ELEVATION** 


PROPOSED NORTH ELEVATION



EXISTING EGRESS WINDOW AND LADDER

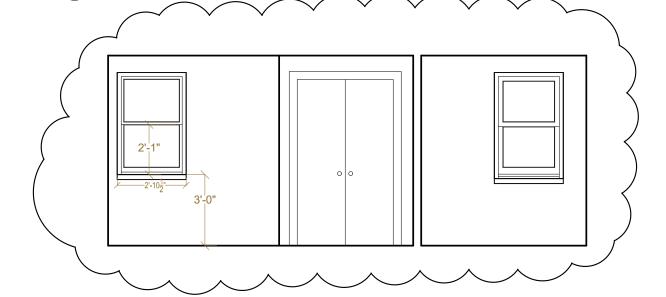


EXISTING NORTH BASEMENT ELEVATION

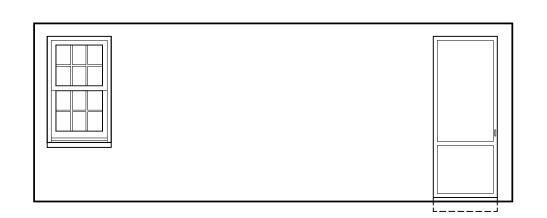


DATE: JULY 30, 2019 Architect Attestation Statement

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PROPOSED NORTH BASEMENT ELEVATION

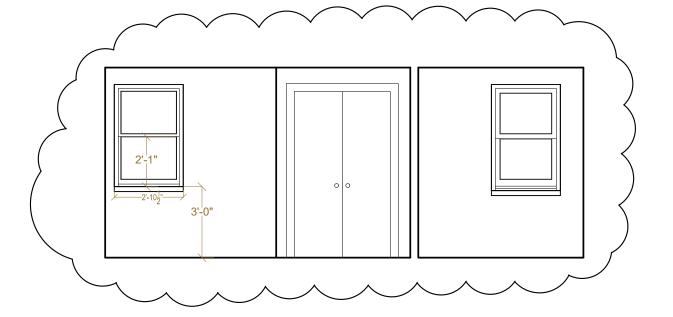

PROPOSED SOUTH BASEMENT ELEVATION

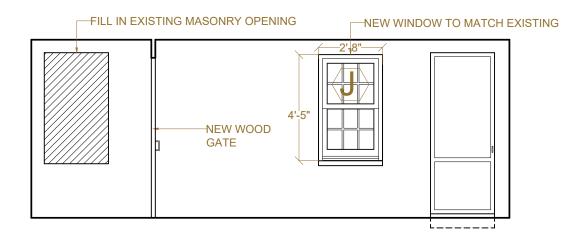CHRISTIAN ZAPATKA ARCHITEC 1656 33rd STREET NW WASHINGTON DC 20007 202 333

PROJECT:

KASSUM RESIDENCE 3045 WEST LANE KEYS, NW WASHINGTON, DC 20007 SQ: 1269 LOT: 0350

DRAWING TITLE:

**EXISTING AND** PROPOSED NORTH **ELEVATIONS** 


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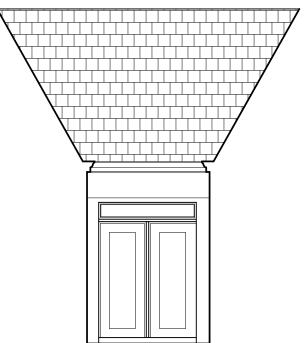
DATE: MAY 4, 2020

SCALE: 1/4" = 1'-0"


**A202** 


EXISTING SOUTH BASEMENT ELEVATION



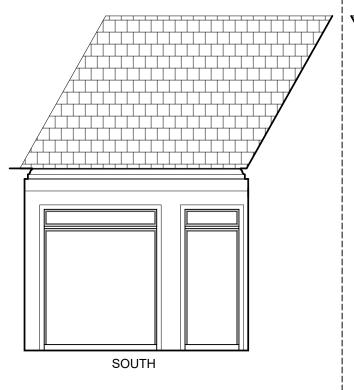

EAST

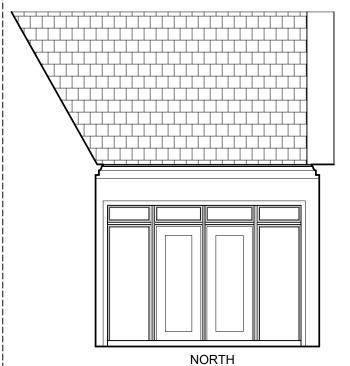

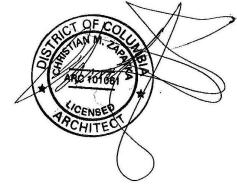

DATE: JULY 30, 2019

Architect Attestation Statement

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CHRISTIAN ZAPATKA ARCHITEC - 1656 33rd STREET NW WASHINGTON DC 20007 202 333

PROJECT:

KASSUM RESIDENCE 3045 WEST LANE KEYS, NW WASHINGTON, DC 20007 SQ: 1269 LOT: 0350

DRAWING TITLE:


**EXISTING AND** PROPOSED OUTDOOR ATRIUM **ELEVATIONS** 

SUBMISSION:


DATE: MAY 4, 2020


SCALE: 3/16" = 1'-0"

**A203** 

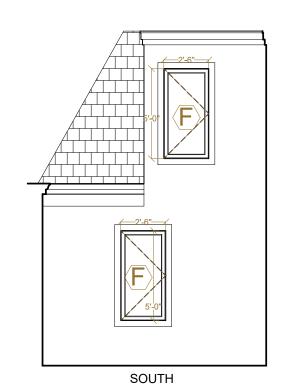



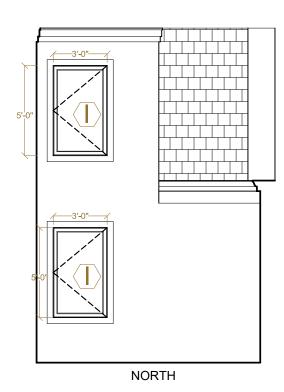

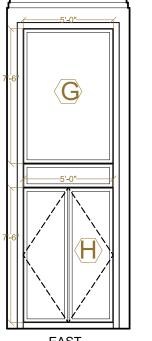


**EXISTING ELEVATIONS** 




DATE: JULY 30, 2019


Architect Attestation Statement


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NEW COPPER COVERED WOOD RAIN CANOPY

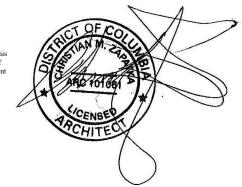PROJECT:

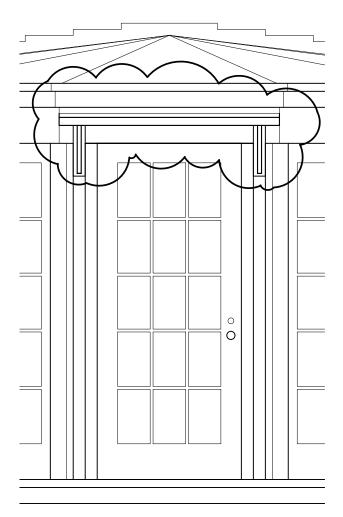CHRISTIAN ZAPATKA ARCHITECT, PLLC 1656 33rd STREET NW WASHINGTON DC 20007 202 333 2735

KASSUM RESIDENCE 3045 WEST LANE KEYS, NW WASHINGTON, DC 20007 SQ: 1269 LOT: 0350

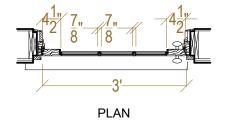DRAWING TITLE:

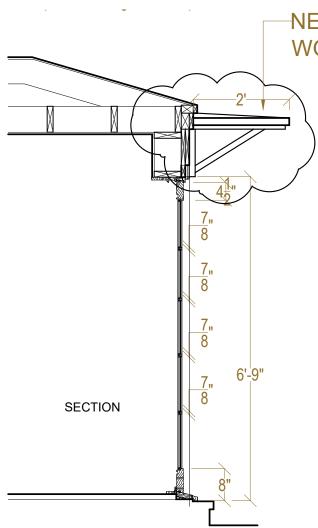
PROPOSED FRONT DOOR PLAN, SECTION, AND ELEVATION

SUBMISSION:

PERM

DATE: MAY 4, 2020


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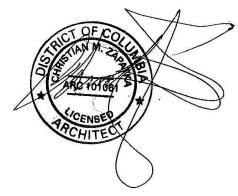


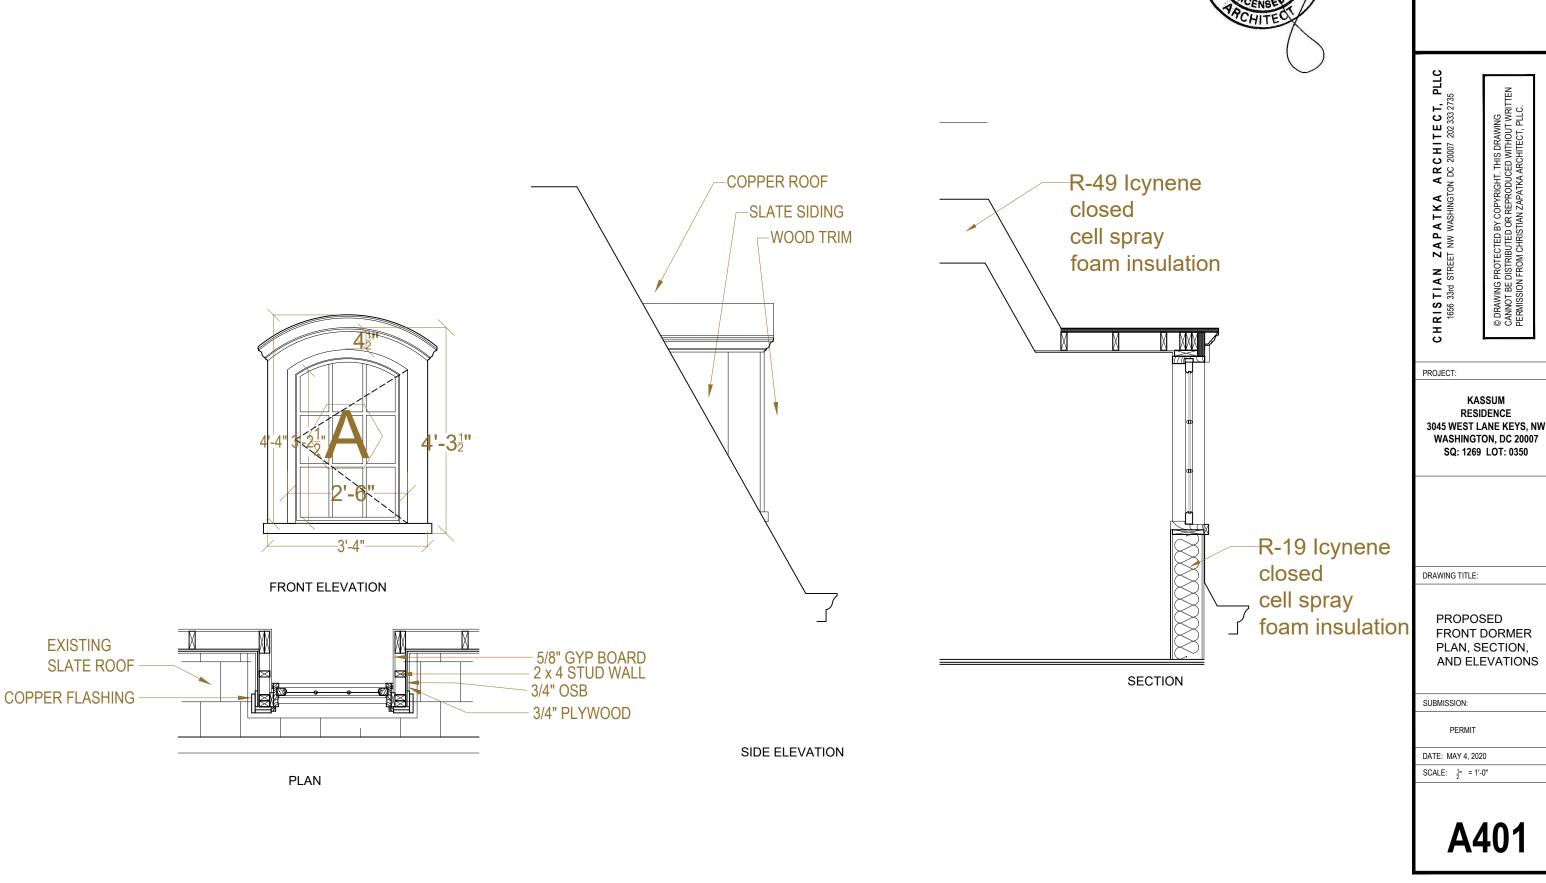
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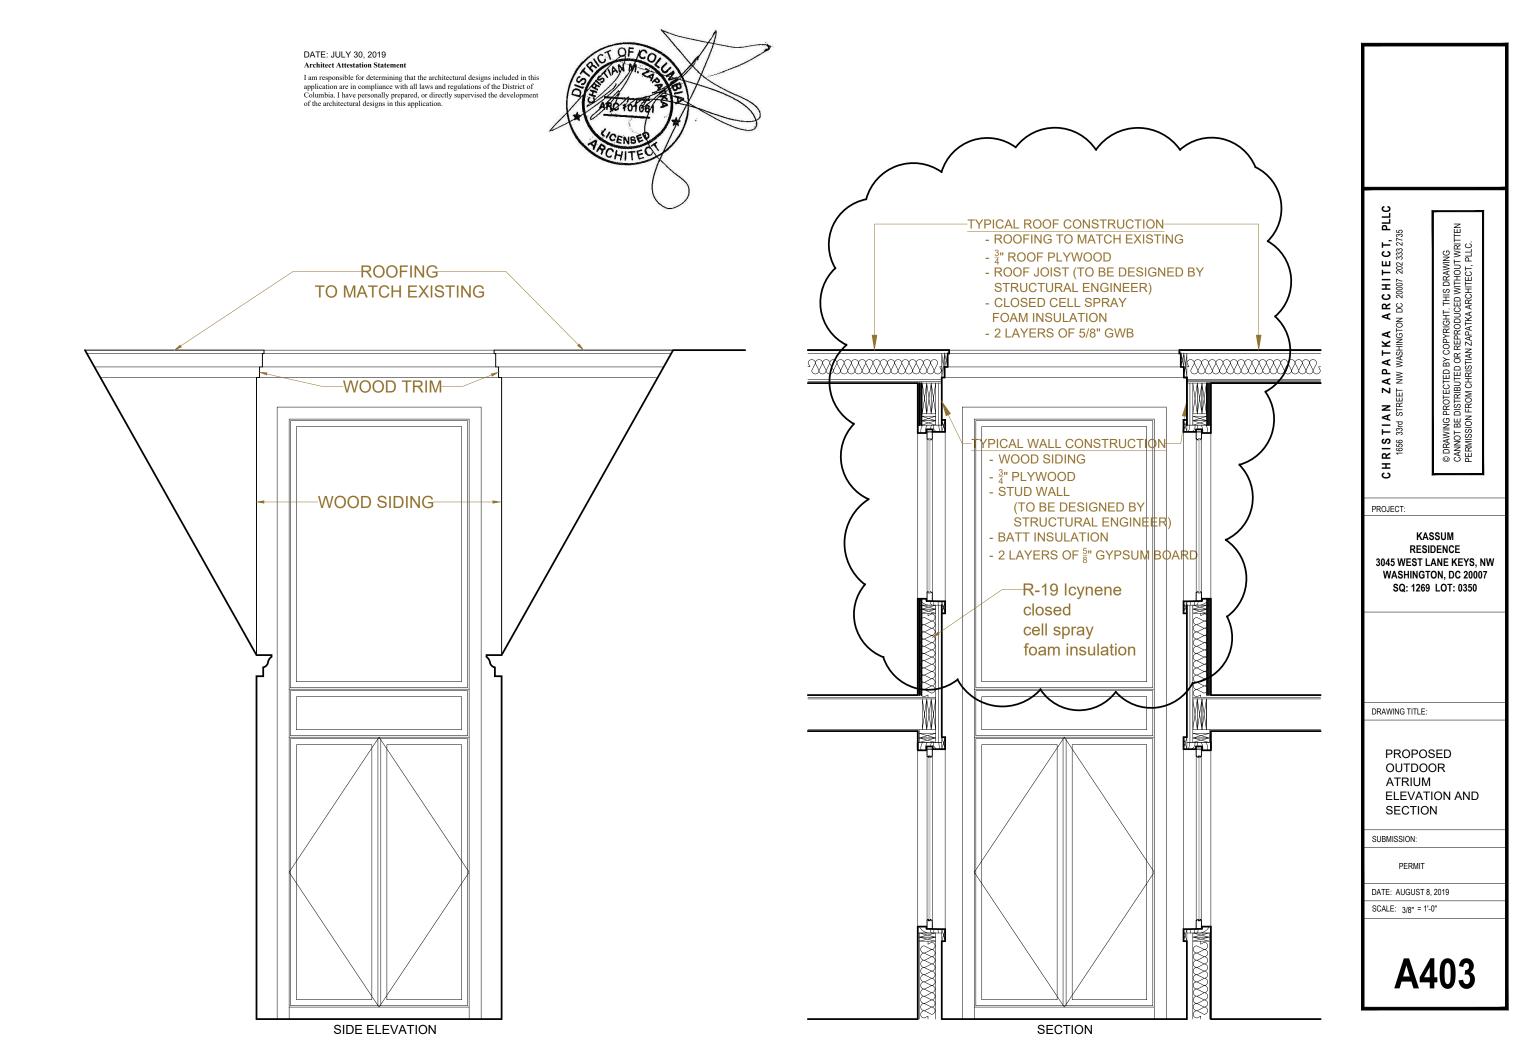
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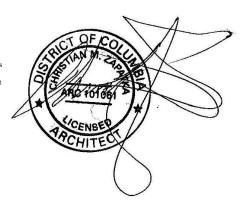






## DATE: JULY 30, 2019 Architect Attestation Statement
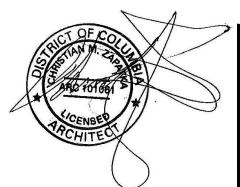
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WINDOW.	QUANTITY	WINDOW / DOOR MANUFACTURER	WINDOW / DOOR TYPE		DIMENSIONS RIFIED IN FIELD	FINISH		FIRE RATING	GLAZING	U-VALUE	SHGC	EMERGENCY ESCAPE
				WIDTH	HEIGHT	EXT	INT					
Α	2		WOOD, SINGLE GLAZED, MULTI-LIGHT, ROUND TOP, OPERABLE CASEMENT WINDOW	2'-6"	3'-6"	PAINTED	PRIMED		DOUBLE	0.30	0.40	YES
В	1		WOOD, MULTI-LIGHT, SWING DOOR	3'-0"	6-9"	PAINTED	PRIMED		DOUBLE, SAFETY GLAZING COMPLIANT TO IRC 2012	0.30	0.40	
С	1		WOOD, DOUBLE SWING DOORS (2); FIXED FRENCH WINDOWS (1)	15'-0"	7'-8"	PAINTED	PRIMED		DOUBLE, SAFETY GLAZING COMPLIANT TO IRC 2012	0.30	0.40	YES
D	1		WOOD, FIXED (1) & OPERABLE (2) HOPPER WINDOWS	11'-4"	4'-5"	PAINTED	PRIMED		DOUBLE, SAFETY GLAZING COMPLIANT TO IRC 2012	0.30	0.40	YES
Е	1		WOOD, FIXED (2) & OPERABLE (2) CASEMENT WINDOWS	10'-5"	3'-3"	PAINTED	PRIMED		DOUBLE	0.30	0.40	YES
F	2		WOOD, OPERABLE CASEMENT WINDOW	2'-6"	5'-0"	PAINTED	PRIMED		DOUBLE, FROSTED, SAFETY GLAZING COMPLIANT TO IRC 2012	0.30	0.40	
G	1		WOOD, FIXED CASEMENT WINDOW	5'-0"	7'-6"	PAINTED	PRIMED		DOUBLE, SAFETY GLAZING COMPLIANT TO IRC 2012	0.30	0.40	
Н	1		WOOD, FRENCH DOORS	5'-0"	7'-6"	PAINTED	PRIMED		DOUBLE, SAFETY GLAZING COMPLIANT TO IRC 2012	0.30	0.40	
I	1		WOOD, OPERABLE CASEMENT WINDOW	3'-0"	5'-0"	PAINTED	PRIMED		DOUBLE, FROSTED, SAFETY GLAZING COMPLIANT TO IRC 2012	0.30	0.40	
J	1		WOOD, OPERABLE DOUBLE HUNG WINDOW	2'-8"	4'-5"	PAINTED	PRIMED		DOUBLE	0.30	0.40	

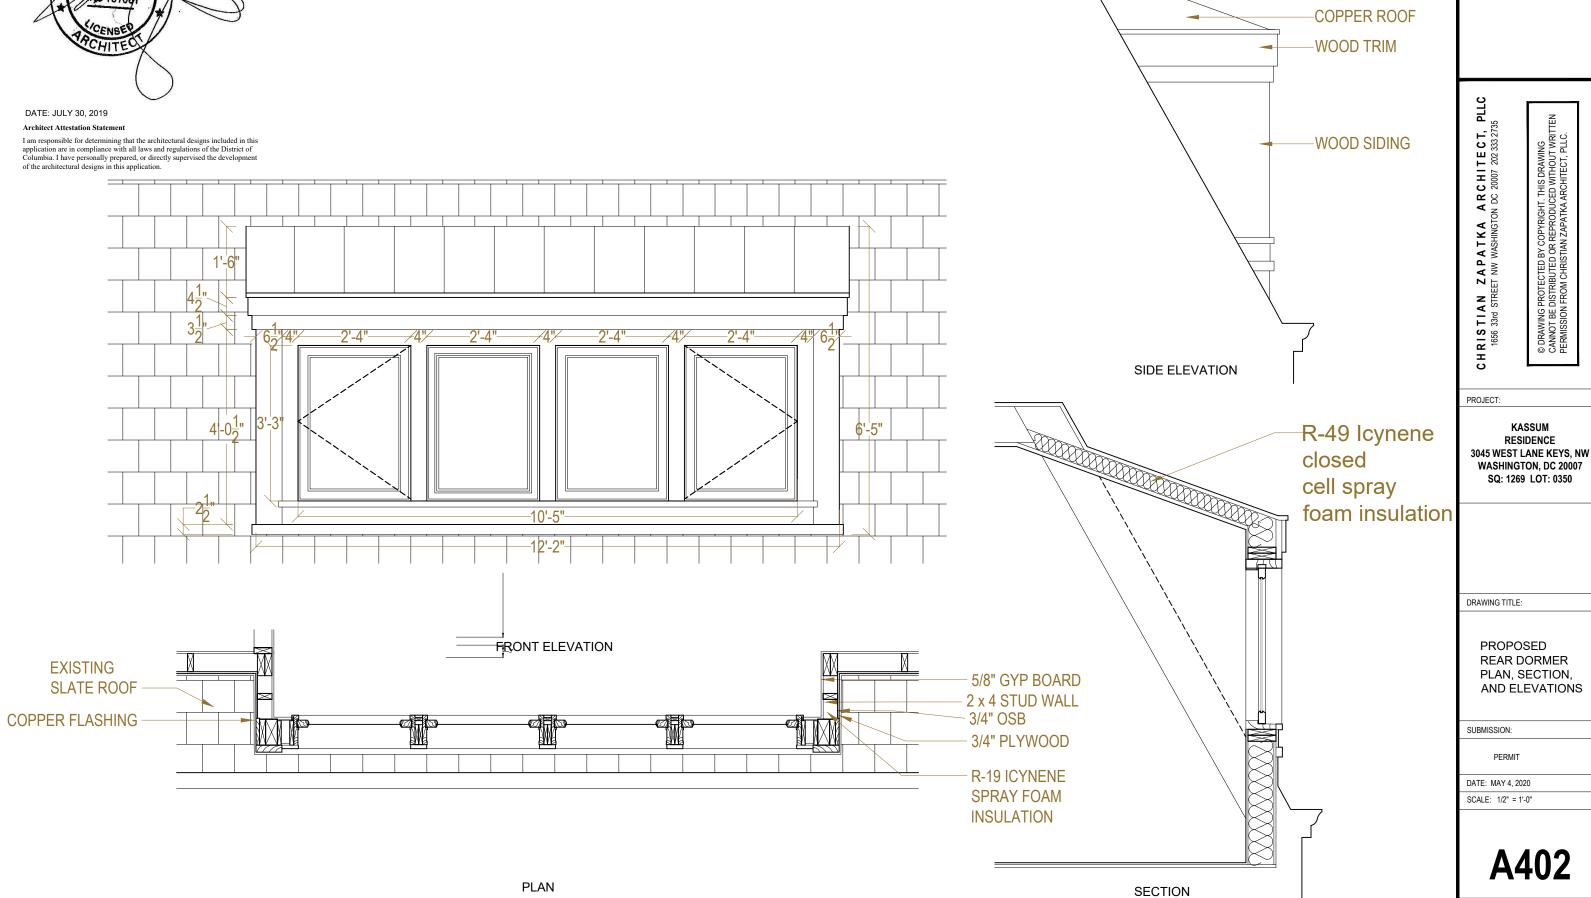NOTE: ALL GLAZING TO BE LOW-E 270 ARGON

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PROJECT:

KASSUM RESIDENCE 3045 WEST LANE KEYS, NW WASHINGTON, DC 20007 SQ: 1269 LOT: 0350

DRAWING TITLE:

**EXTERIOR** WINDOW AND DOOR SCHEDULE


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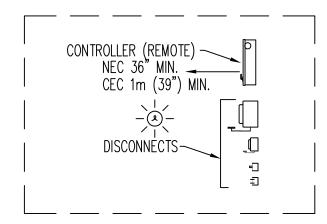
DATE: MAY 14, 2020

SCALE: = 1'-0"

#### PLEASE NOTE:

- OVERALL HOISTWAY LENGTH AND WIDTH DIMENSIONS ARE FROM DRYWALL TO DRYWALL (WHERE APPLICABLE)
- XX" GATE CLEAR OPENING, CONSULT FACTORY



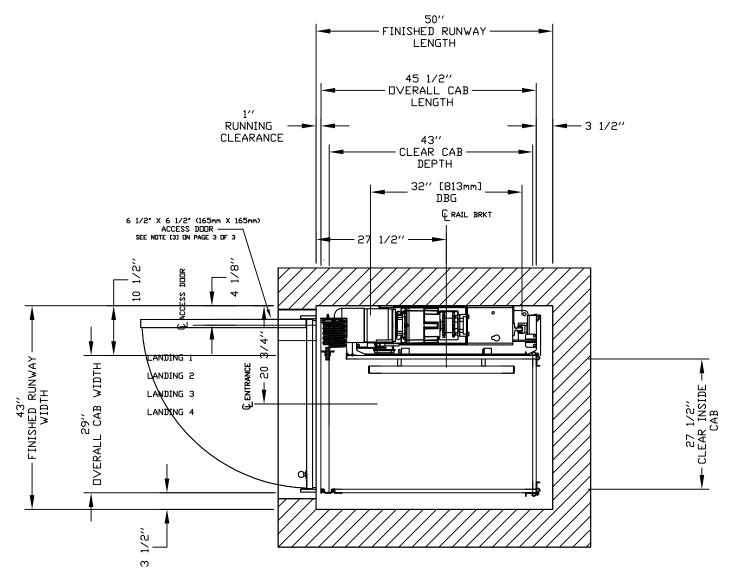


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- MAKE CHANGES AS NOTED, NO REAPPROVAL DRAWING REQUIRED
- CHANGE AS NOTED, REAPPROVAL REQUIRED MAKE CHANGES AS NOTED, SEND CORRECTED DRAWING FOR REAPPROVAL BEFORE MANUFACTURE




SIGNATURE: DATE	<u></u>
CHANGES REQUEST:	
1	
2	
3,	

CAUTION: DNCE THE DRAWING IS APPROVED, JOB CANCELLATION FEES WILL APPLY

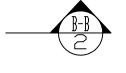OFFICE USE ONLY: CONFIGURATION VERSION STAMP: 0.0 Variant No. 1 5 9 6 6 1 E-S-7.3.18.7 MODULE VERSION STAMP:

USA PREMIER LIFTS-SAVARIA REVISION DATE: 07/05/19 Residence  $\kappa$ 3045  $\prec$   $\rightleftharpoons$   $\searrow$   $\Longrightarrow$  vincerussoloprenier WestLane

20007 Washington, DC

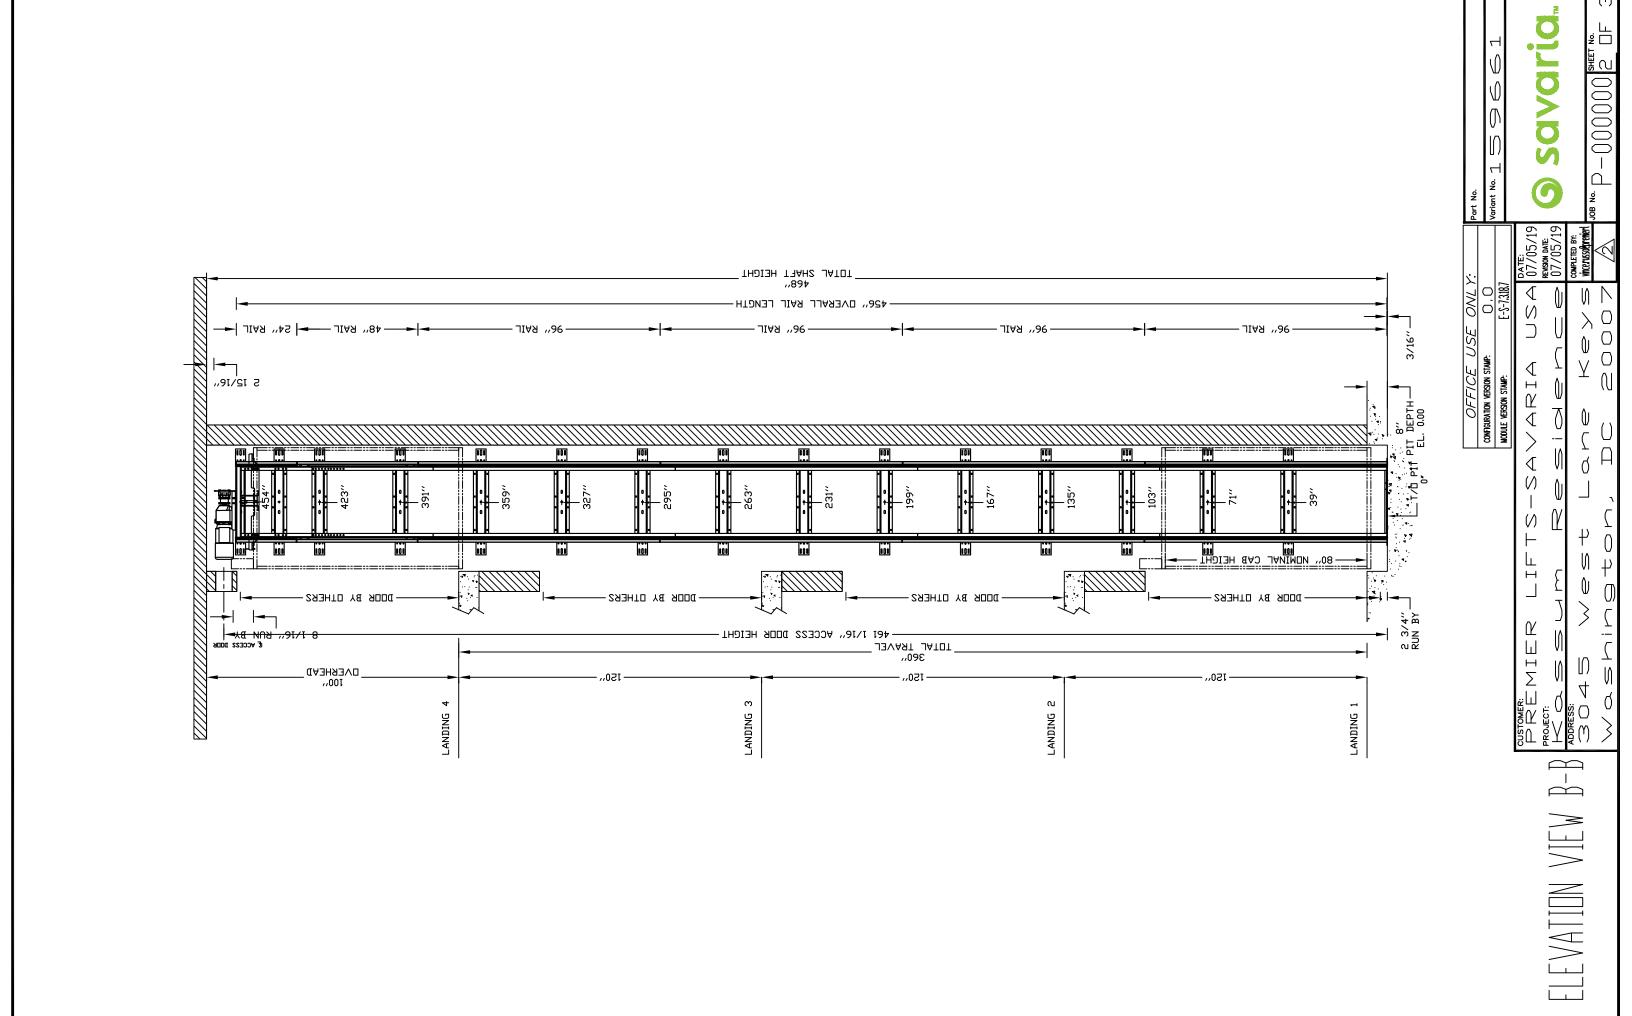

# PROVISIONS BY OTHERS

\*\*HOISTWAY, CONSTRUCTION SITE, CLEARANCE
1- HOISTWAY CONSTRUCTION AND PIT BY OTHERS. DUE TO LIMITED SPACE WITHIN THE HOISTWAY IT IS ESSENTIAL THAT THE PIT IS LEVEL AND WALLS ARE SQUARE AND PLUMB THROUGHOUT THE HOISTWAY. THE HOISTWAY FRAMING MUST BE WITHIN 1/2' ELEVATOR THROUGHOUT THE HOISTWAY.

2- DISTANCE BETWEEN THE HOISTWAY SIDE OF THE LANDING DOOR AND THE CAR DOOR OR GATE SHALL NOT EXCEED 4"(102 MM) USING THE CODE MEASURING TOOL. FOR ACCORDION (PANEL FOLD) GATES, YOU MUST HAVE FLUSH DOORS (NOT THE 3/4" SETBACK). 3/4" SETBACK IS POSSIBLE ONLY WHEN THE CAR DOORS ARE BIFOLD OR SLIM DOORS. RECOMMEND SOLID CORE DOOR SLAB

HOISTWAY MUST HAVE A MINIMUM LOCKABLE ACCESS HATCH (PROVIDED BY SAVARIA CONCORD) LOCATED AT THE TOP OF THE HOISTWAY. LOCATION MUST BE IN AN AREA WHICH WILL PROVIDE ACCESS TO THE ELEVATOR DRIVE ASSEMBLY BY THE MANUAL LOWERING HANDLE. MANUAL LOWERING HANDLE WILL ENABLE USER TO DVERPOWER BRAKE AND LOWER CAR WITHOUT BODILY ENTRY TO THE HOISTWAY

4- THE PIT FLOOR SHALL BE CONSTRUCTED TO WITHSTAND AN IMPACT LOAD OF 6400 LBS [2903kg]. REF. CSA B44 SECTION 2.11 (ASME/ANSI A17.1 SECTION 106.)
5- HOISTWAY TO BE FREE OF ALL PIPES, WIRING AND OBSTRUCTIONS NOT RELATED TO THE OPERATION OF THE ELEVATOR. FOR COMPLYING WITH LOCAL CODES.

6- HOISTWAY CONSTRUCTION REQUIREMENTS MAY VARY FROM REGION TO REGION.
DIMENSIONS GIVEN ARE MANUFACTURERS RECOMMENDED CLEARANCES. THEY REFLECT THE
RUNNING AND ACCESS CLEARANCES. CONSULT YOUR LOCAL AUTHORITY TO ASSURE COMPLIANCE WITH LOCAL CODES.

#### DIMENSIONS WARNING

CONTRACTOR/CUSTOMER TO VERIFY ALL DIMENSIONS AND REPORT ANY DISCREPANCIES TO OUR OFFICE IMMEDIATELY.

\*STRUCTURAL
7- A LOAD BEARING WALL IS REQUIRED TO SUSTAIN RAIL REACTIONS AS SPECIFIED ON DRAWING. BUILDING CONTRACTOR TO DETERMINE IF SUPPORTING WALL WILL SUSTAIN RAIL REACTIONS FOR COMPLYING WITH LOCAL CODES. STRUCTURE TO ANCHOR A CRANK SHAFT AND SAFETY HARNESS, WHERE APPLICABLE/NEEDED, TO BE PROVIDED BY CONTRACTOR.

8- SUITABLE LINTELS MUST BE PROVIDED BY OWNER/AGENT.
DOOR FRAMES ARE NOT DESIGNED TO SUPPORT OVERHEAD WALL LOADS.

9- SUITABLE LINTELS MUST BE PROVIDED BY OWNER/AGENT. ALL FULL HEIGHT DOORS BE ALIGNED WITH THE DOOR CENTERLINE SHOWN ON PLAN DETAIL. DOOR WITH THE CORE IS BETTER THAN THE HOLLOW DOOR.

DOOR HANDLES ARE REQUIRED FOR ALL FULL SIZE DOORS.

SEE INSTALLATION MANUAL FOR DETAILS ON THE INTERLOCKS. INTERLOCKS ARE REQUIRED FOR ALL FULL SIZE DOORS.

#### \*ELECTRICAL

12- THE ELEVATOR CONTROLLER IS 24.4' [620mm] WIDE X 23' [584mm] HIGH X 6.7' [170mm] DEEP. THE CONTROLLER IS PROVIDED BY SAVARIA CONCORD AND IS EITHER :

A : ATTACHED TO THE RAIL WALL INSIDE THE HOISTWAY BETWEEN THE "T" RAILS WITH ACCESS EITHER UNDER THE CAB OR THROUGH THE CAB OF THE ELEVATOR, OR

B: IN A REMOTE LOCATION EXTERNAL TO HOISTWAY, THAT NEEDS PROPER

STRUCTURAL WALL TO SUPPORT THE CONTROLLER ON ALL 4 CORNERS, HOLE POSITIONS

ARE = 23.5' [597mm] WIDE BY 21.5' [546mm] HIGH.

ARE = 23.5' [597mm] WIDE BY 21.5' [546mm] HIGH.

13- ARRANGE FOR A POWER SUPPLY WITHIN SIGHT OR NEXT TO THE ELEVATOR
CONTROLLER PRIOR TO DELIVERY OF THE UNIT (BOTH 240 VOLT AND 115 VOLT). THE 240
VOLT, SINGLE PHASE, DEDICATED CIRCUIT (WITH GROUND) SHALL ORIGINATE FROM A
LOCKABLE 2 POLE FUSED DISCONNECT (20 AMP RK 5 RATED FUSES) WITH AUXILIARY
CONTACT. THE 115 VOLT, SINGLE PHASE. DEDICATED CIRCUIT (WITH GROUND) SHALL
ORIGINATE FROM A LOCKABLE DISCONNECT (15 AMP FUSE). ALL ELECTRICAL TO
DISCONNECTS SHALL BE PROVIDED AND INSTALLED BY OTHERS AND MUST COMPLY WITH

APPLICABLE	CUDE2								
		DISC SIZE	ONNECT	TIME	E DELAY				
		SIZL		FUSE	E SIZE	VOLTS	PHASE	AMPERAGE	
MOTOR &	EQUIP.	30	AMPS	20	AMPS	230-240	1	20.2 AMPS	
CAB LIG	STHE	15	AMPS	15	AMPS	115	1		

14- FIELD ELECTRICAL WIRING AND CONNECTIONS TO HALL-CALLS, PIT SWITCH AND INTERLOCKS ARE PROVIDED.

INTERLOCKS ARE PROVIDED.

15- LIGHTING SHALL BE A MINIMUM OF 10 FOOT CANDLES (100 LUX) IN CONTROLLER SPACE. THE SWITCH FOR THE LIGHT MUST BE WITHIN 18' [457mm] OF THE HOISTWAY ACCESS. THE LIGHT MUST BE GUARDED TO PREVENT ACCIDENTAL BREAKAGE OR CONTACT WITH THE HOT BULB. THE SWITCH, LIGHT, AND GUARD ARE PROVIDED AND INSTALLED BY OTHERS. (MUST COMPLY WITH APPLICABLE CODES) .LIGHTING OF 100 LX MIN. AT PLATFORM AND LANDINGS. LIGHTING WITH SWITCH AND ELECTRICAL GFCI OUTLET IN HOISTWAY PIT.

16- IF A TELEPHONE CIRCUIT IS REQUIRED (OPTION FOR ELEVATOR) JACK IS PROVIDED AND INSTALLED BY OTHERS. THIS CIRCUIT SHALL BE BROUGHT TO A LOCATION NEXT TO THE CONTROLLER AND BE AVAILABLE TO CONNECT AND TEST UPON ELEVATOR

THE APPROPRIATE ENVIRONMENT FOR THE ECLIPSE IS BETWEEN OC TO +40C (32F TO 104F), 20-80% HUMIDITY (NON-CONDENSING). VF DRIVE RELIABILITY IMPROVES IN ENVIRONMENTS WITHOUT WIDE TEMPERATURE FLUCTUATIONS.

#### WHEN CONTROLLER EXTERNAL

18- LOCATION / ACCESS- 'CONTROLLER ROOM' LOCATED AT THE LOWEST LEVEL ADJACENT TO HOISTWAY, UNLESS SHOWN OTHERWISE ON THE LAYOUT DRAWINGS. FIELD ADJUSTMENT BY INSTALLER MAY BE NECESSARY TO MEET JOB SITE CONDITIONS OR REGULATIONS. ACCESS TO CONTROLLER ROOM TO BE THROUGH A SELF CLOSING LOCKABLE DOOR WHERE CODE CONSIDER IT AS A MACHINE ROOM. WHEN APPLICABLE SLEEVES FOR ELECTRIC LINES.

19- ALTHOUGH THE ELEVATOR IS DESIGNED TO MEET CSA B44 (ANSI A17.1), LOCAL CODES MAY VARY, DEALER IS RESPONSIBLE FOR COMPLYING WITH LOCAL CODES.


#### **GENERAL**

CLASSIFICATION:	Residential Building
APPLIED CODE:	_ASME 17.1-2010 SEC. 5.3
MDDEL:	_ Eclipse
CAPACITY:	_950lbs
NOMINAL SPEED:	.40 fpm [0.20 m/s] UP AND DOWN
TRAVEL:	
PIT DEPTH:	_8 ′′
POWER SUPPLY:	60 HzSingle Phase 240 volt

#### DRIVE UNIT

DRIVE ASSEMBLY MFR	CONCORD
MOTOR:	2.0 Hp W/Integral Brake FROM NORD
GEAR MODEL:	42.17:1 Ratio Gear Box
MOTOR CONTROLLER:	Preprogrammed VF Drive.

#### LOAD BEARING WALL

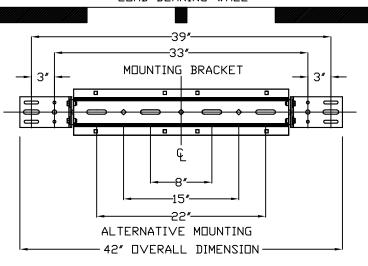

#### MOUNTING BRACKET

### FIRST DOOR BY LANDING CHART

ENTRANCE SIDE DOOR SWING LOCK TYPE
LUCK TABE
LUCK TIFE
AUTO DOOR OPENER
HALL CALL KEY SWITCH
FLOOR MARKING

	LANDING 1		LANDING 3	
	Doors By Others	Doors By Others	Doors By Others	Doors By Others
	Side A	Side A	Side A	Side A
	Right Hand Swing	Right Hand Swing	Right Hand Swing	Right Hand Swing
	Porta Lock	Porta Lock	Porta Lock	Porta Lock
Н				
	1	2	3	4

#### RAIL FORCES 19°9 ¥ R2 \* R1 138.2 kg [304 lbf] 88.2 kg [1<u>94 lbf</u>] 24.5 kg / RAIL WEIGHT [18.0 lbs / ft

К3	NU I E:	
		_

PIT FLOOR TO SUPPORT LOAD OF: 2909 kg [6400 lbs] \*\* (INCLUDES IMPACT)

WALL ANCHOR POINTS MIN, PER BRACKET 2 PER SIDE OF RAIL BRACKET CENTER LINE PULL OUT FORCE PER FASTENER 69 kg [152 lbs]

### CAR FINISH DETAILS CAB PANEL SELECTION:

CAB SPECIAL FINISH:	Not applicable
CEILING SELECTION:	standard (white)
POT LIGHT FINISH:	Stainless Steel
TRIM COLOUR:	Clear Anodized Aluminum
CAR STATION PLATE:	Clear Anodized Alum, with PI
HAND RAIL TYPE:	Clear Anodized Aluminum
CAB FLOORING:	Plywood Floor 3/4″
FINISHED FLOOR THICKNESS:	3/4" finish
TELEPHONE BOX:	Telephone Box Required
HALL CALL STATIONS:	.Call Stations are the Same
HALL CALL FINISH:	
TELEPHONE CABINET:	.Telephone Box Required
CAR DIMENSIONS/PLATFO	RM GATES

To Be Determine

CAB TYPE:	_Type 1 Left Hand
CAB OPERATION:	_auto
GATES REQUIRED <u>:</u>	_Manual Gates
GATE TYPE:	_Panel Fold(Clear)WHT 3 Plexi
GATE FINISH:	_Gate Finish : Hard Hinges /locking mechanism
LANDING DOOR FINISH:	_N/A
OLIODENIOTENI	

### <u>SUSPENSION</u>

	_DUAL #60 RULLER CHAIN RAIIU 1:1
CONSTRUCTION:	_ANSI_B29.1
NOMINAL STRENGTH:	_9020 LBS PER CHAIN


\_405 " CHAIN LENGTH: \_\_\_\_\_ SAFETIES: \_\_\_\_\_ TYPE A

TEMP. RUN BUTTON: DISCONNECT: BUFFER SPRING: PHONE:	_ Additional Cable Not Required _ Temp Run Button not included _By □thers _ no _ Standard Phone Provided _ Flat Travelling Cable provided
TRAVELING CABLE: LED POT LIGHT:	Flat Travelling Cable provided LED Pot Light
FLOOD SWITCH:ECLIPSE WHEELS UPGRADE:	Not Required Guide shoe

20007

NY CAM KIT: \_\_\_\_\_No

CW SAFETY REQUIRED:\_\_\_\_

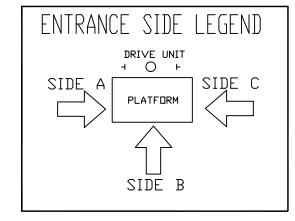

OFFICE USE ONLY:		<i>′</i> :	Part No.					-
CONFIGURATION VERSION STAMP:	0.0		Variant No.	1 =	$\overline{}$	_	_	_
MODULE VERSION STAMP:	E-S-7.3.18.7		variant ivo.	<u> </u>			56	
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PREMIER LIFTS-SA 07/05/19  $K \circ$ Residence COMPLETED BY: <u>vince.russo@prenier</u> 3045 West Lane Keys


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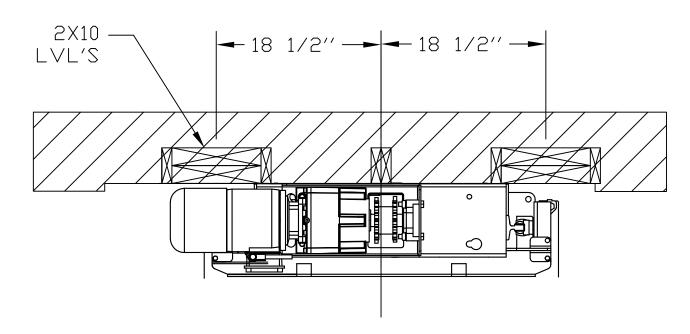
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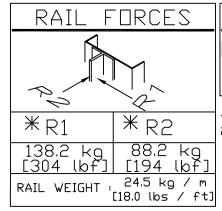
### NOTE:

- 1: THIS DRAWING IS FOR REFERENCE ONLY.
  BUILDING STRUCTURAL ENGINEER TO ENSURE THAT
  THE BUILDING AND HOISTWAY WILL SAFELY SUPPORT
  ALL LOADS IMPOSED BY THE LIFT EQUIPMENT
- 2. FIRE RATING OF HOISTWAY IS SUBJECT TO LOCAL BUILDING CODES.

## EXAMPLE OF MINIMUM SUPPORT WALL IN WOOD





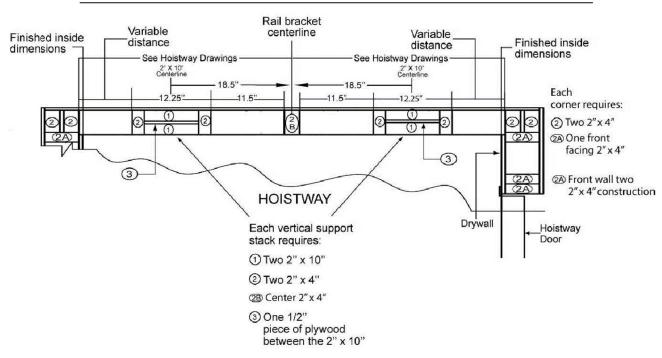

R3 NOTE:

PIT FLOOR TO SUPPORT LOAD OF:
2909 kg \*\* (INCLUDES IMPACT)
[6400 lbs]\*\*

4 WALL ANCHOR POINTS MIN. PER BRACKET
2 PER SIDE OF RAIL BRACKET CENTER LINE
PULL OUT FORCE PER FASTENER 69 kg [152 LBS]

FASTNERS PROVIDE WITH ELEVATOR ARE: 1/2" X 3" ZINC GRADE 5 CARBON STEEL HEX HEAD LAG FOR WOOD BLOCKING OR 1/2" X 3" HEX NUT SLEEVE ANCHOR STEEL ZINC FOR CONCRETE BLOCKING

