

3123 Dumbarton Street, NW Washington, DC 20007 Telephone (202) 674-9226 www.valhawkins.com

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3123 DUMBARTON STREET

3123 DUMBARTON ST, NW WASHINGTON, DC 20007

- DRAWING TITLE -


ARCHITECTURAL SITE PLAN

- DATE
March 11, 2021

- SCALE
1/8" = 1'-0"

- DRAWING TITLE -

A002

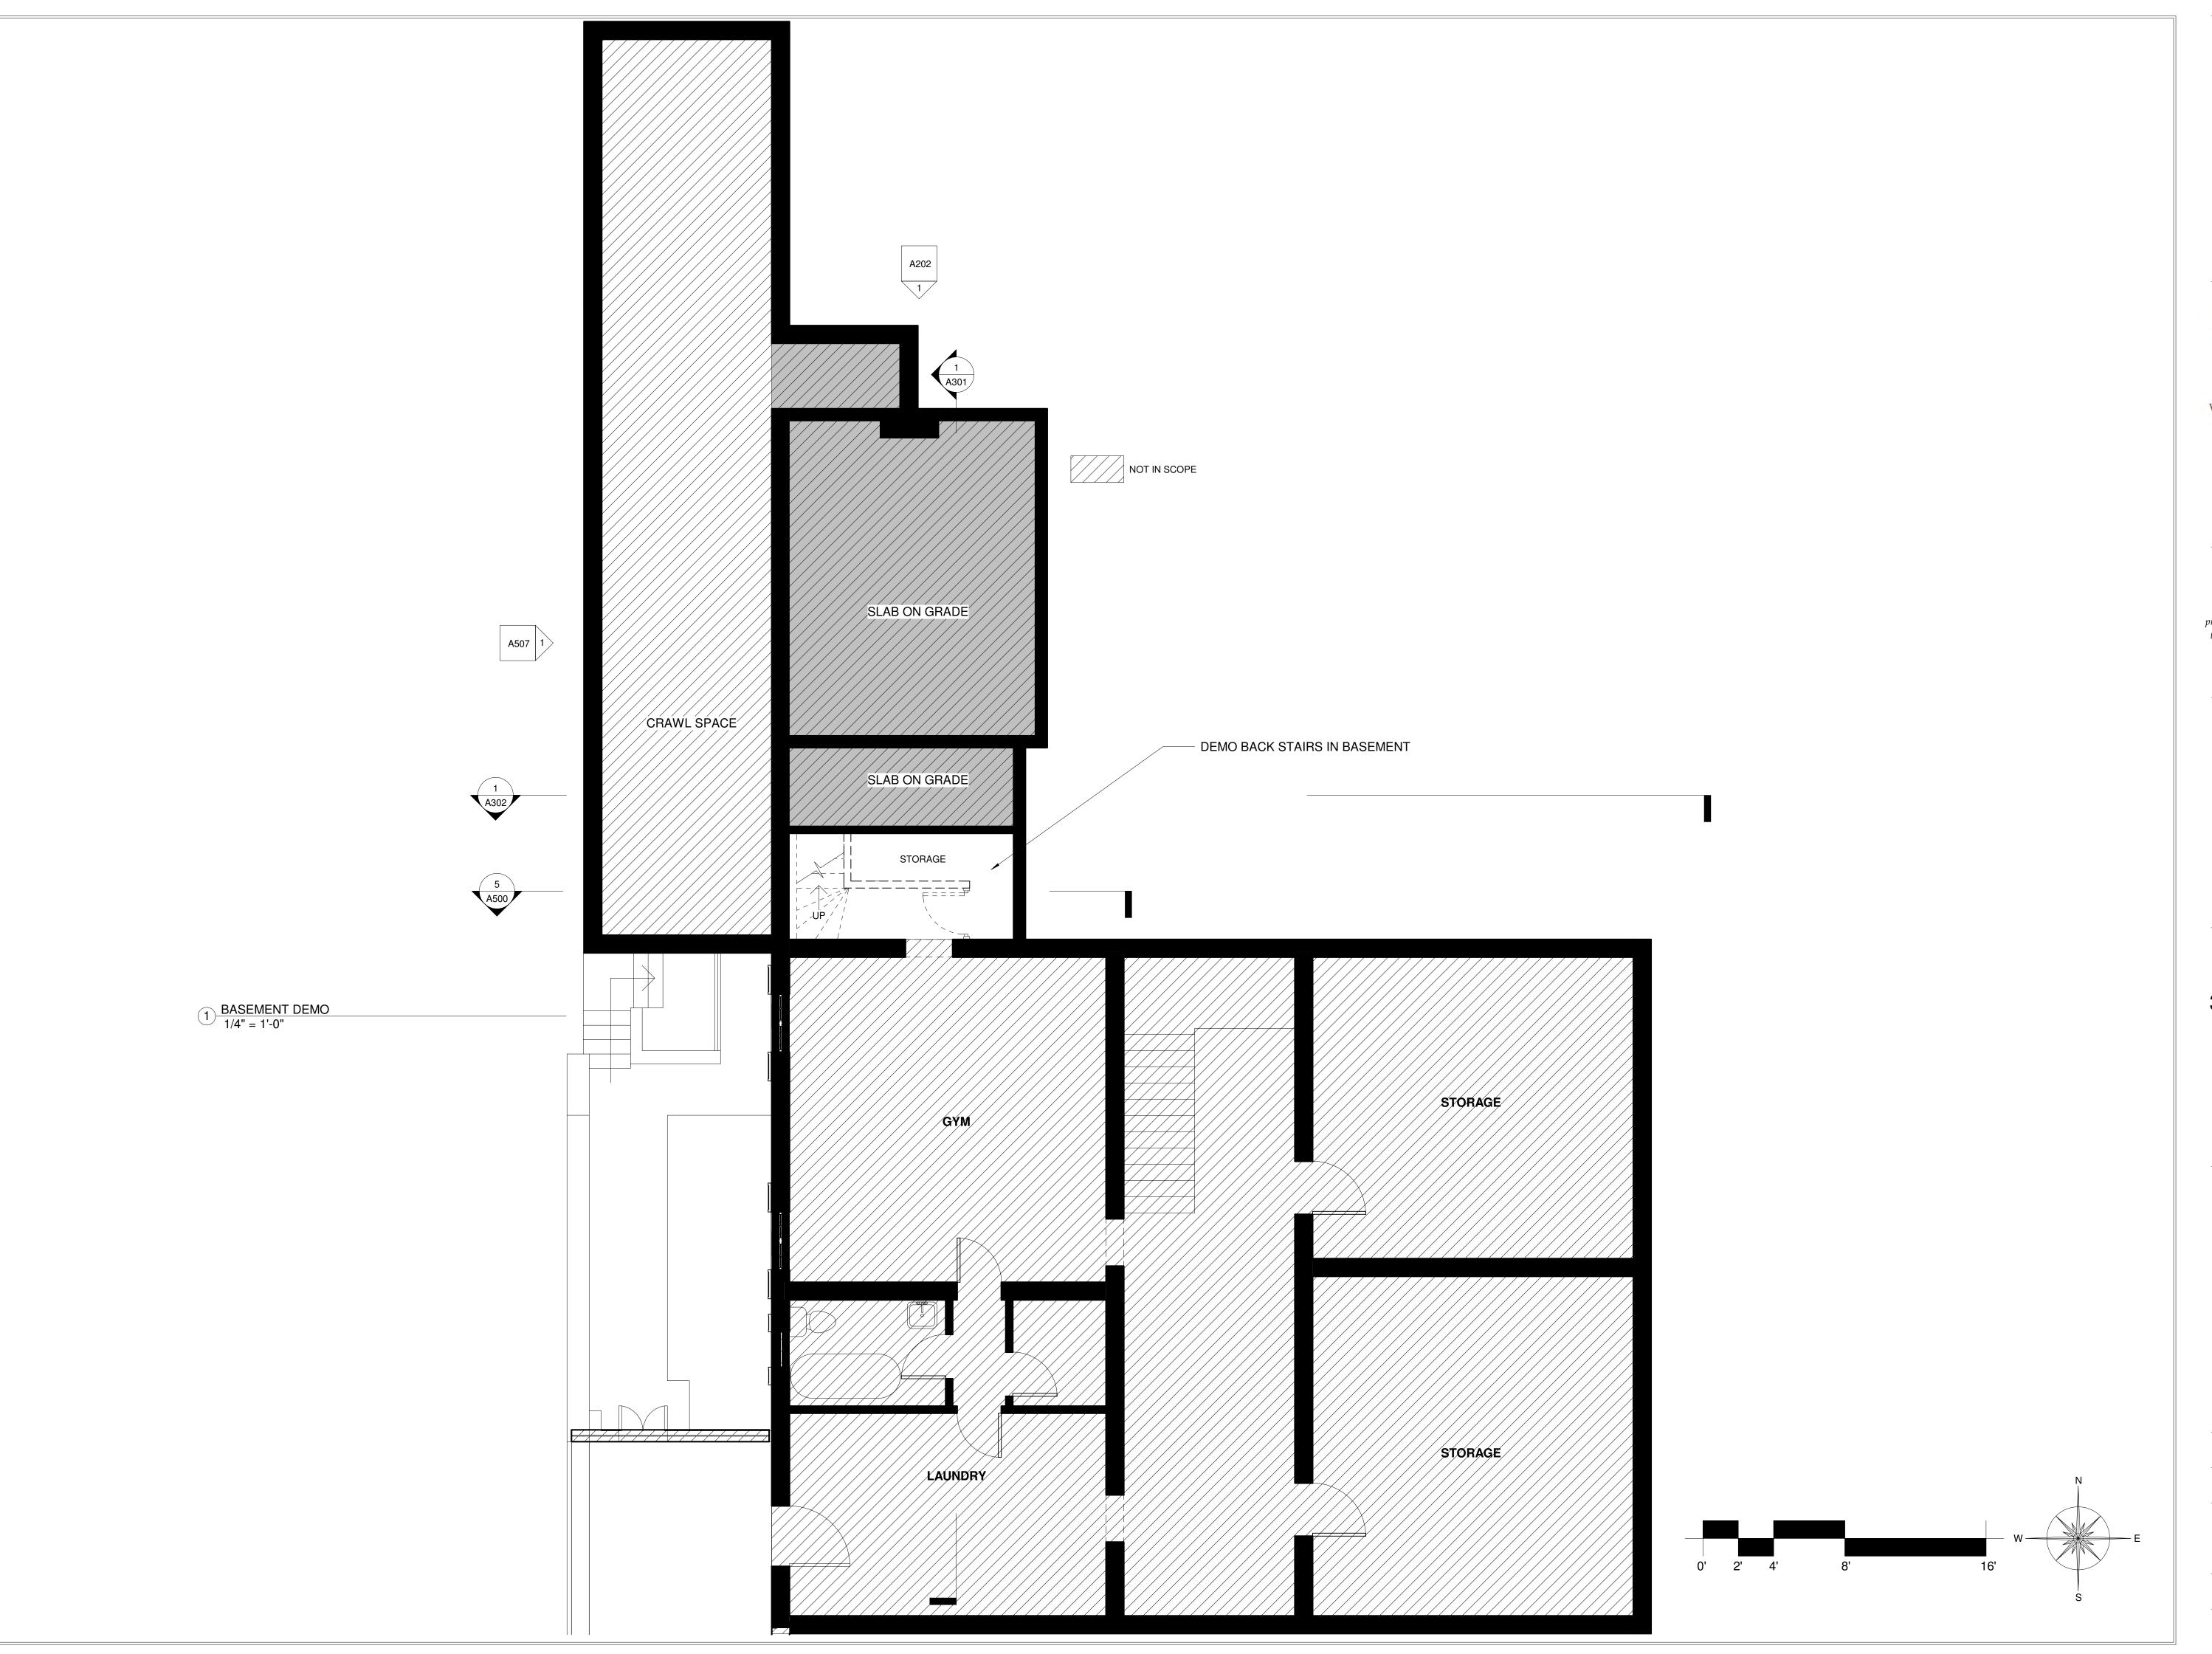

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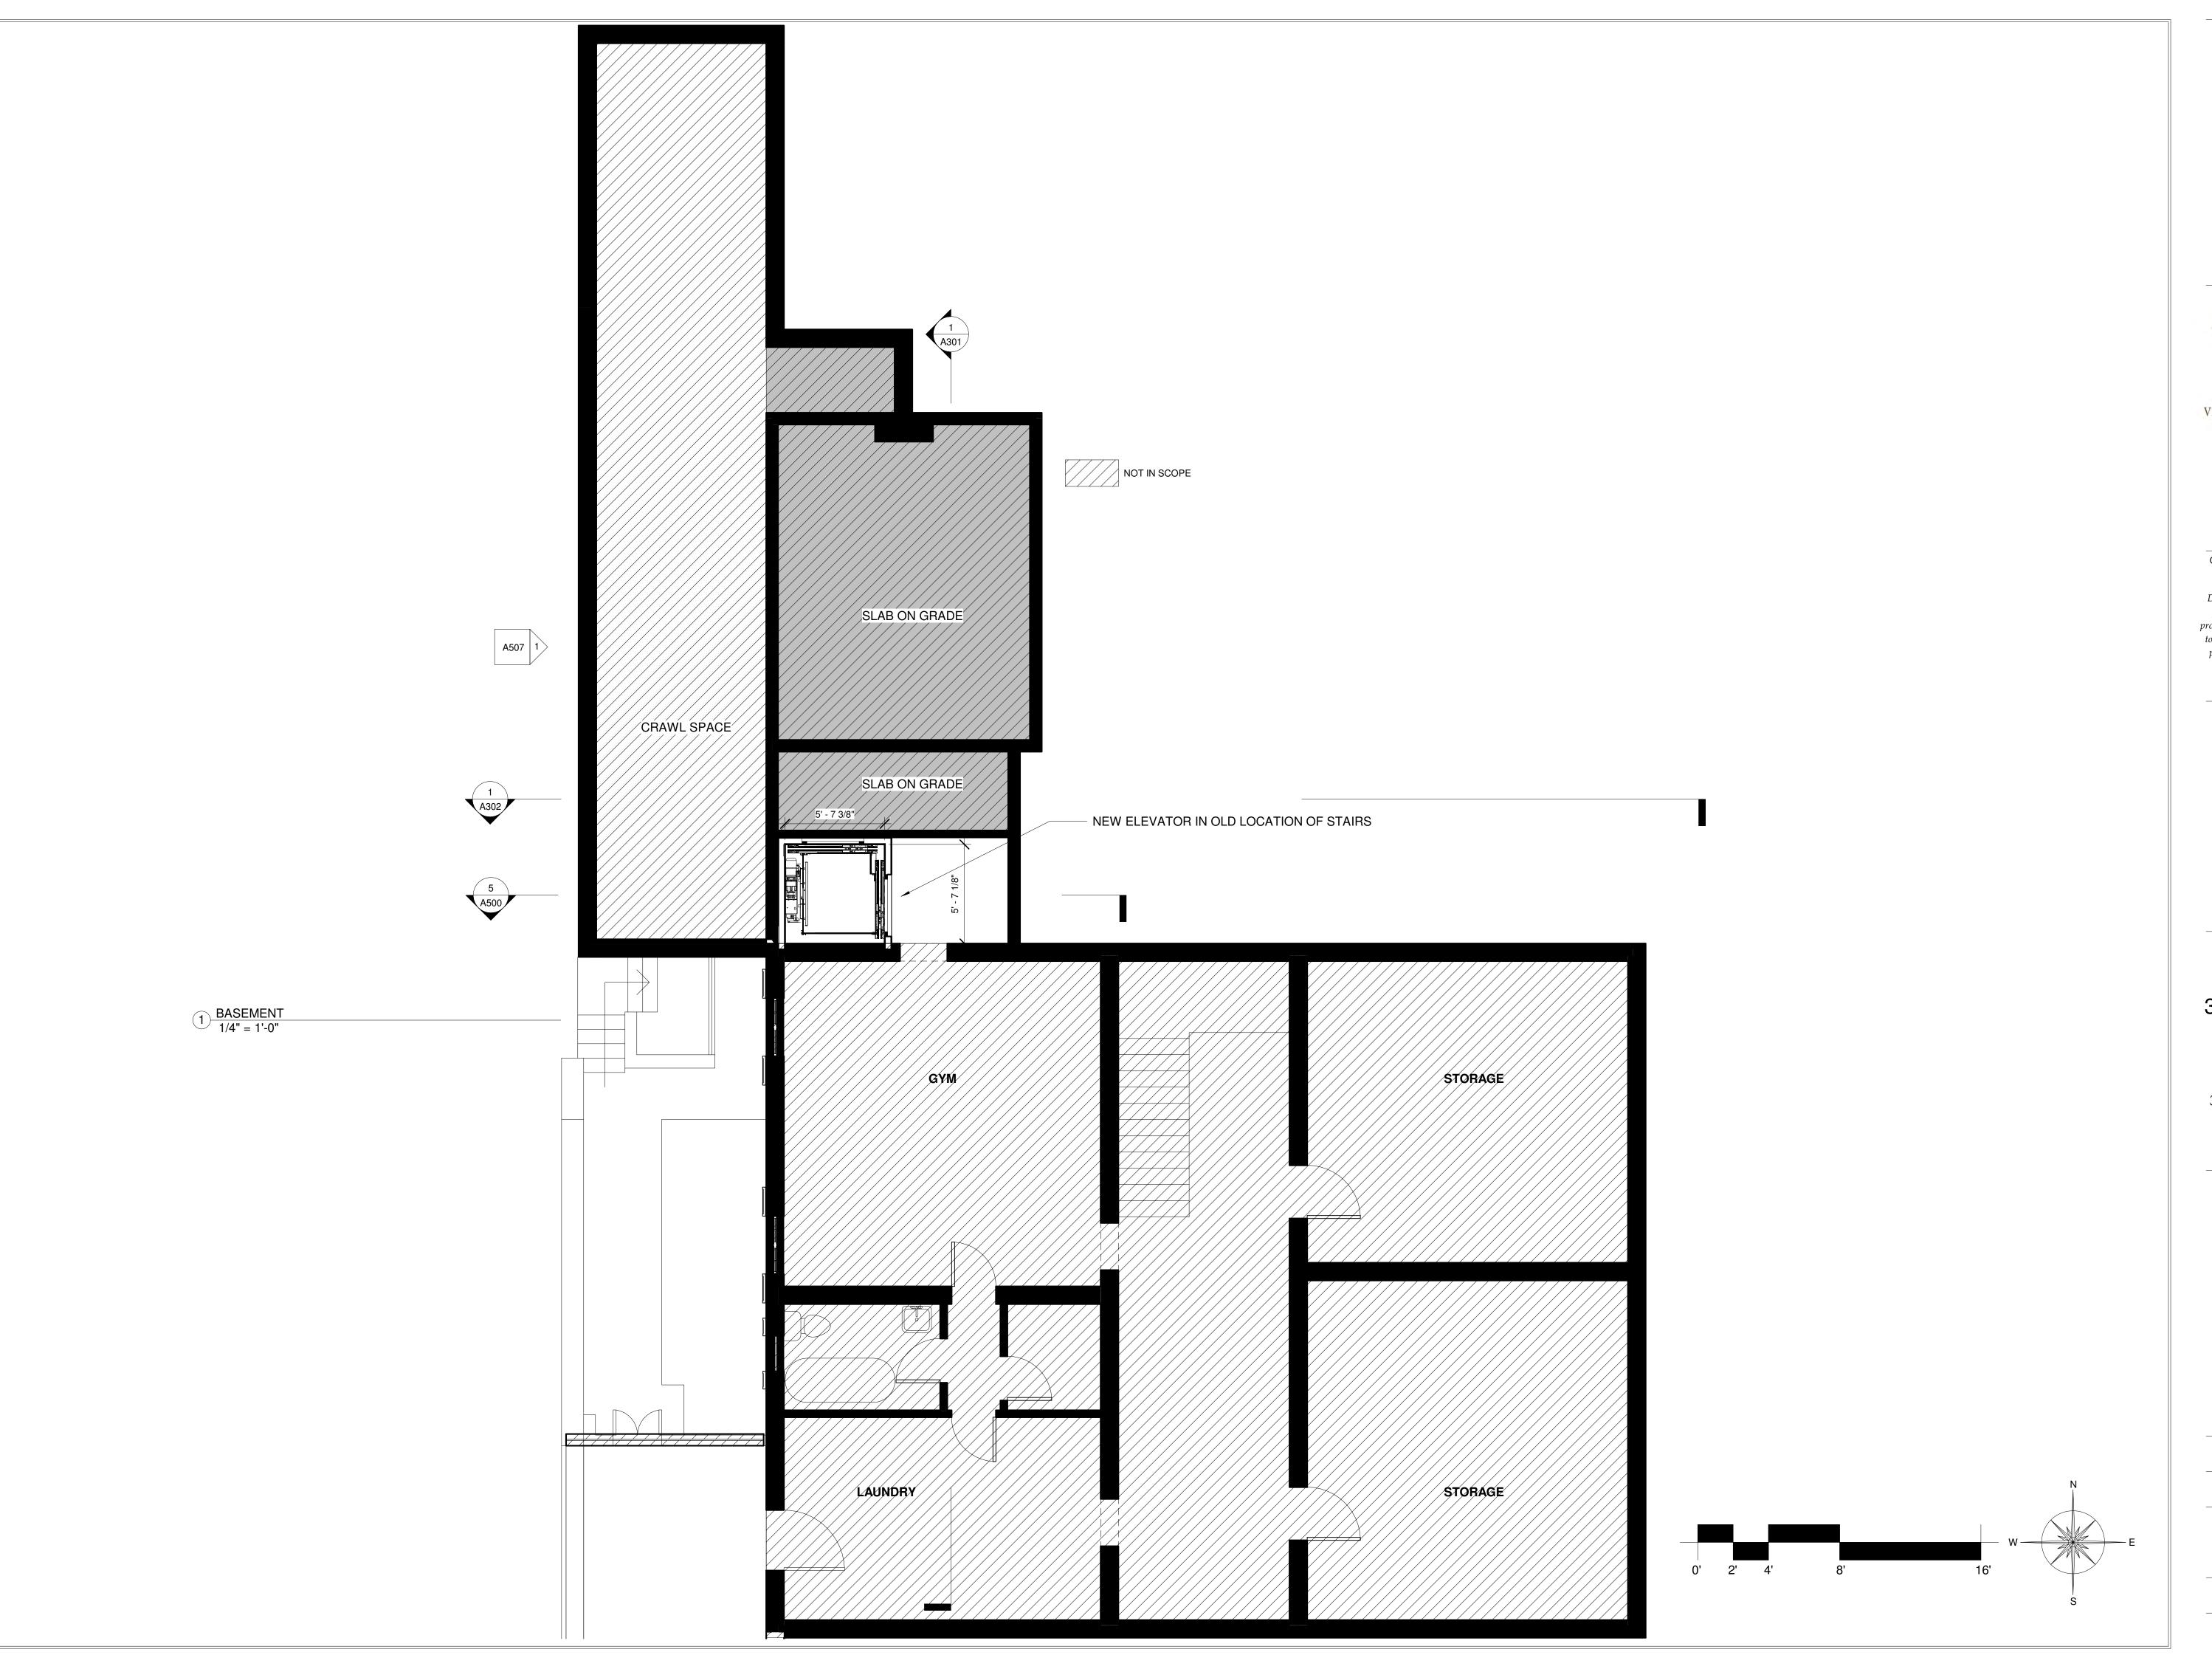
3123 DUMBARTON ST, NW WASHINGTON, DC 20007

- DRAWING TITLE -

BASEMENT DEMO

- DATE -March 11, 2021 - SCALE -1/4" = 1'-0"

- DRAWING TITLE -



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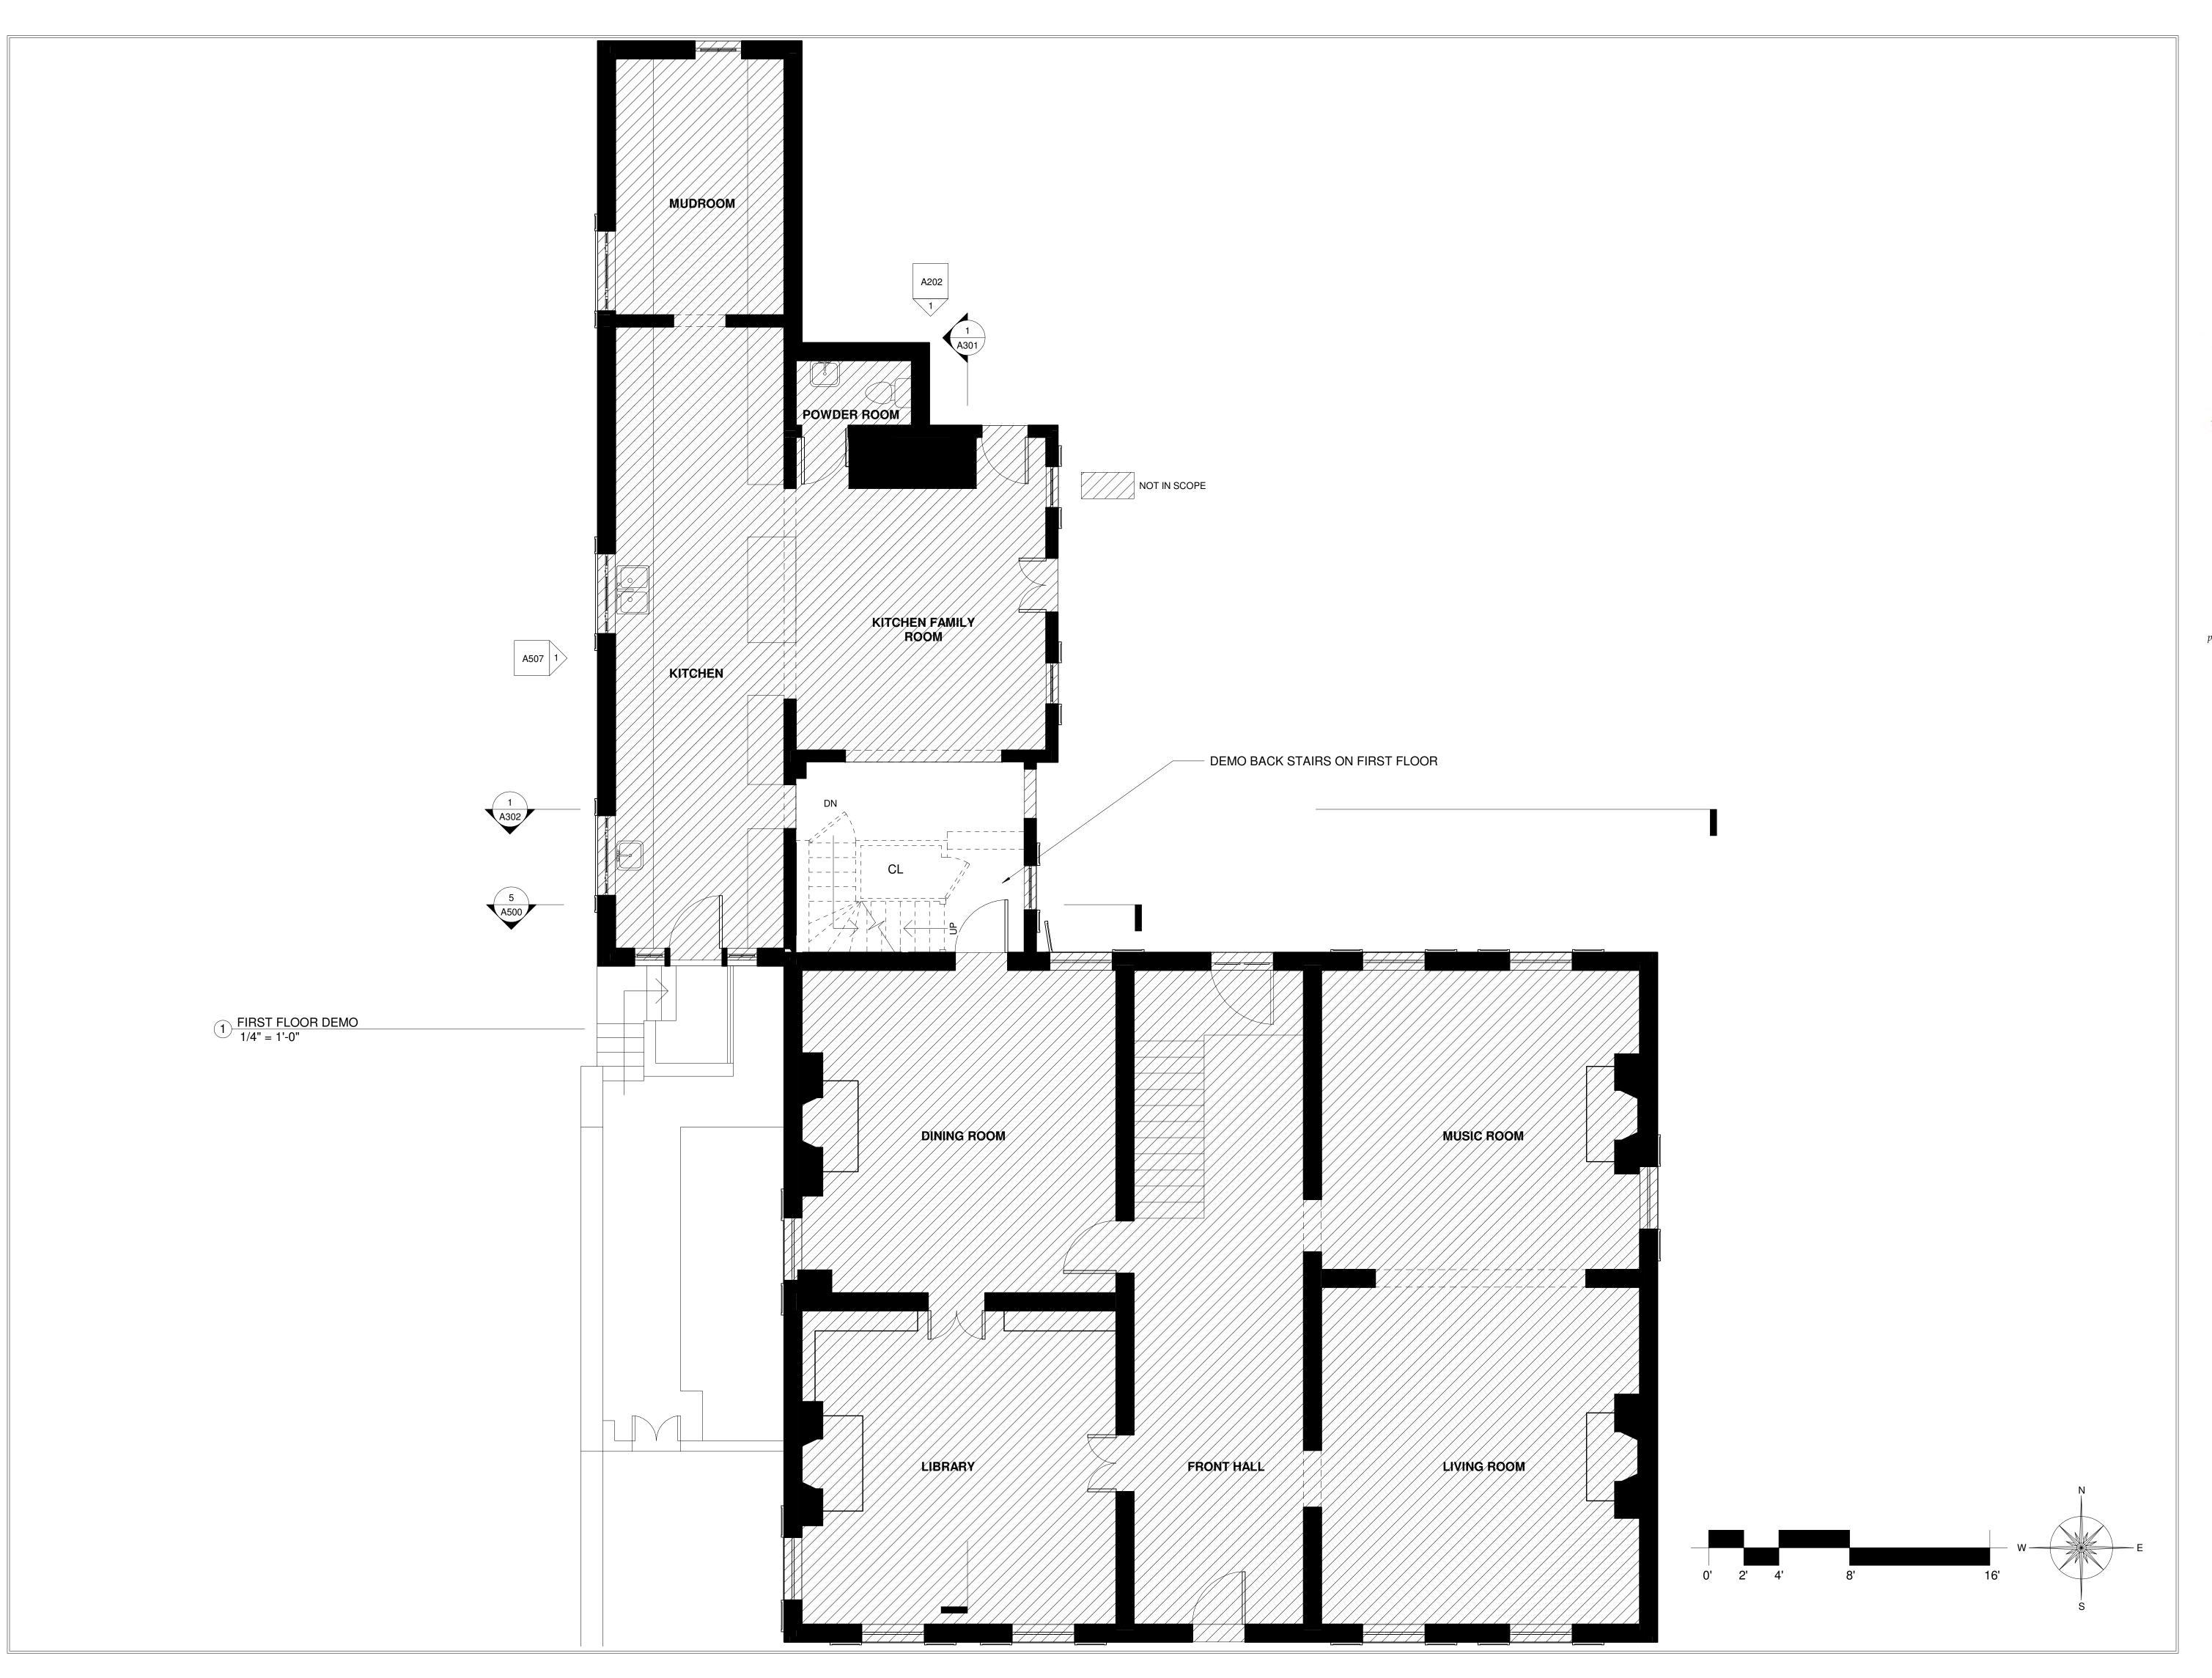
- DRAWING TITLE -

BASEMENT

- DATE -March 11, 2021 - SCALE -1/4" = 1'-0"

- DRAWING TITLE -

A100





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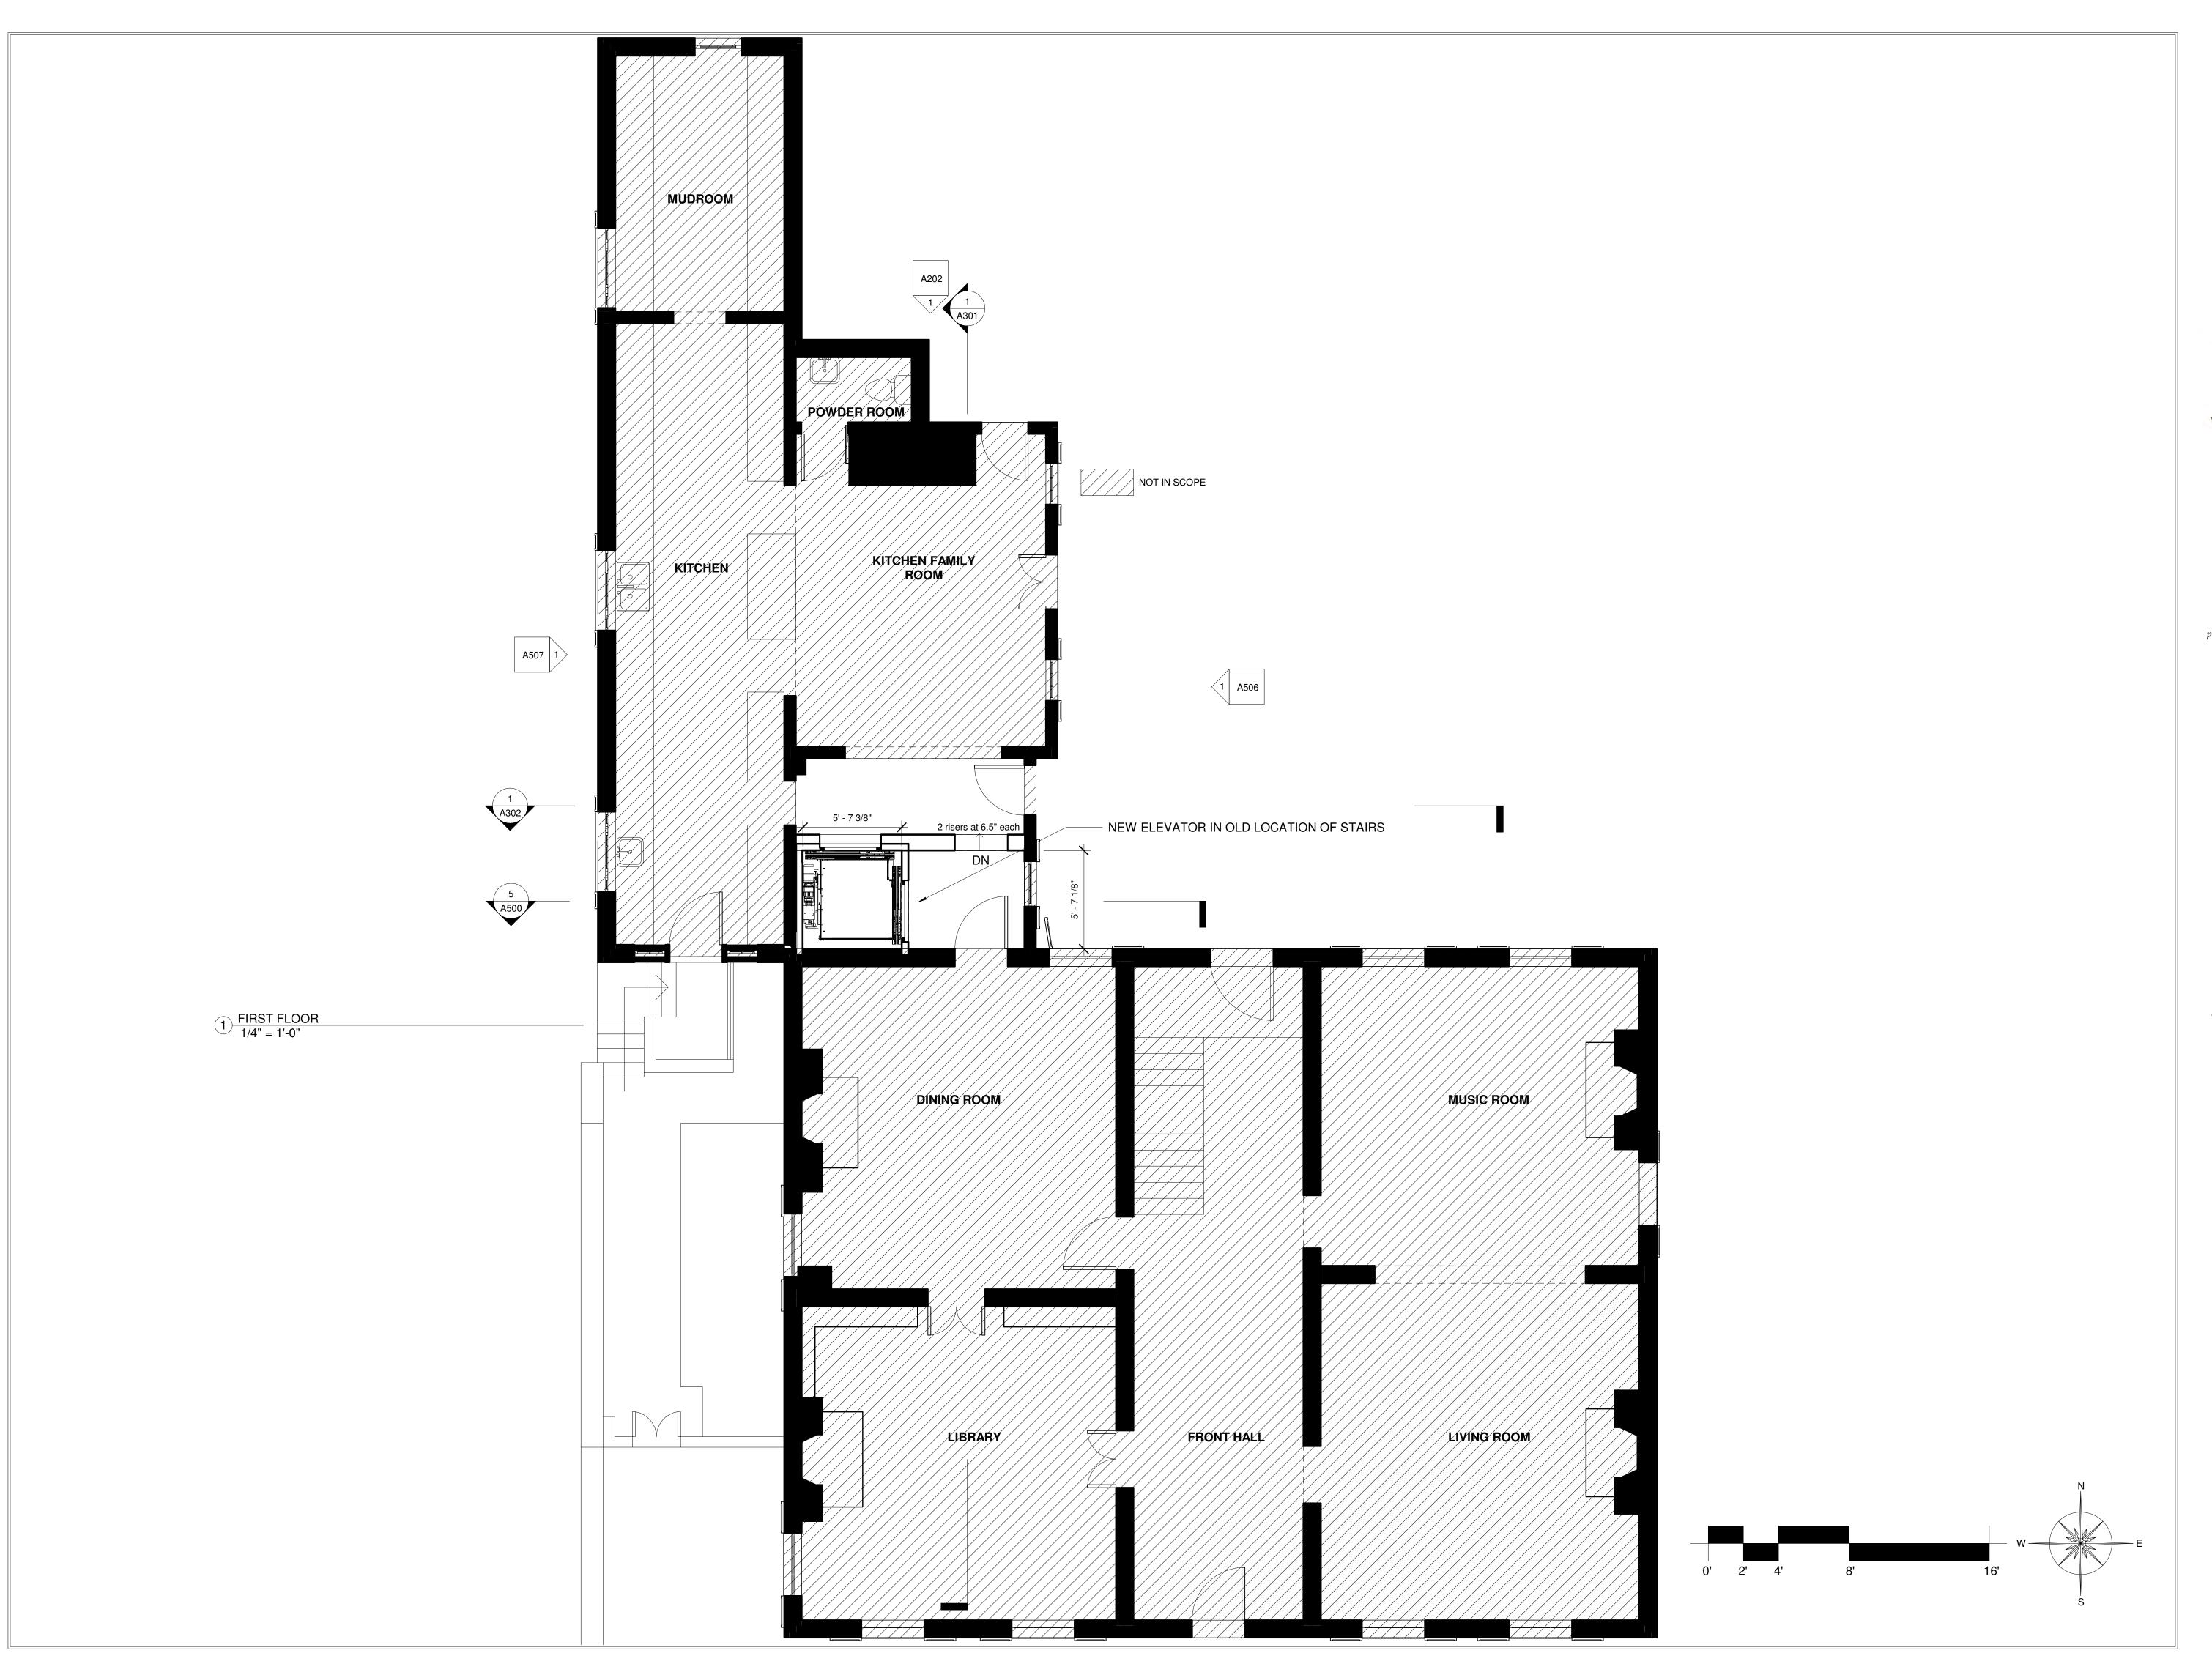
- DRAWING TITLE -

FIRST FLOOR DEMO

- DATE March 11, 2021
- SCALE 1/4" = 1'-0"

- DRAWING TITLE -

A101D



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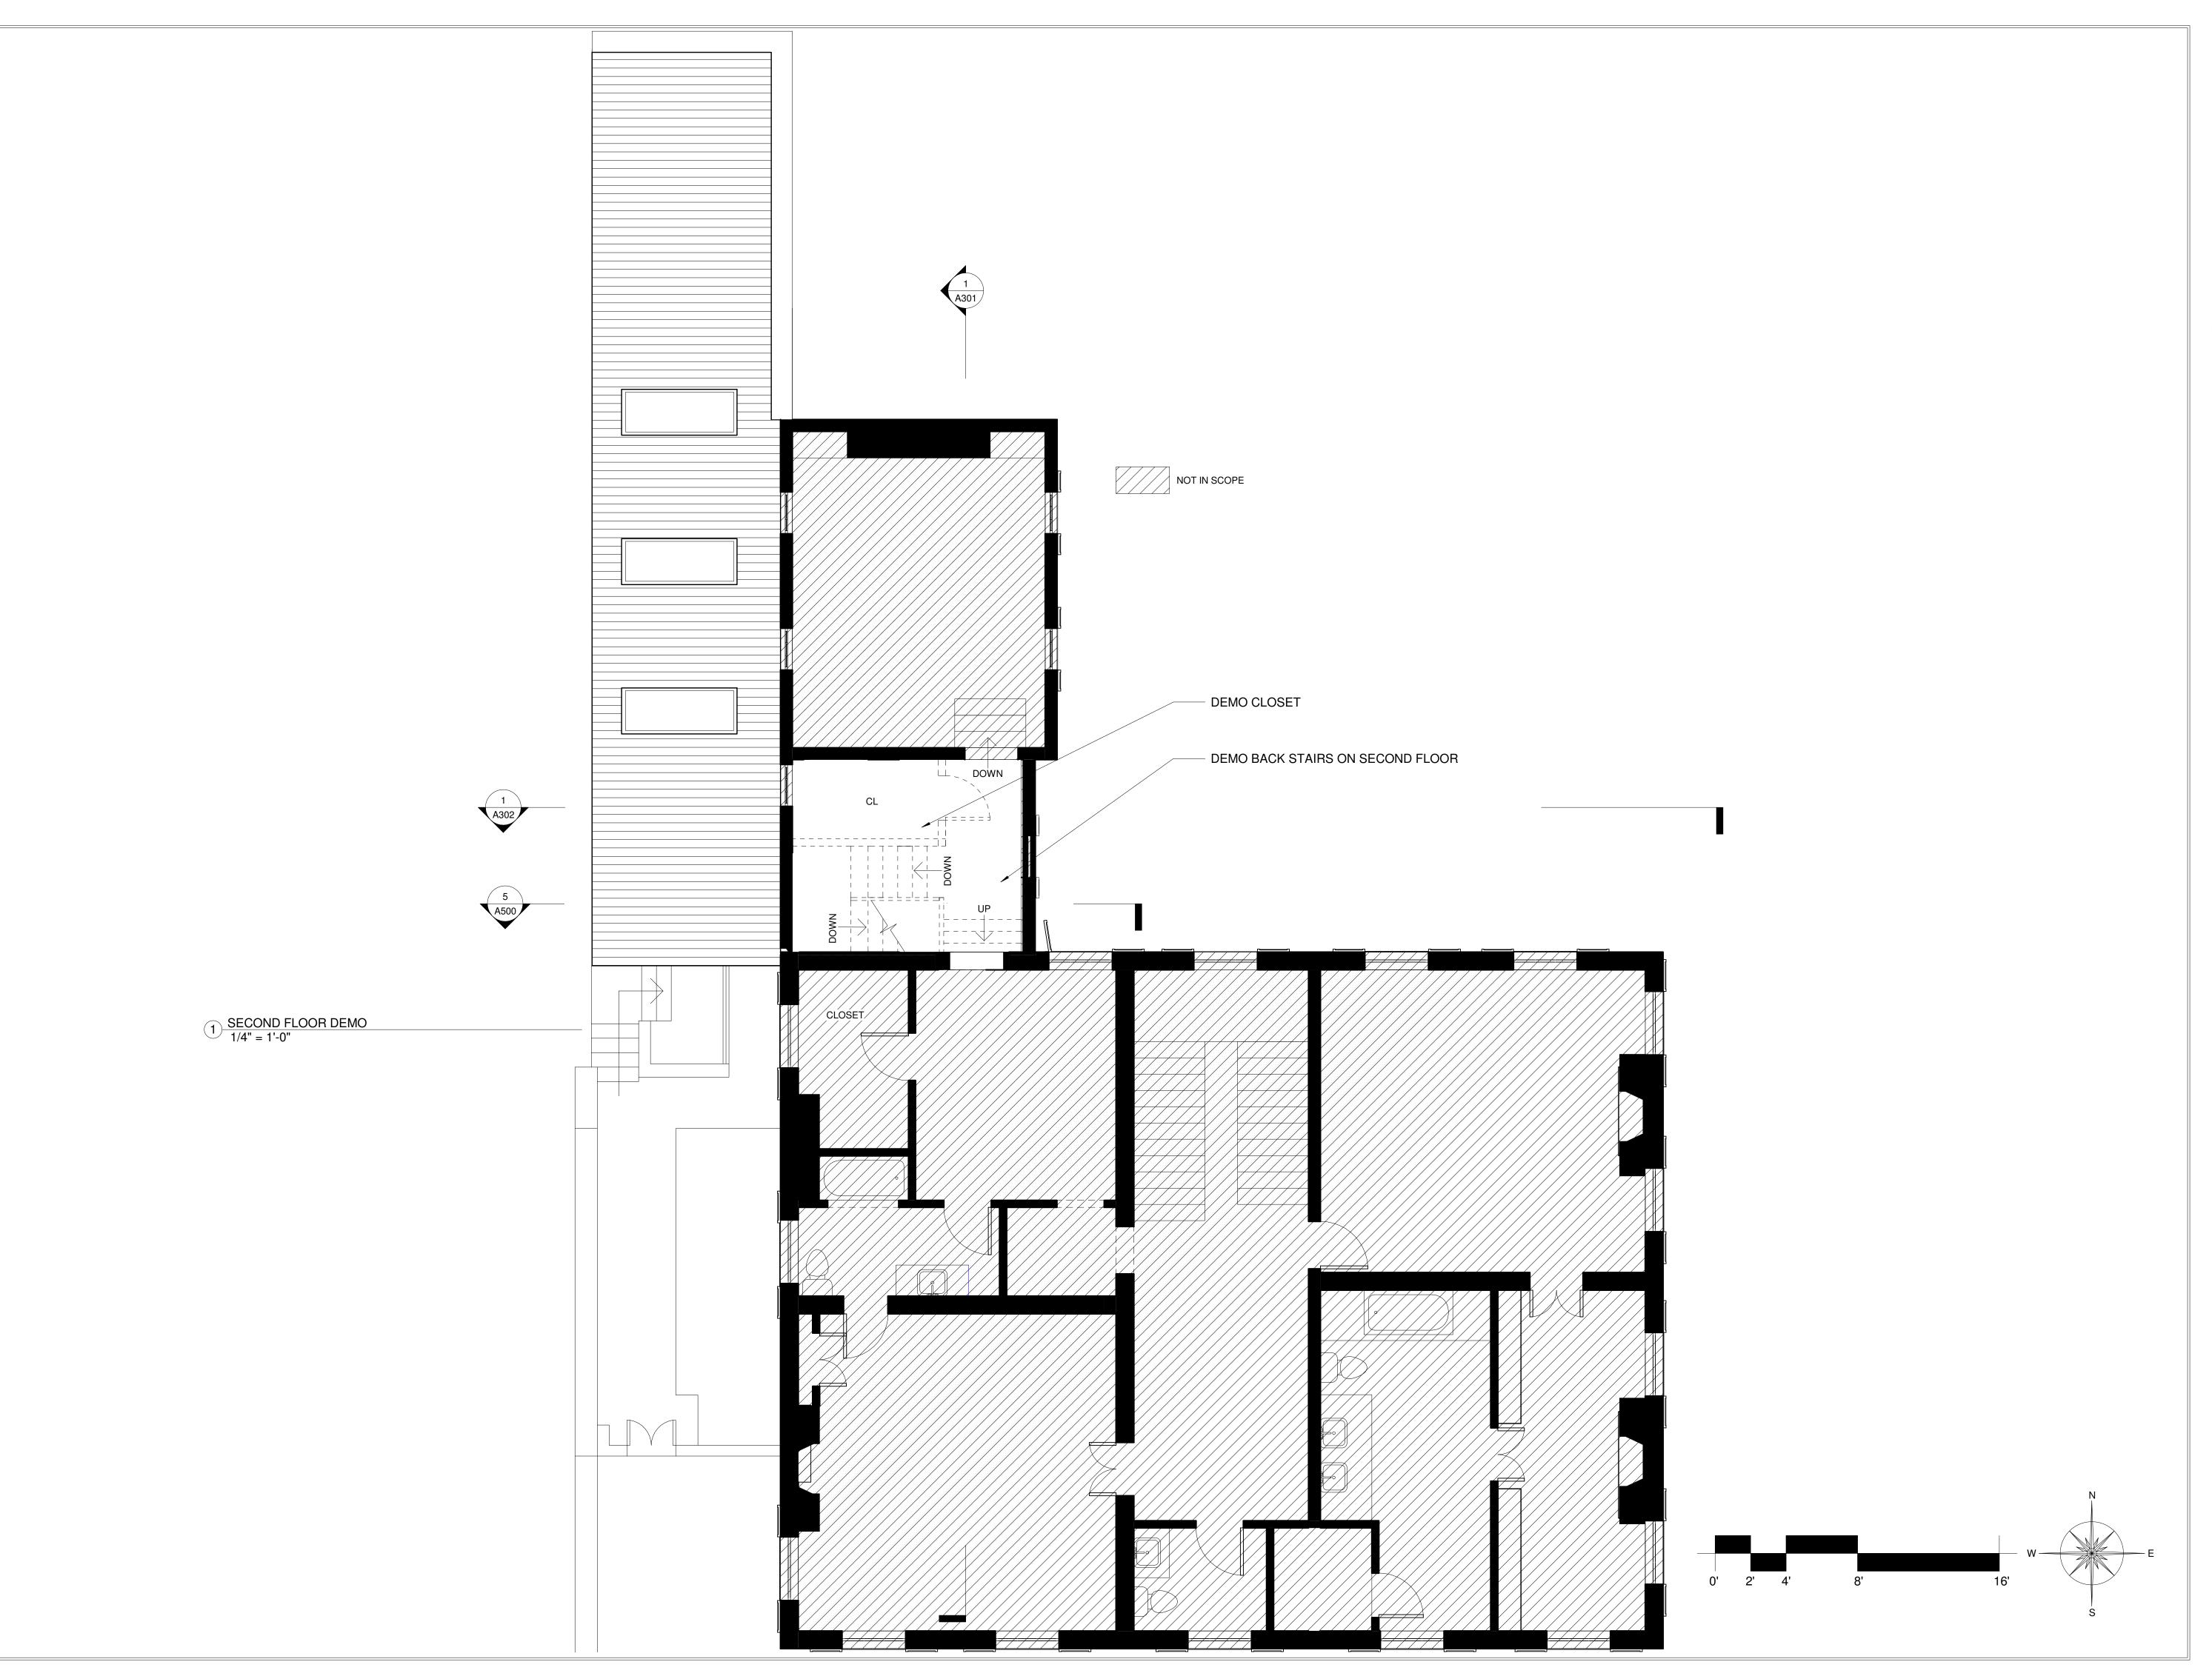
- DRAWING TITLE -

FIRST FLOOR

- DATE -March 11, 2021 - SCALE -1/4" = 1'-0"

- DRAWING TITLE -

A101





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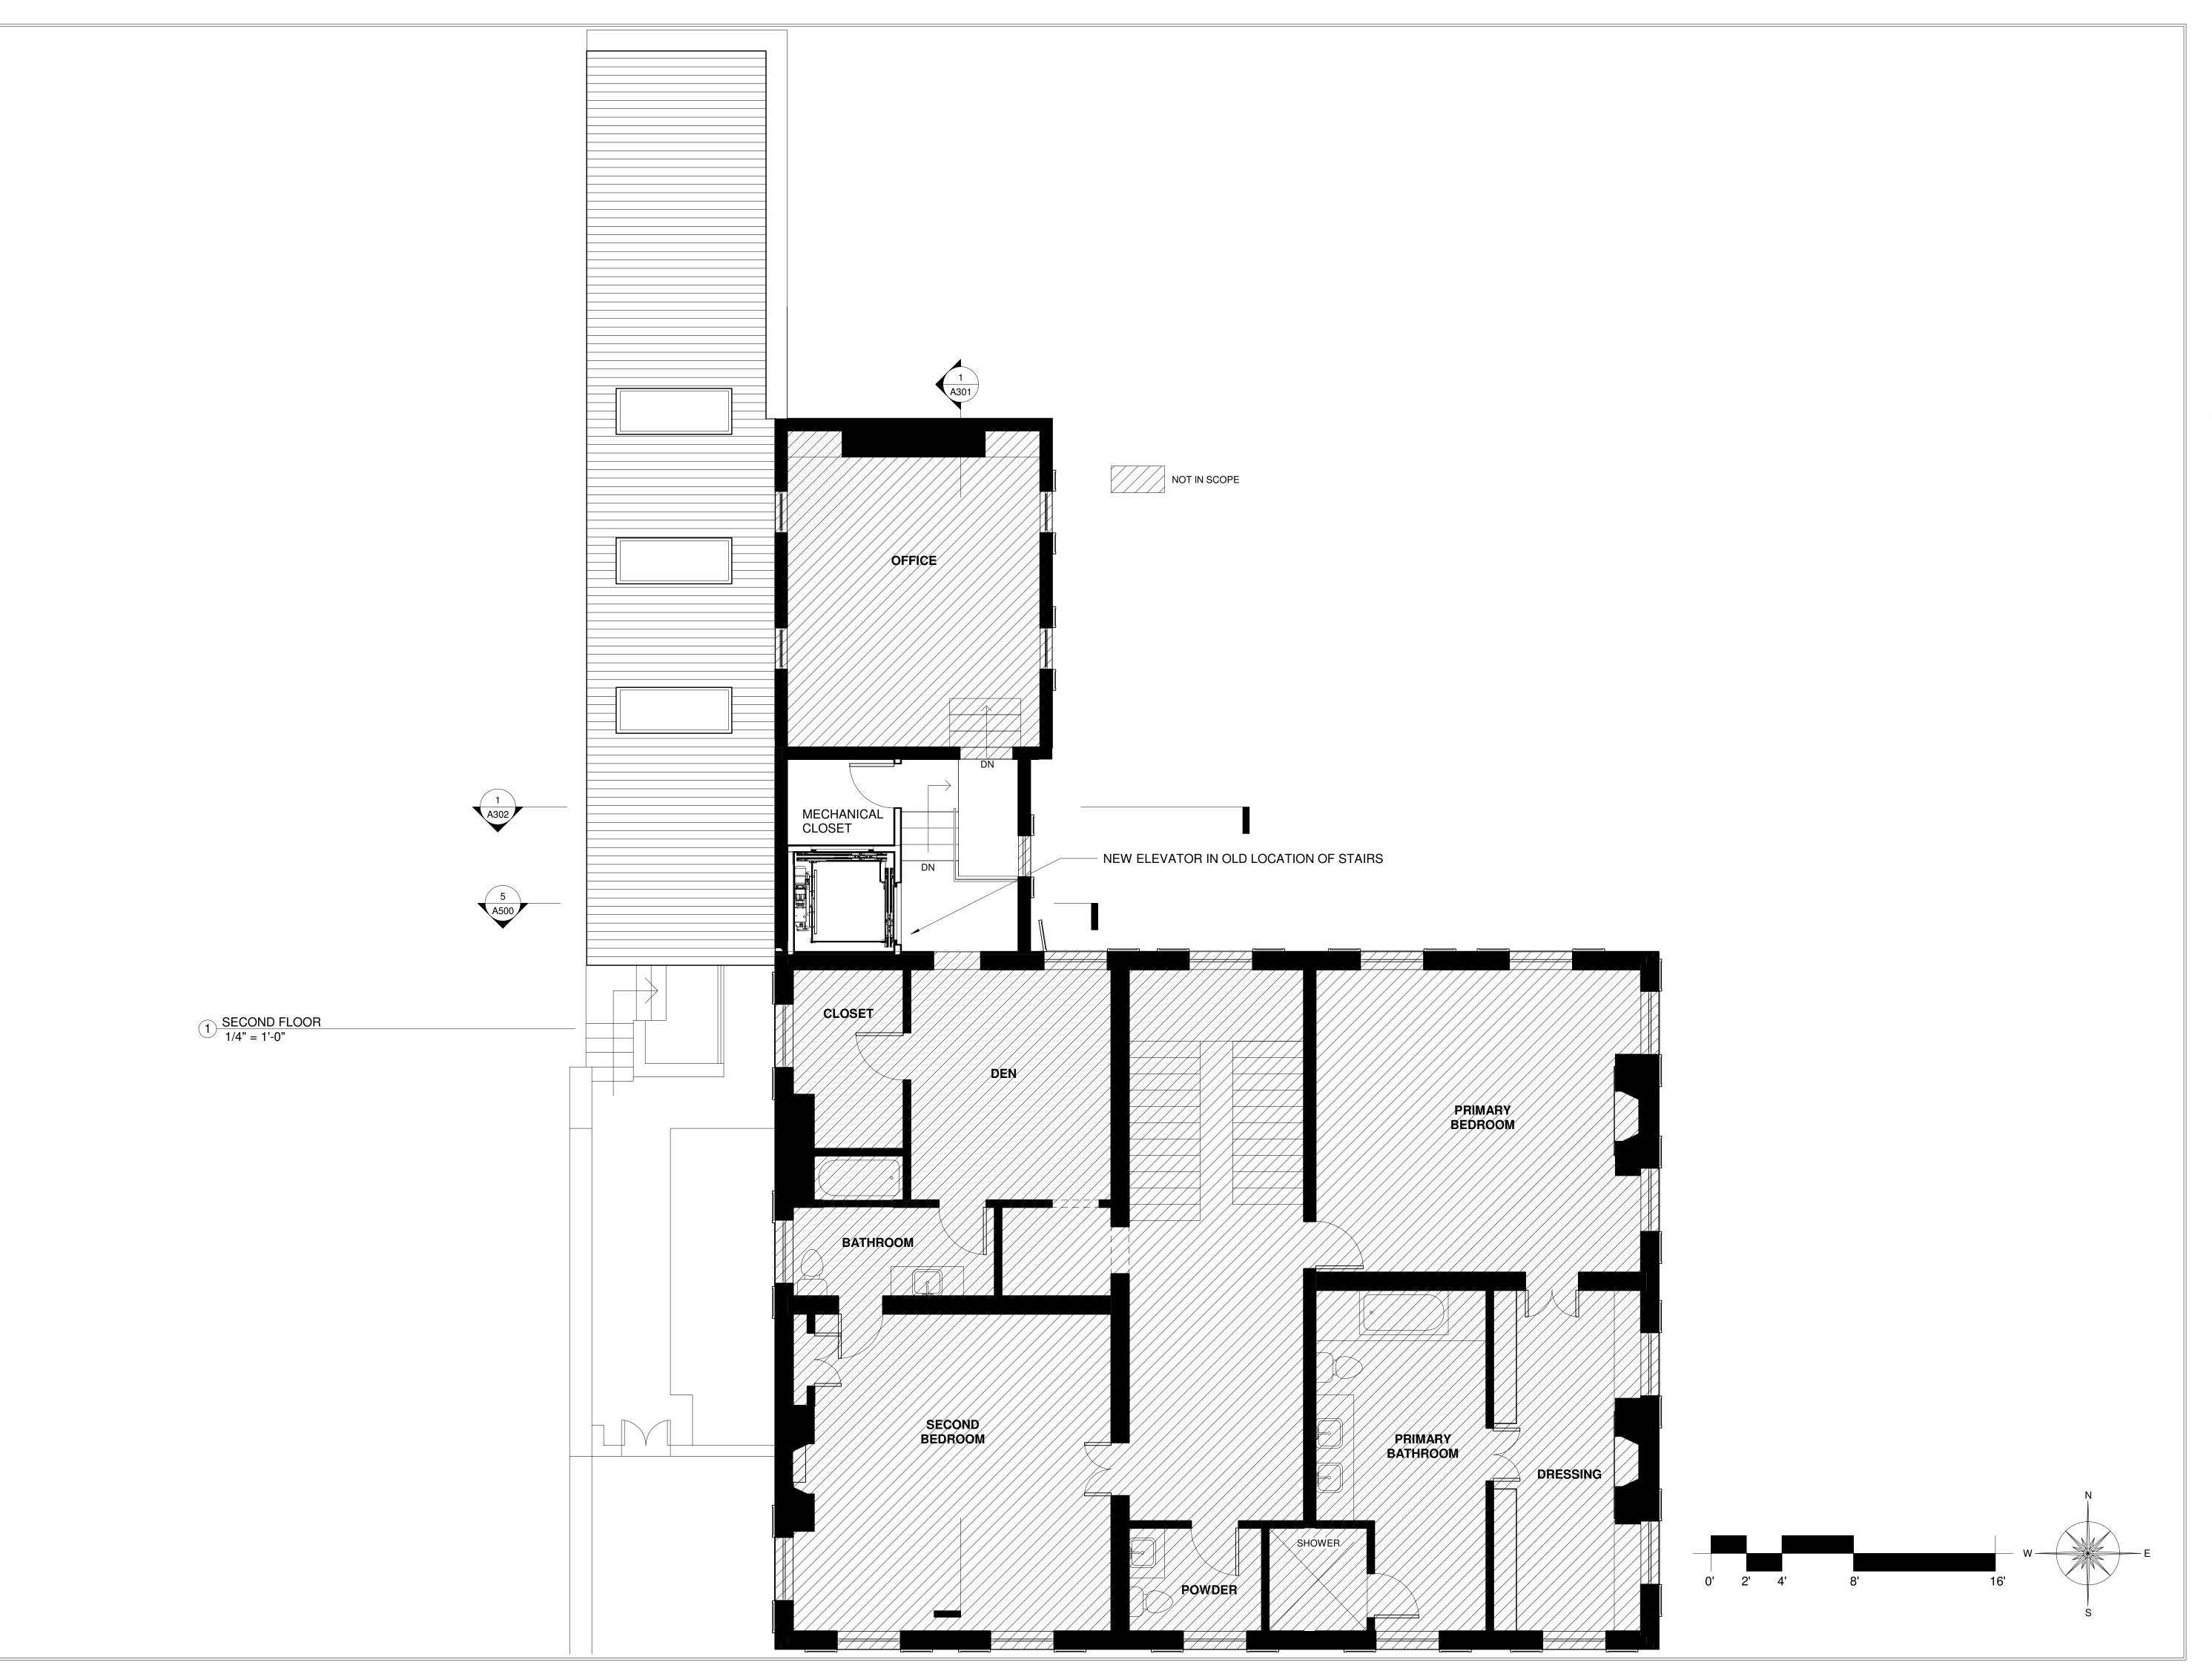
- DRAWING TITLE -

SECOND FLOOR DEMO

- DATE -March 11, 2021 - SCALE -1/4" = 1'-0"

- DRAWING TITLE -

A102D



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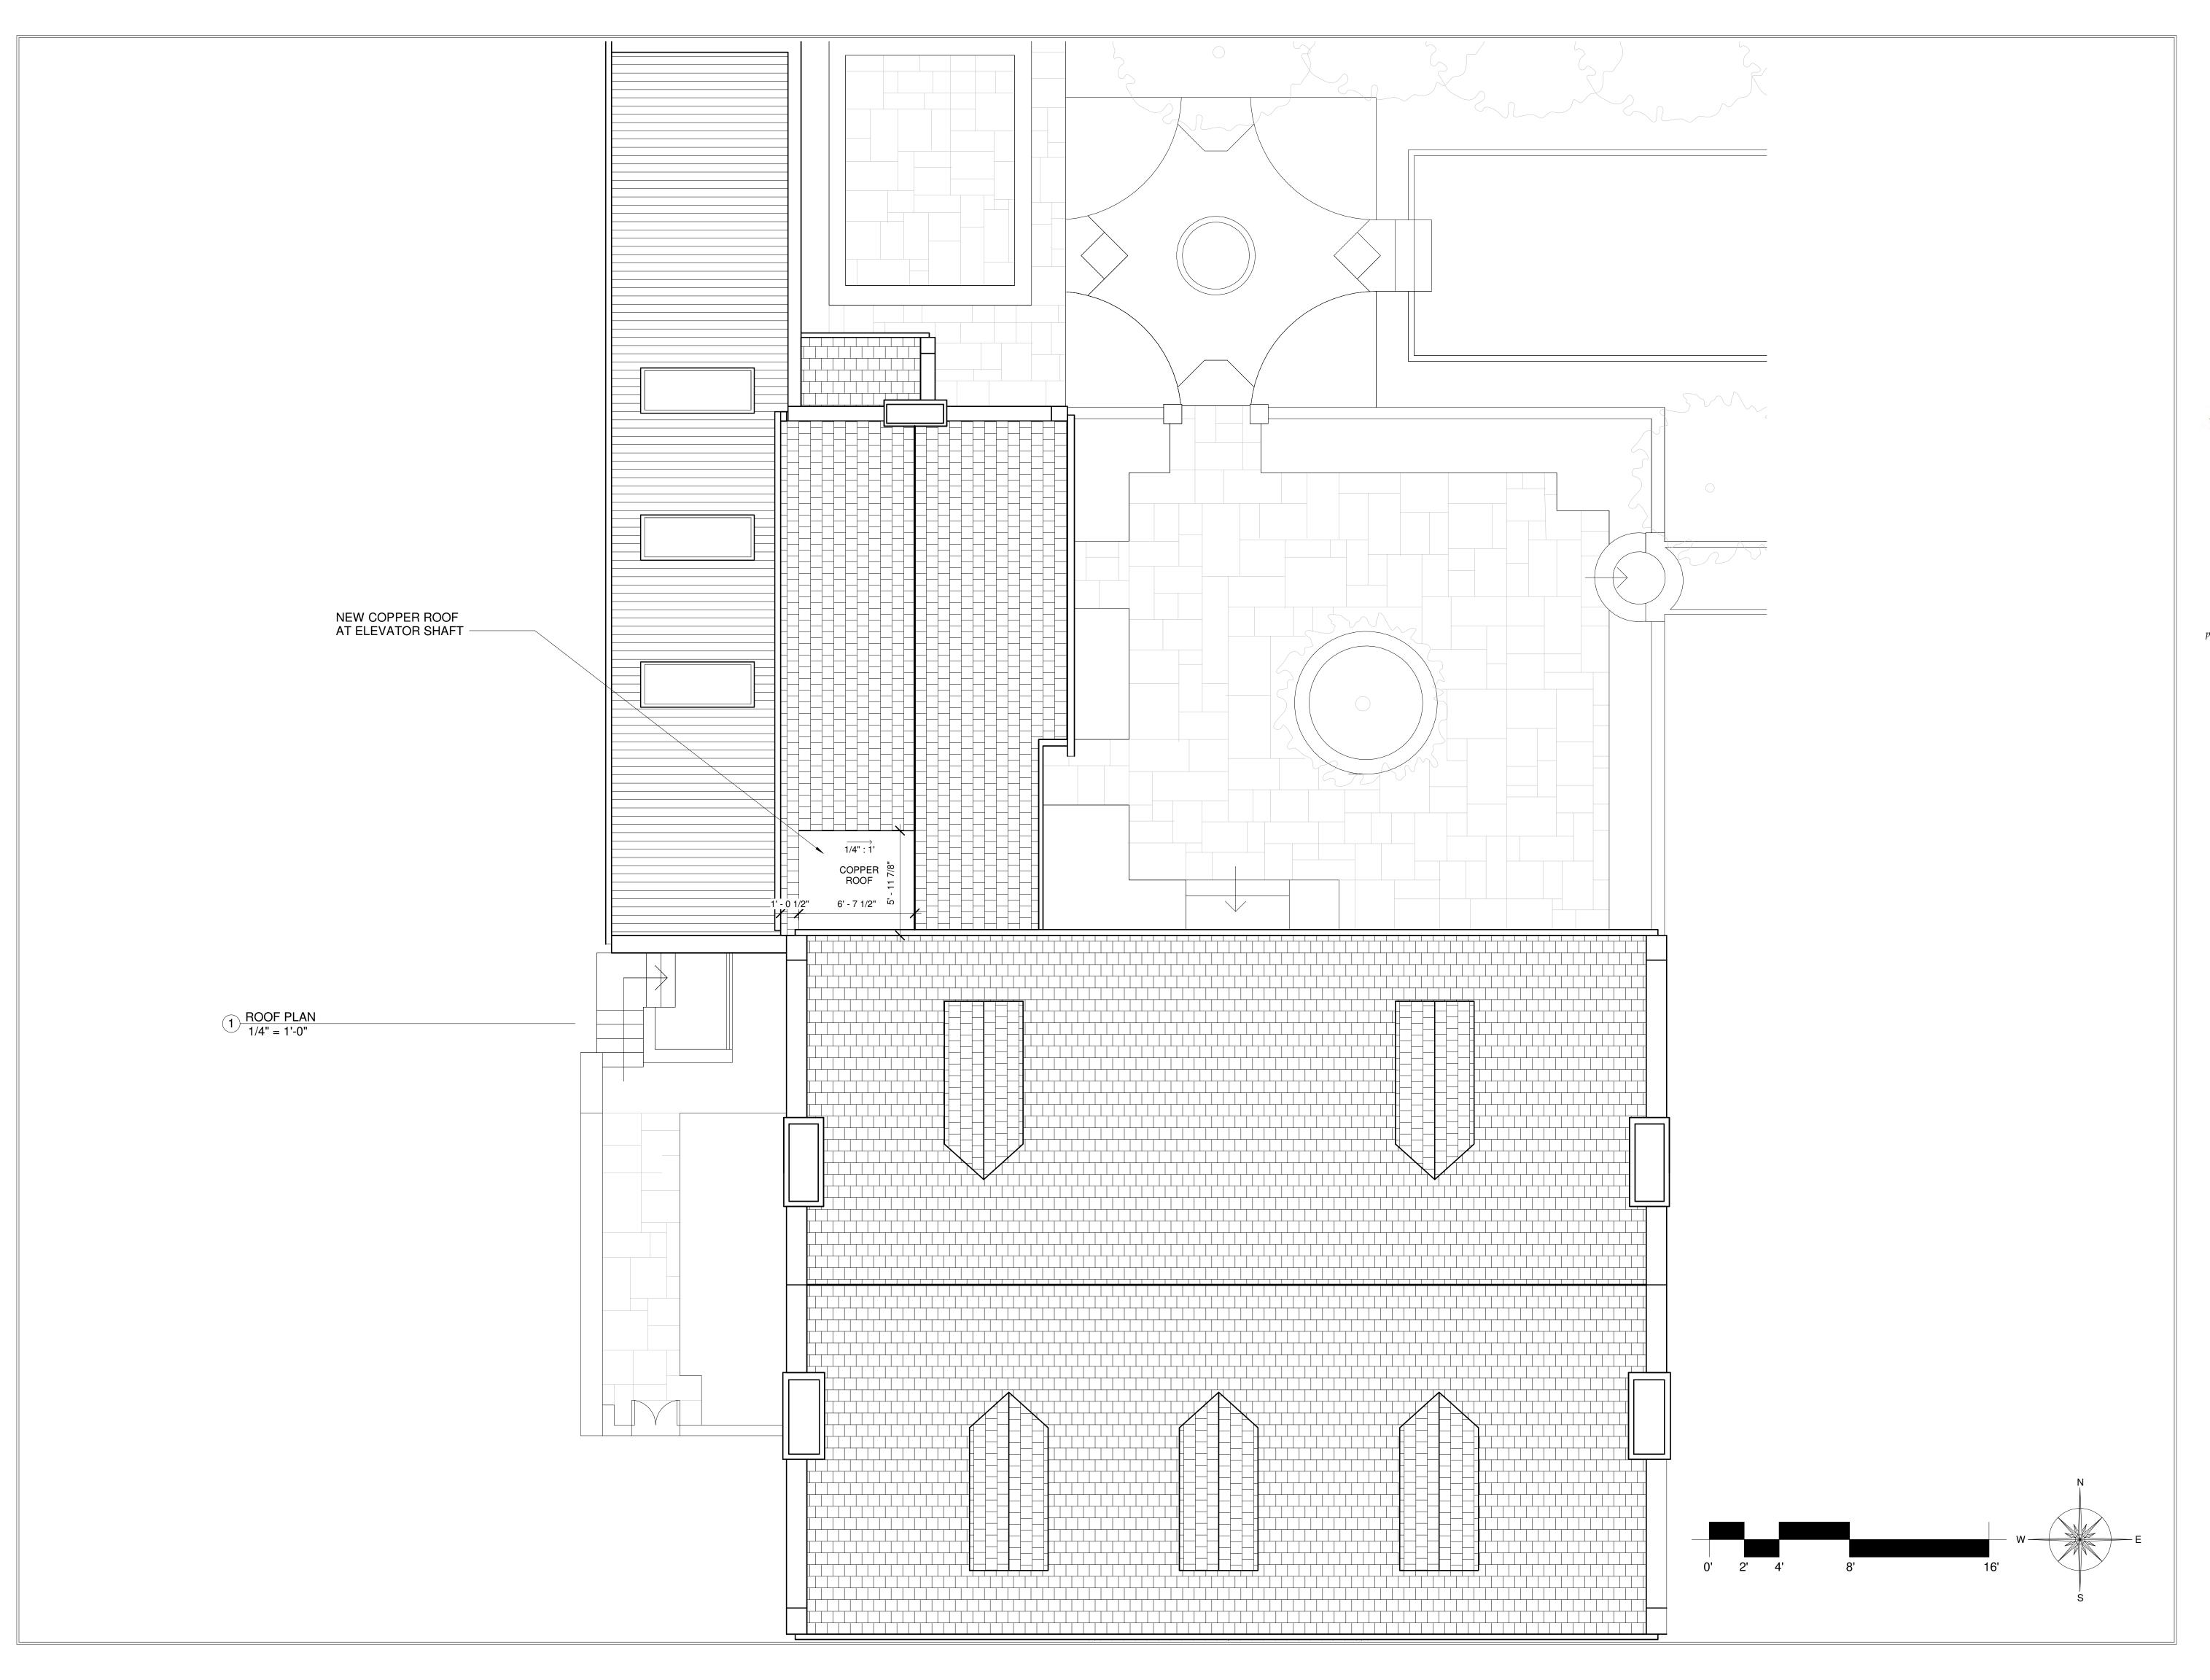
3123 DUMBARTON ST, NW WASHINGTON, DC 20007

- DRAWING TITLE -

SECOND FLOOR

- DATE -March 11, 2021 - SCALE -1/4" = 1'-0" - DRAWING TITLE -

A102





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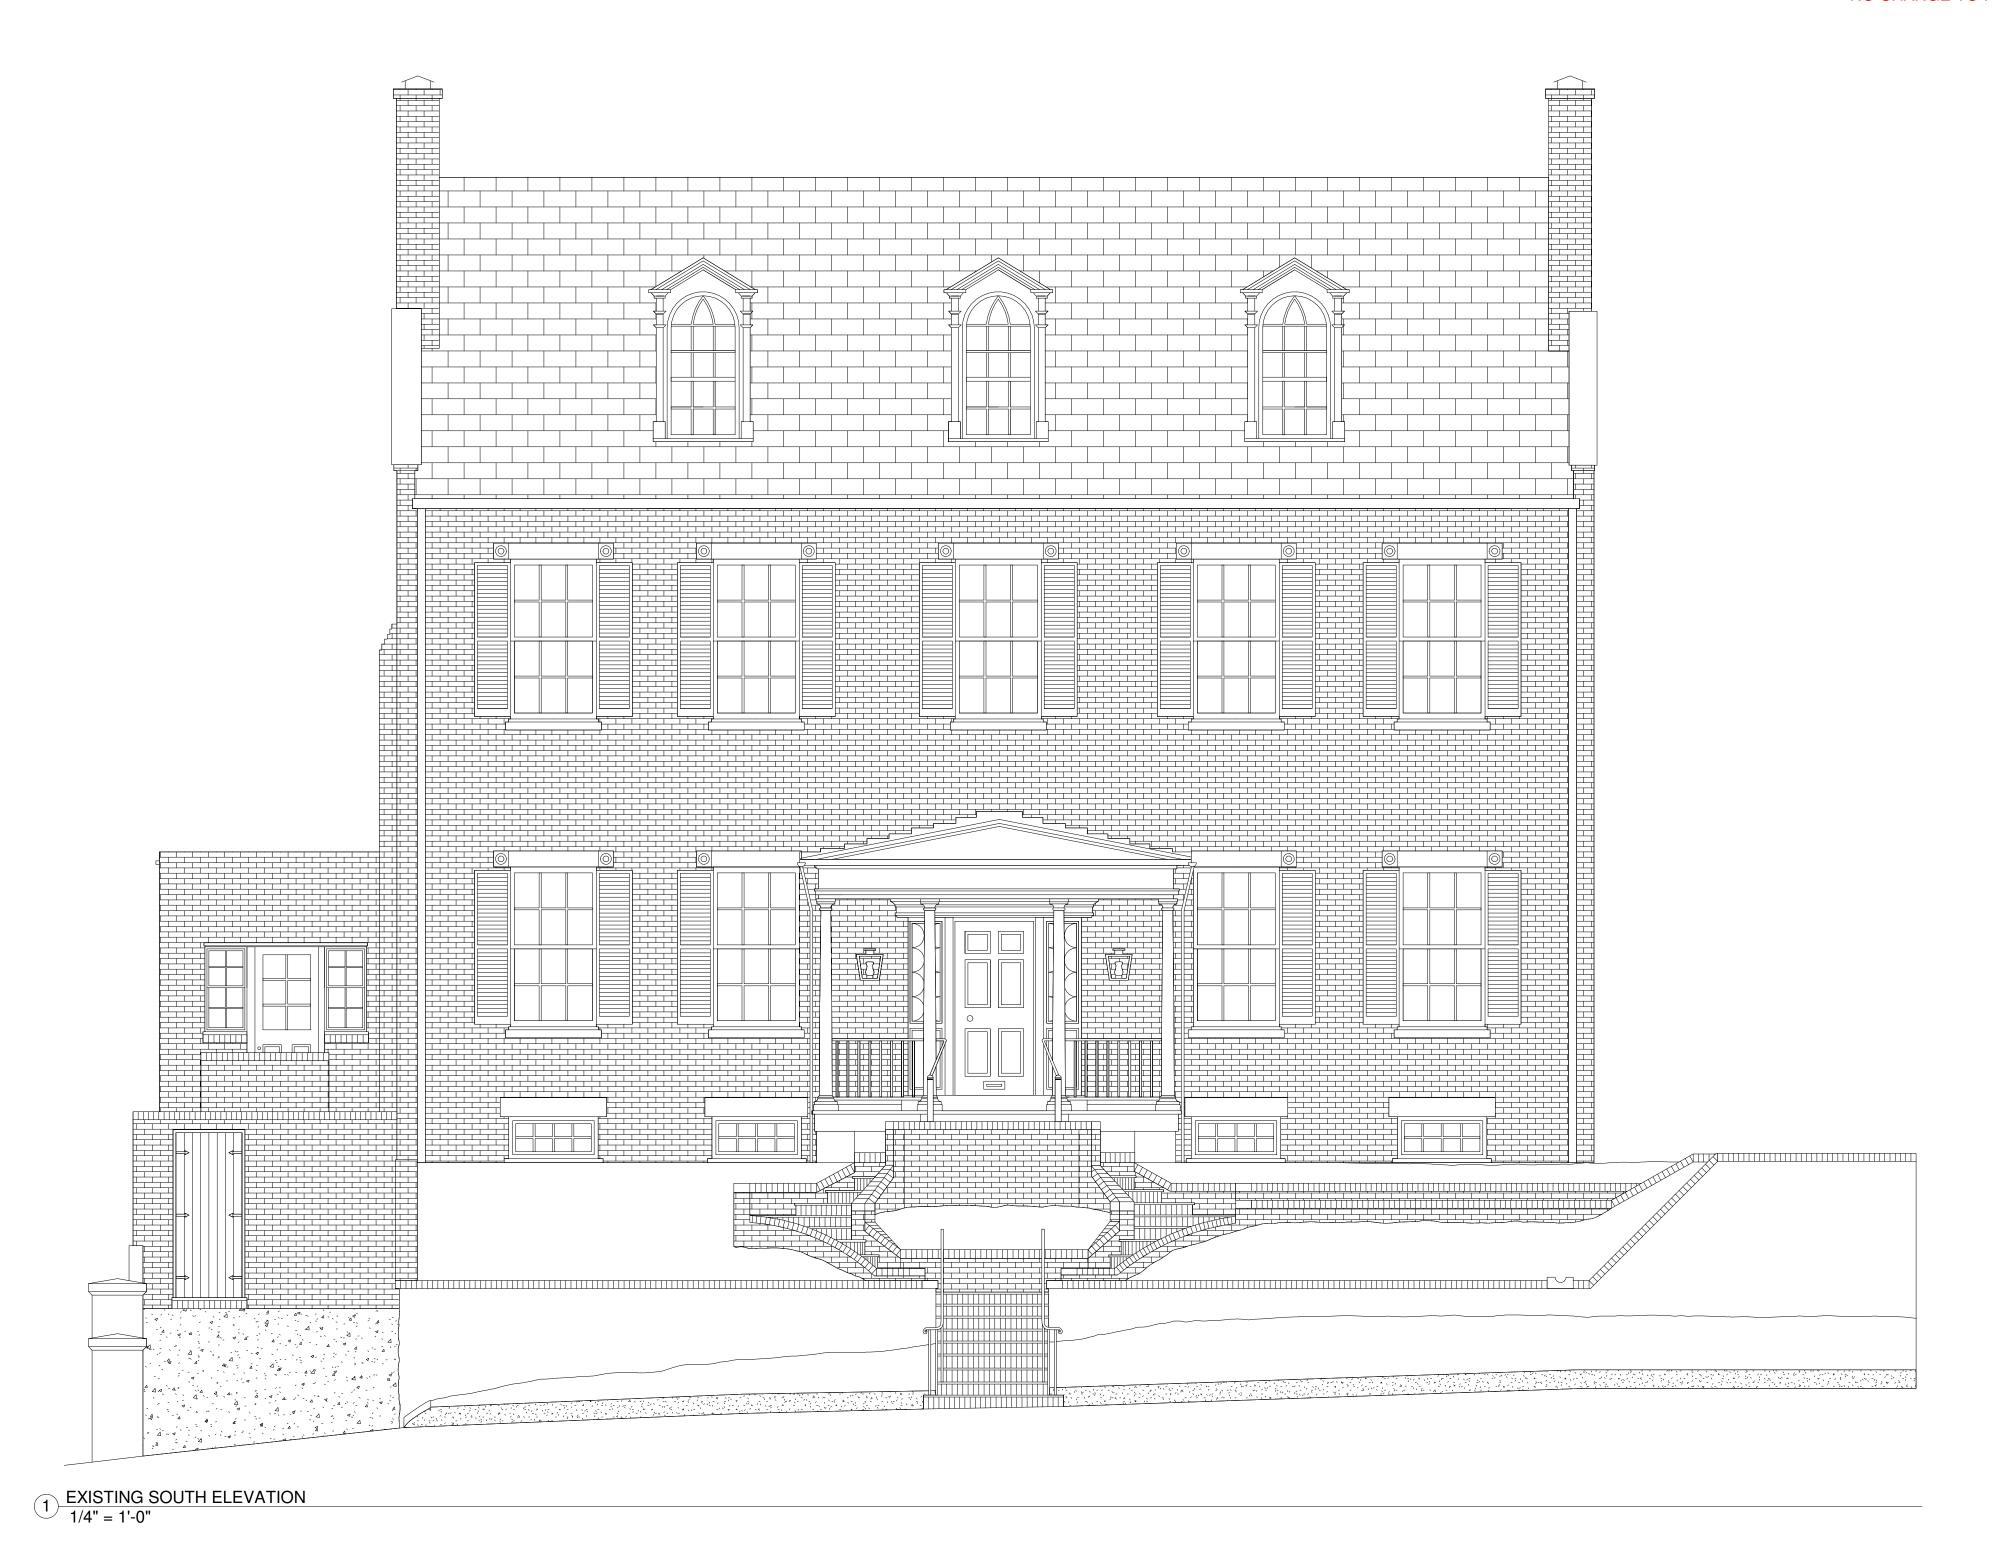
3123 DUMBARTON ST, NW WASHINGTON, DC 20007

- DRAWING TITLE -

ROOF PLAN

- DATE March 11, 2021
- SCALE 1/4" = 1'-0"
- DRAWING TITLE -

A103







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- DRAWING TITLE -


EXTERIOR ELEVATION -SOUTH

- DATE
March 11, 2021

- SCALE
1/4" = 1'-0"

- DRAWING TITLE -

A200

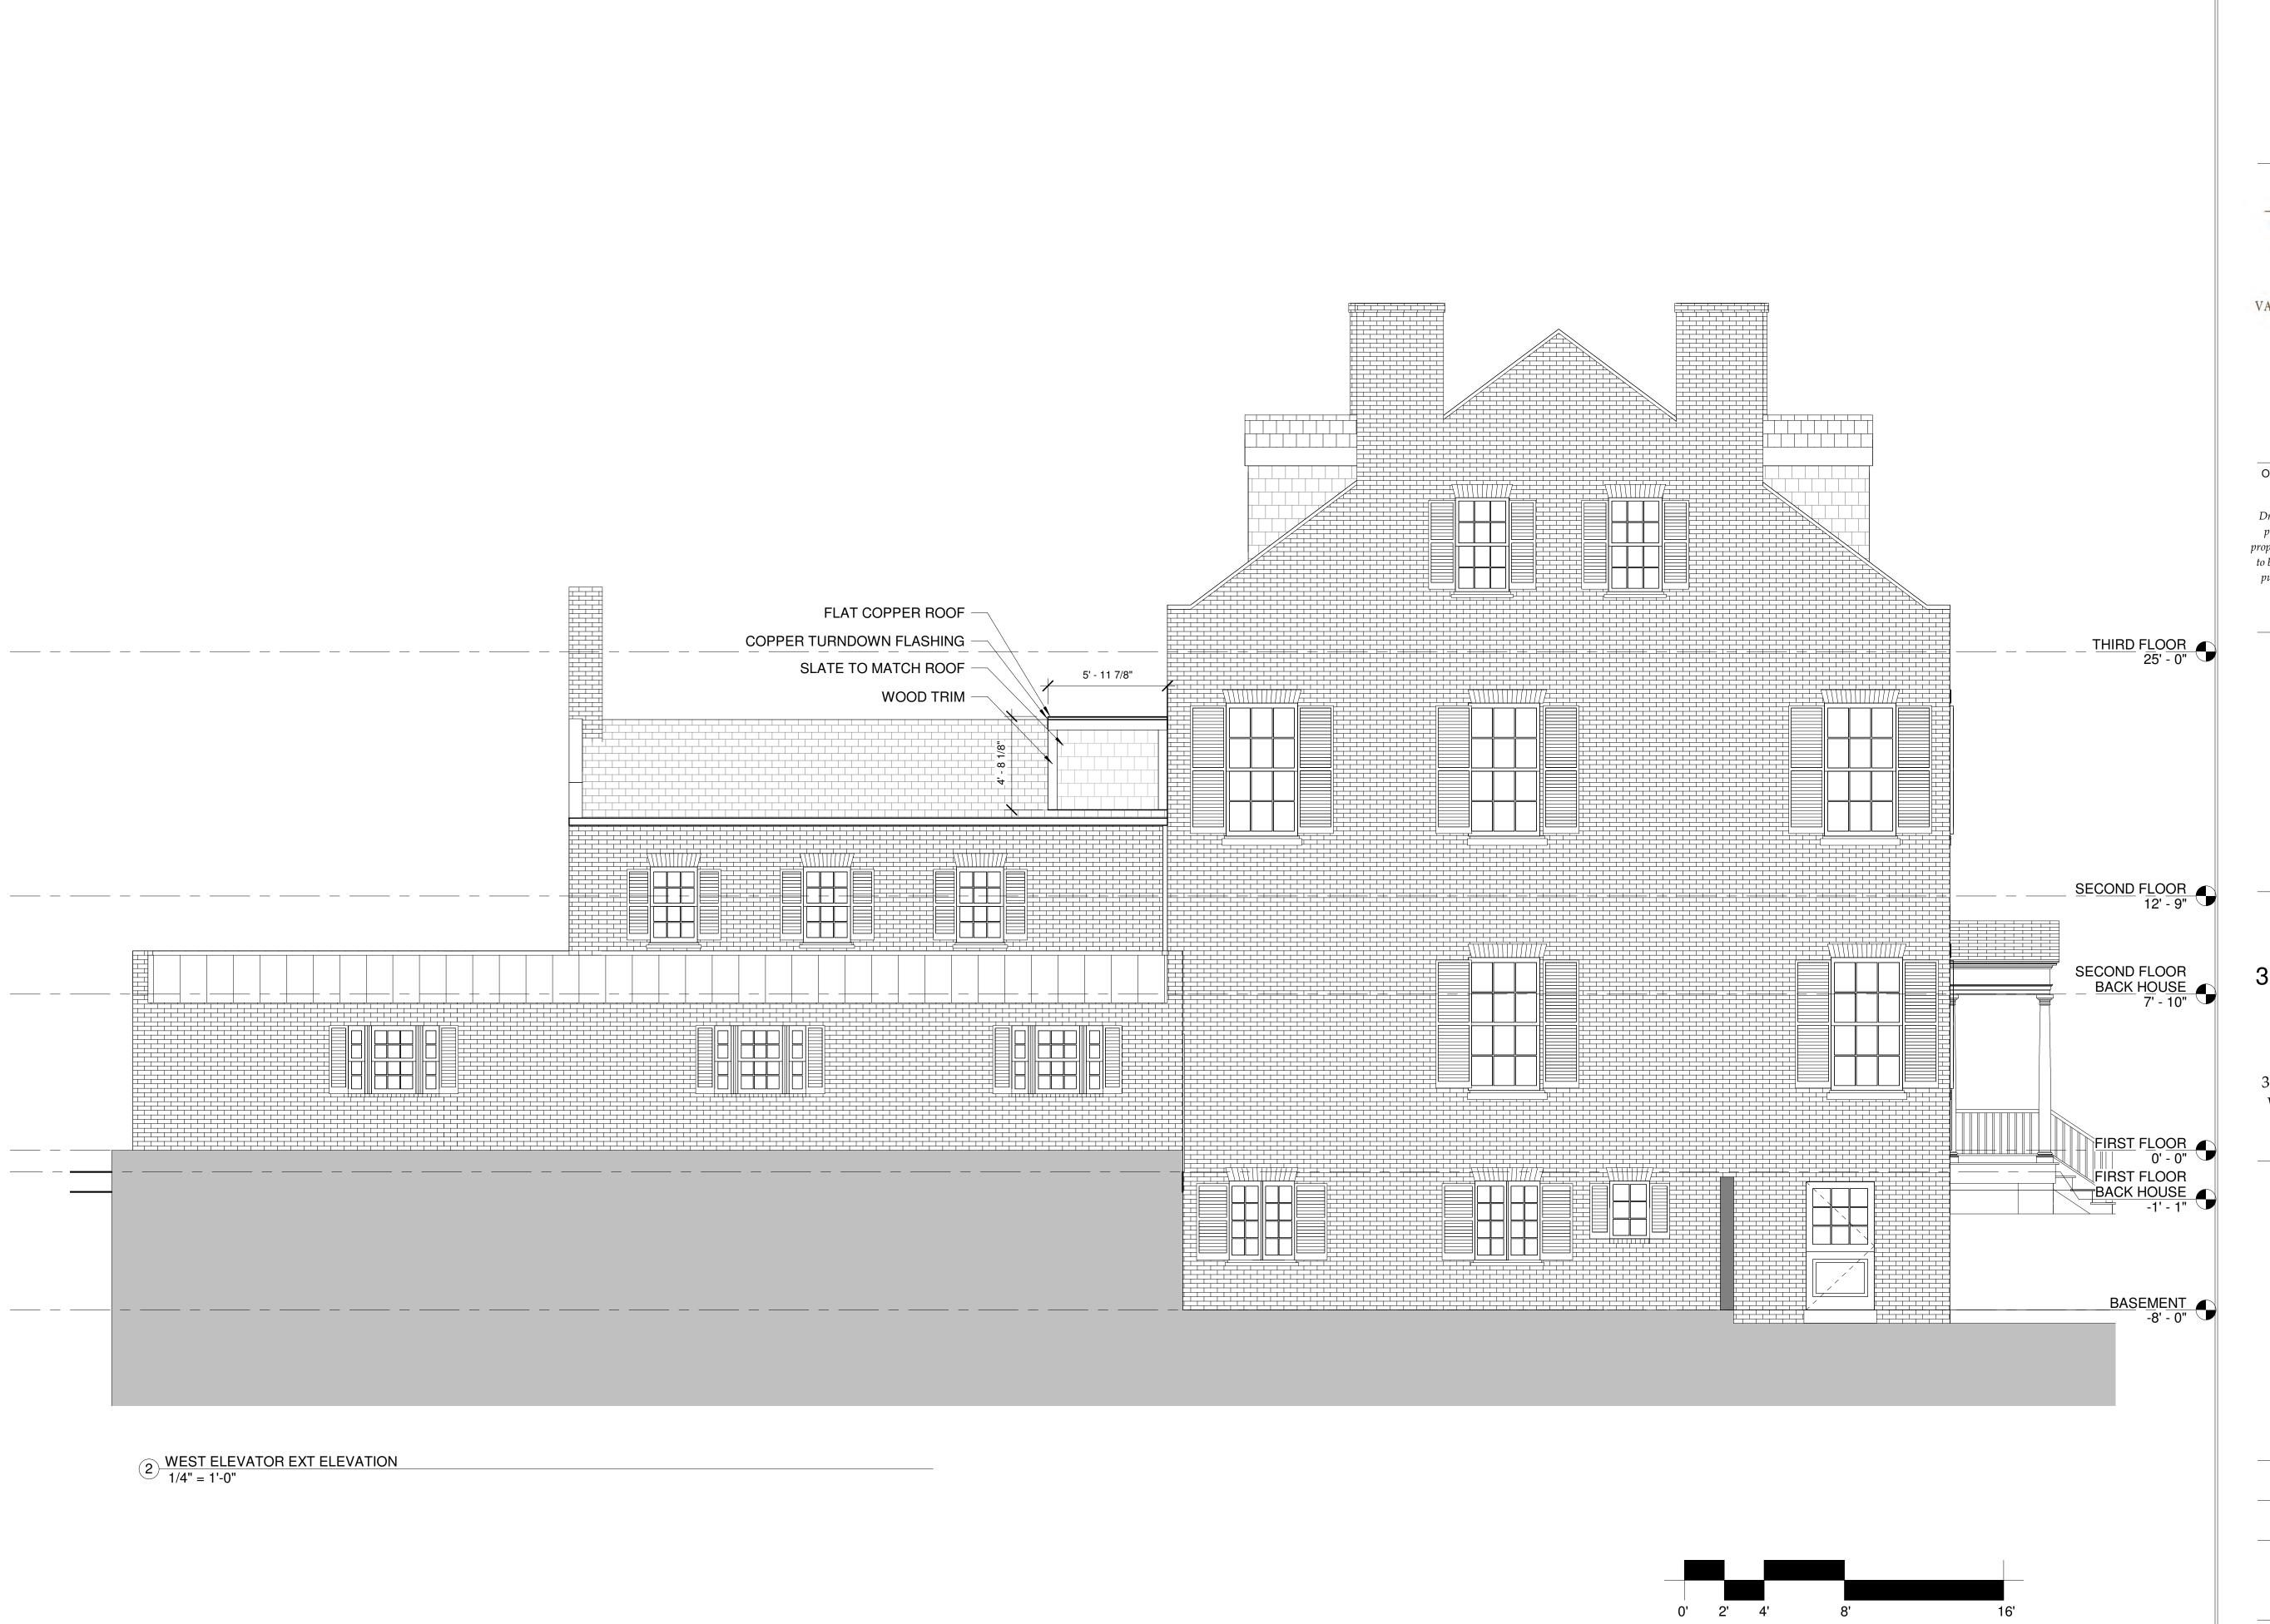

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3123 DUMBARTON STREET


3123 DUMBARTON ST, NW WASHINGTON, DC 20007

- DRAWING TITLE -

EXTERIOR ELEVATION -WEST

- DATE March 11, 2021
- SCALE 1/4" = 1'-0"
- DRAWING TITLE -

A201

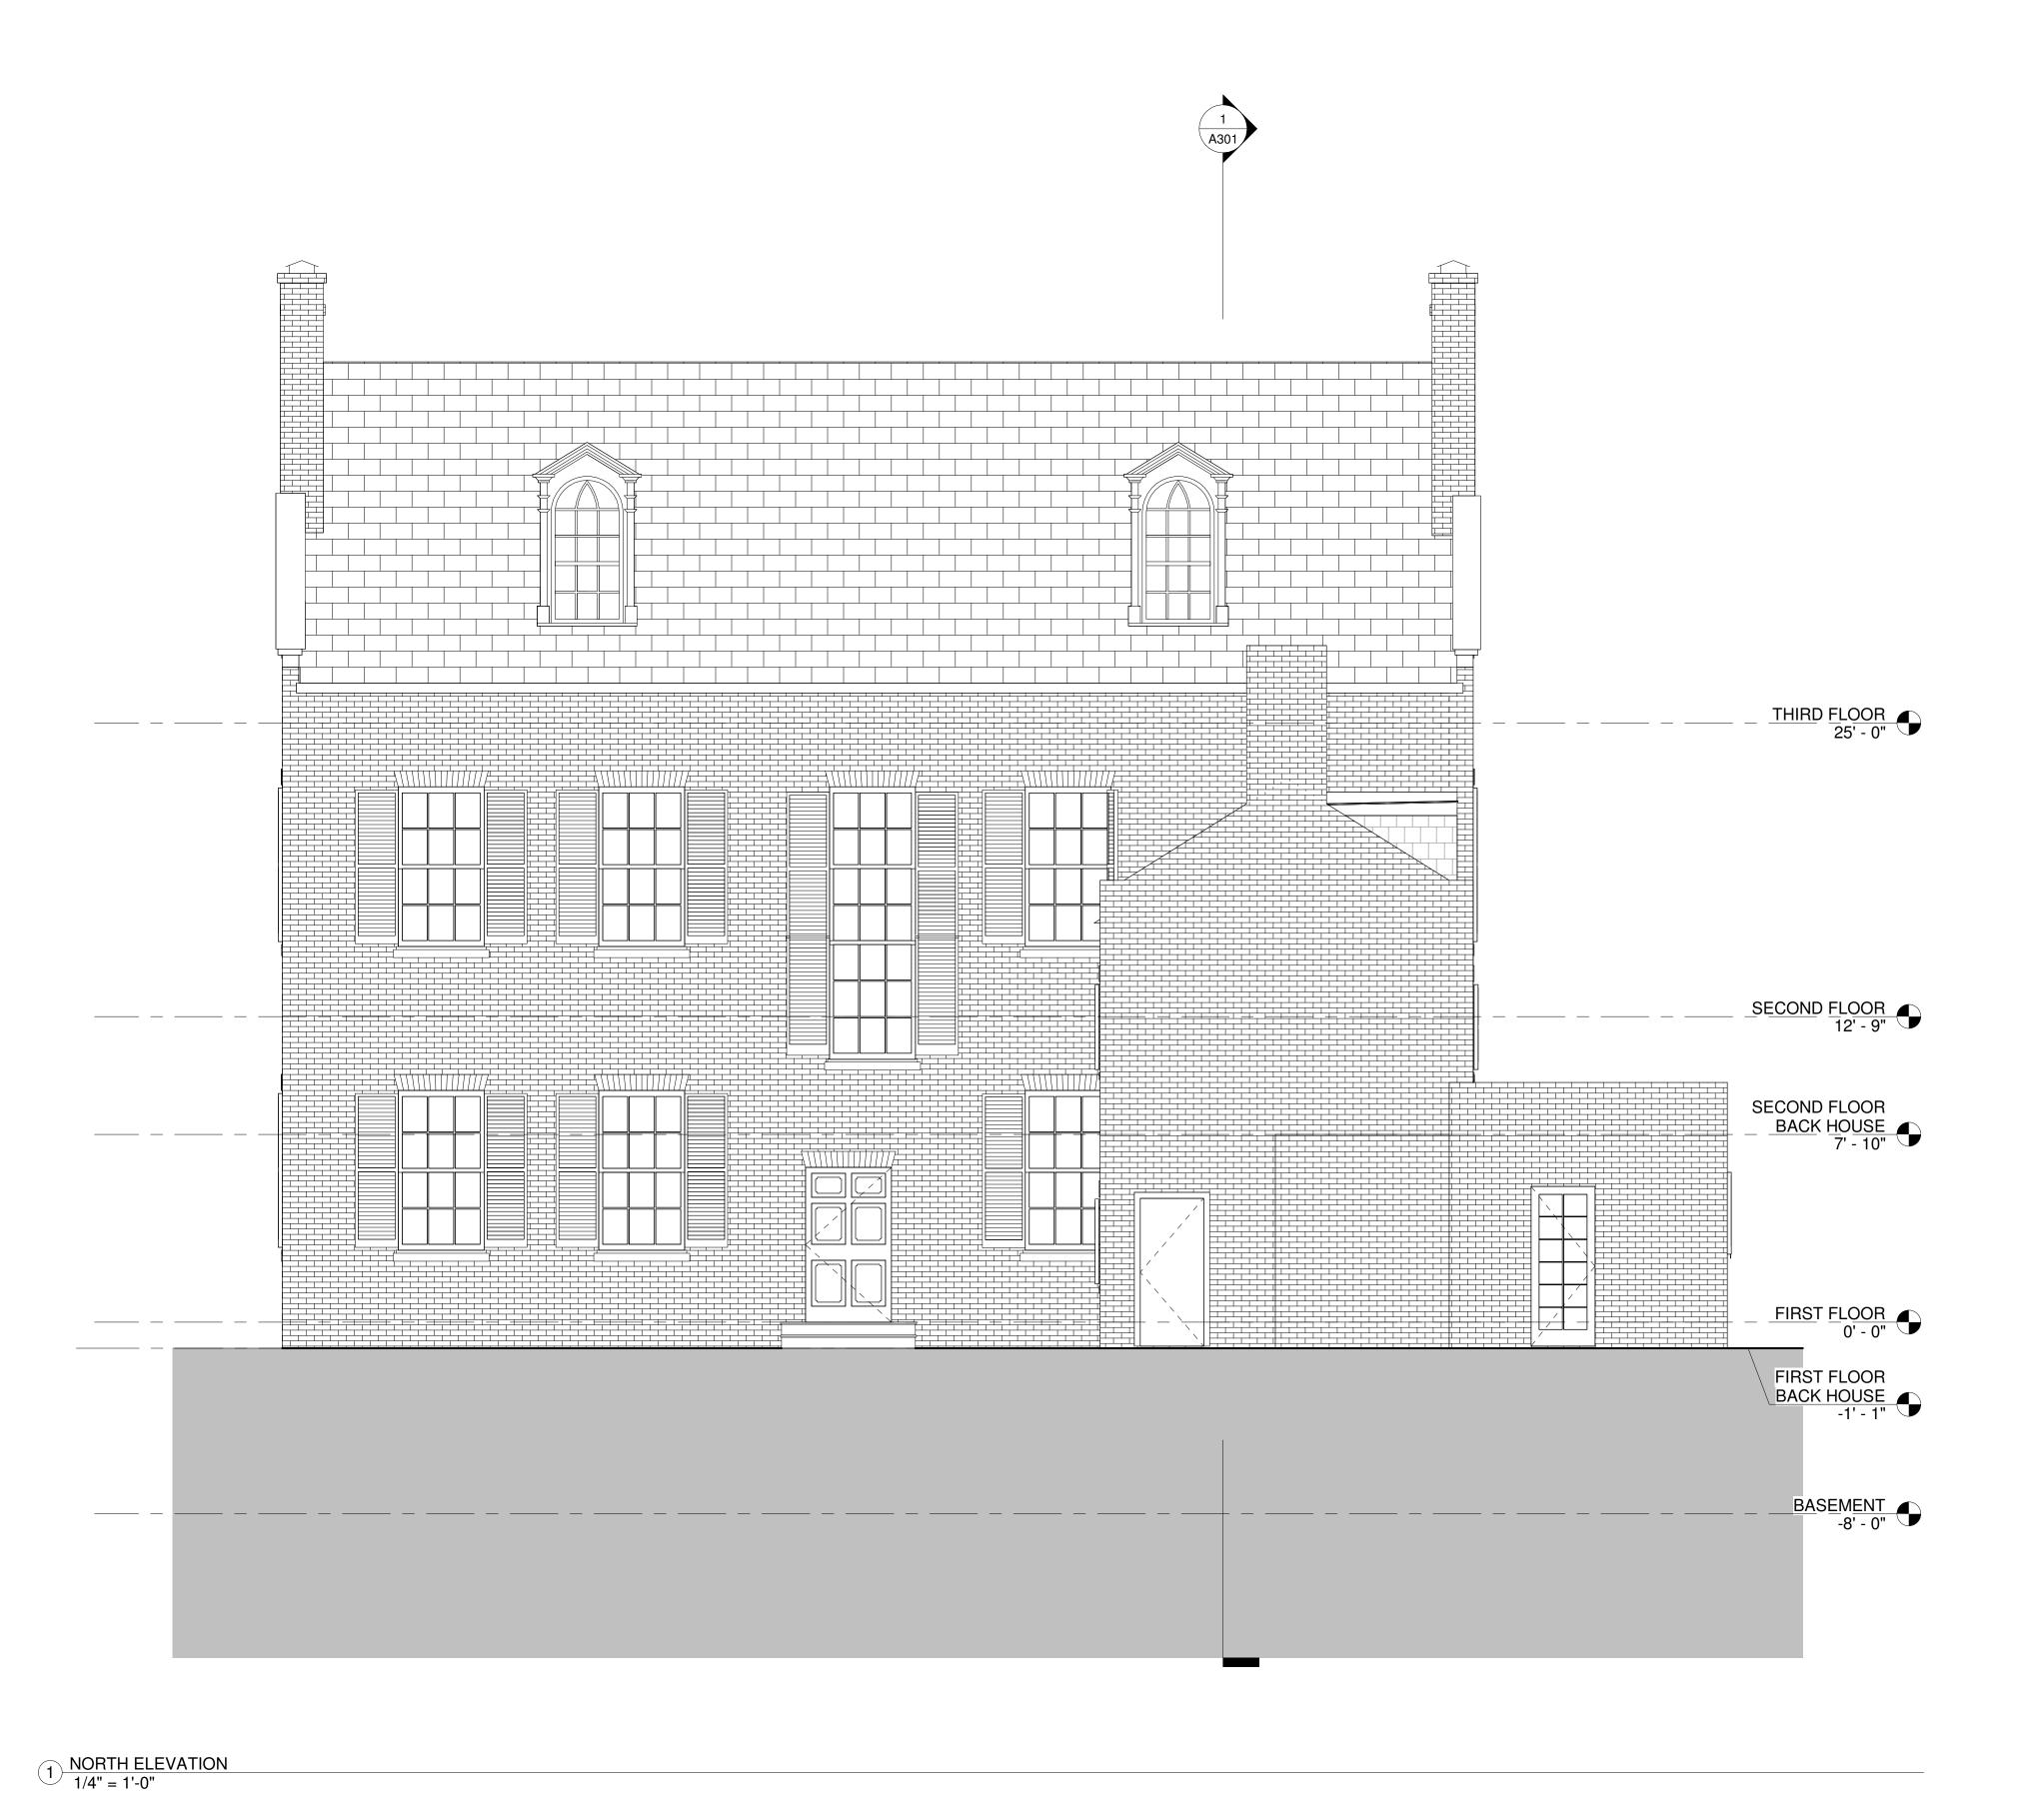





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- DRAWING TITLE -

EXTERIOR ELEVATION -NORTH

- DATE -March 11, 2021 - SCALE -1/4" = 1'-0" - DRAWING TITLE -

A202



1) East 1/4" = 1'-0"



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3123 DUMBARTON STREET


3123 DUMBARTON ST, NW WASHINGTON, DC 20007

- DRAWING TITLE -

EXTERIOR ELEVATION -EAST

- DATE March 11, 2021
- SCALE 1/4" = 1'-0"
- DRAWING TITLE -

A203

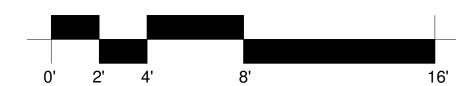



1 BUILDING SECTION 1 1/4" = 1'-0"

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3123 DUMBARTON STREET


3123 DUMBARTON ST, NW WASHINGTON, DC 20007

- DRAWING TITLE -

BUILDING SECTION

- DATE March 11, 2021
- SCALE 1/4" = 1'-0"
- DRAWING TITLE -

A301

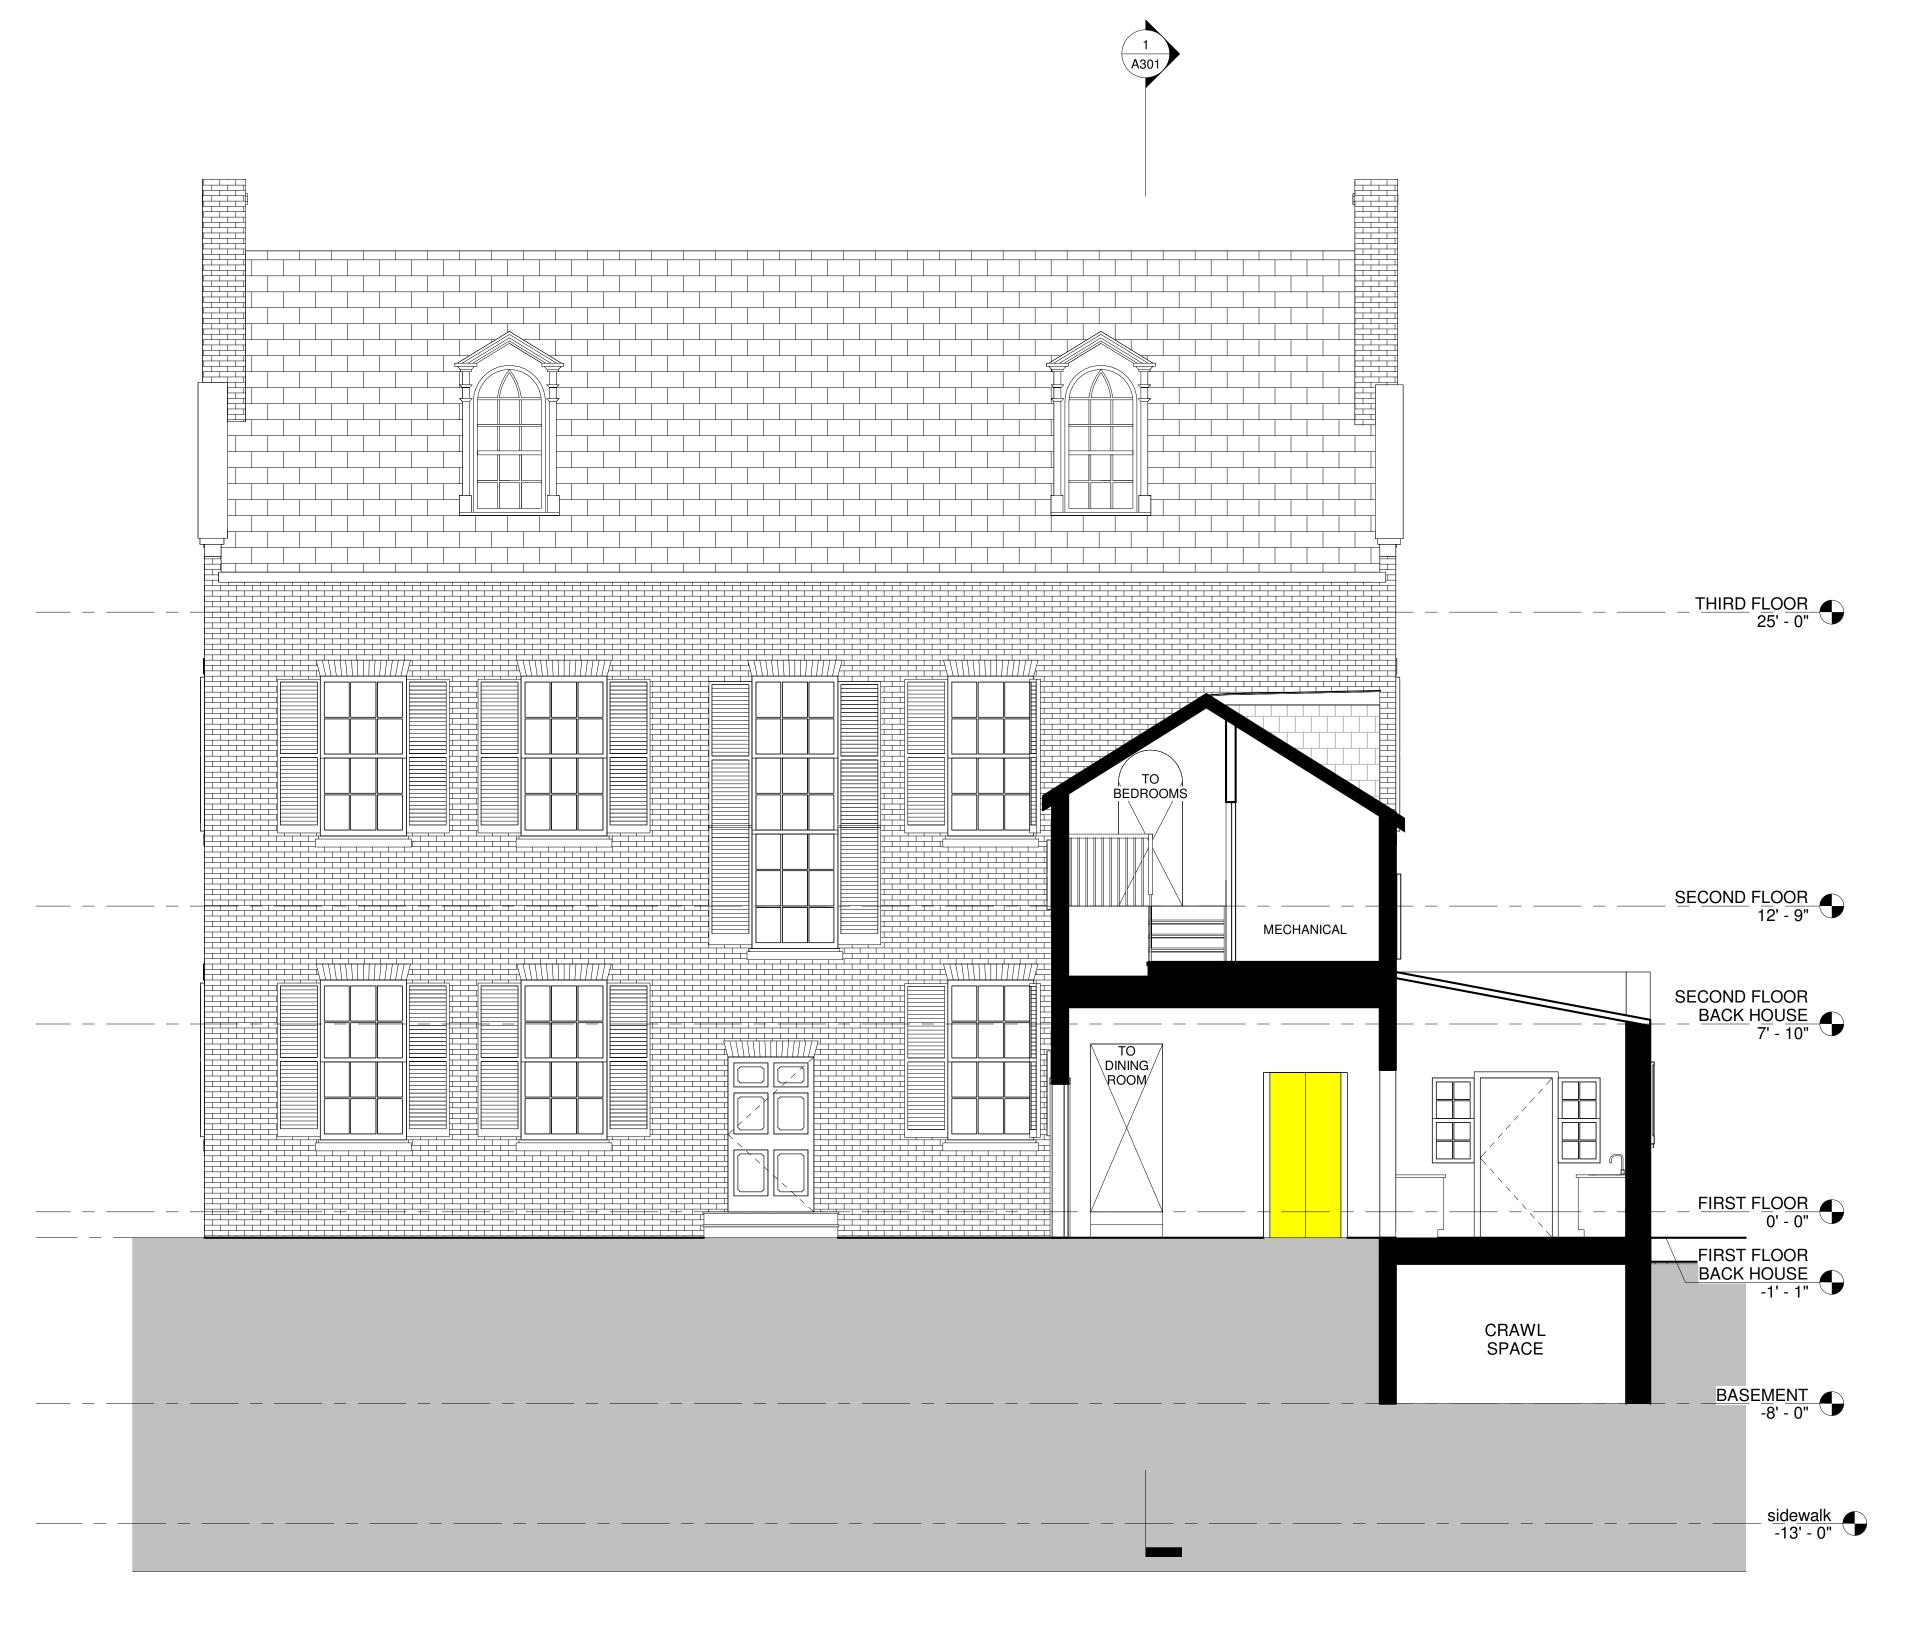

1 ELEVATOR SECTION 3 1/4" = 1'-0"





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- DRAWING TITLE -


BUILDING SECTION


- DATE
March 11, 2021

- SCALE
1/4" = 1'-0"

- DRAWING TITLE -


A302

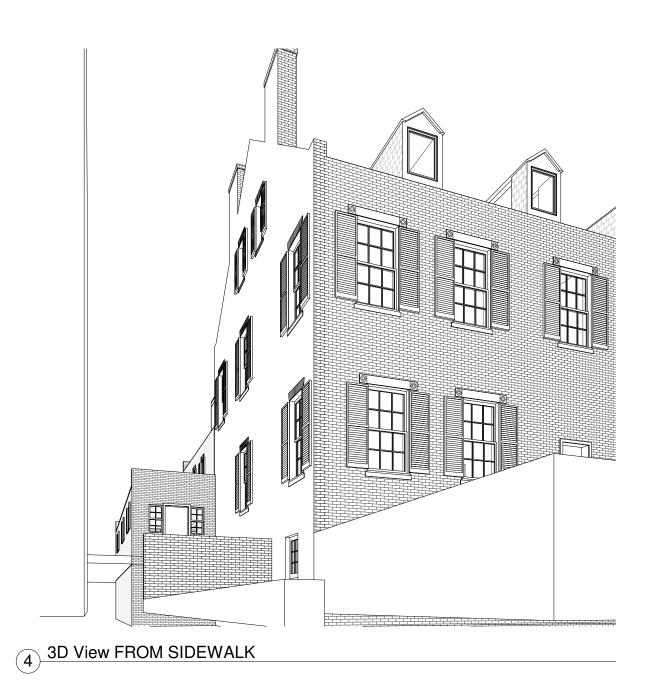

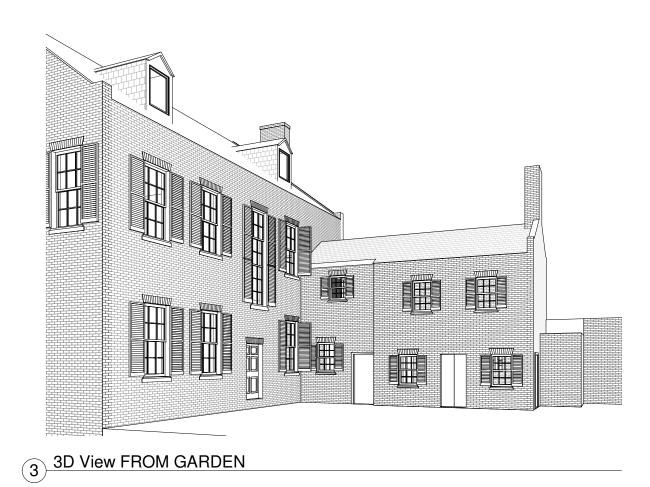




1) 3D BACK OF HOUSE

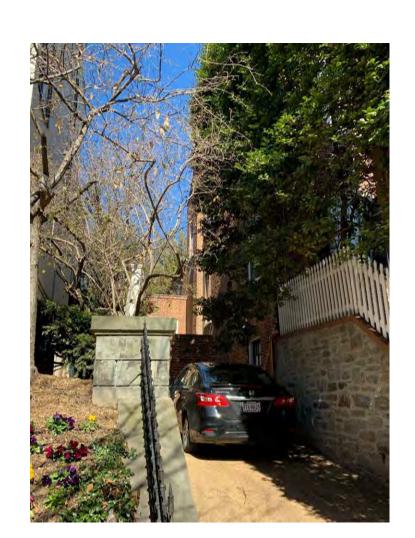

(4) VIEW STANDING AT CORNER OF DRIVEWAY



(5) VIEW FROM MIDDLE OF STREET

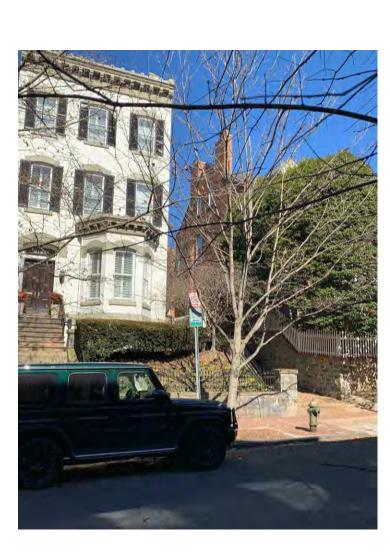

(6) VIEW FROM ACROSS STREET



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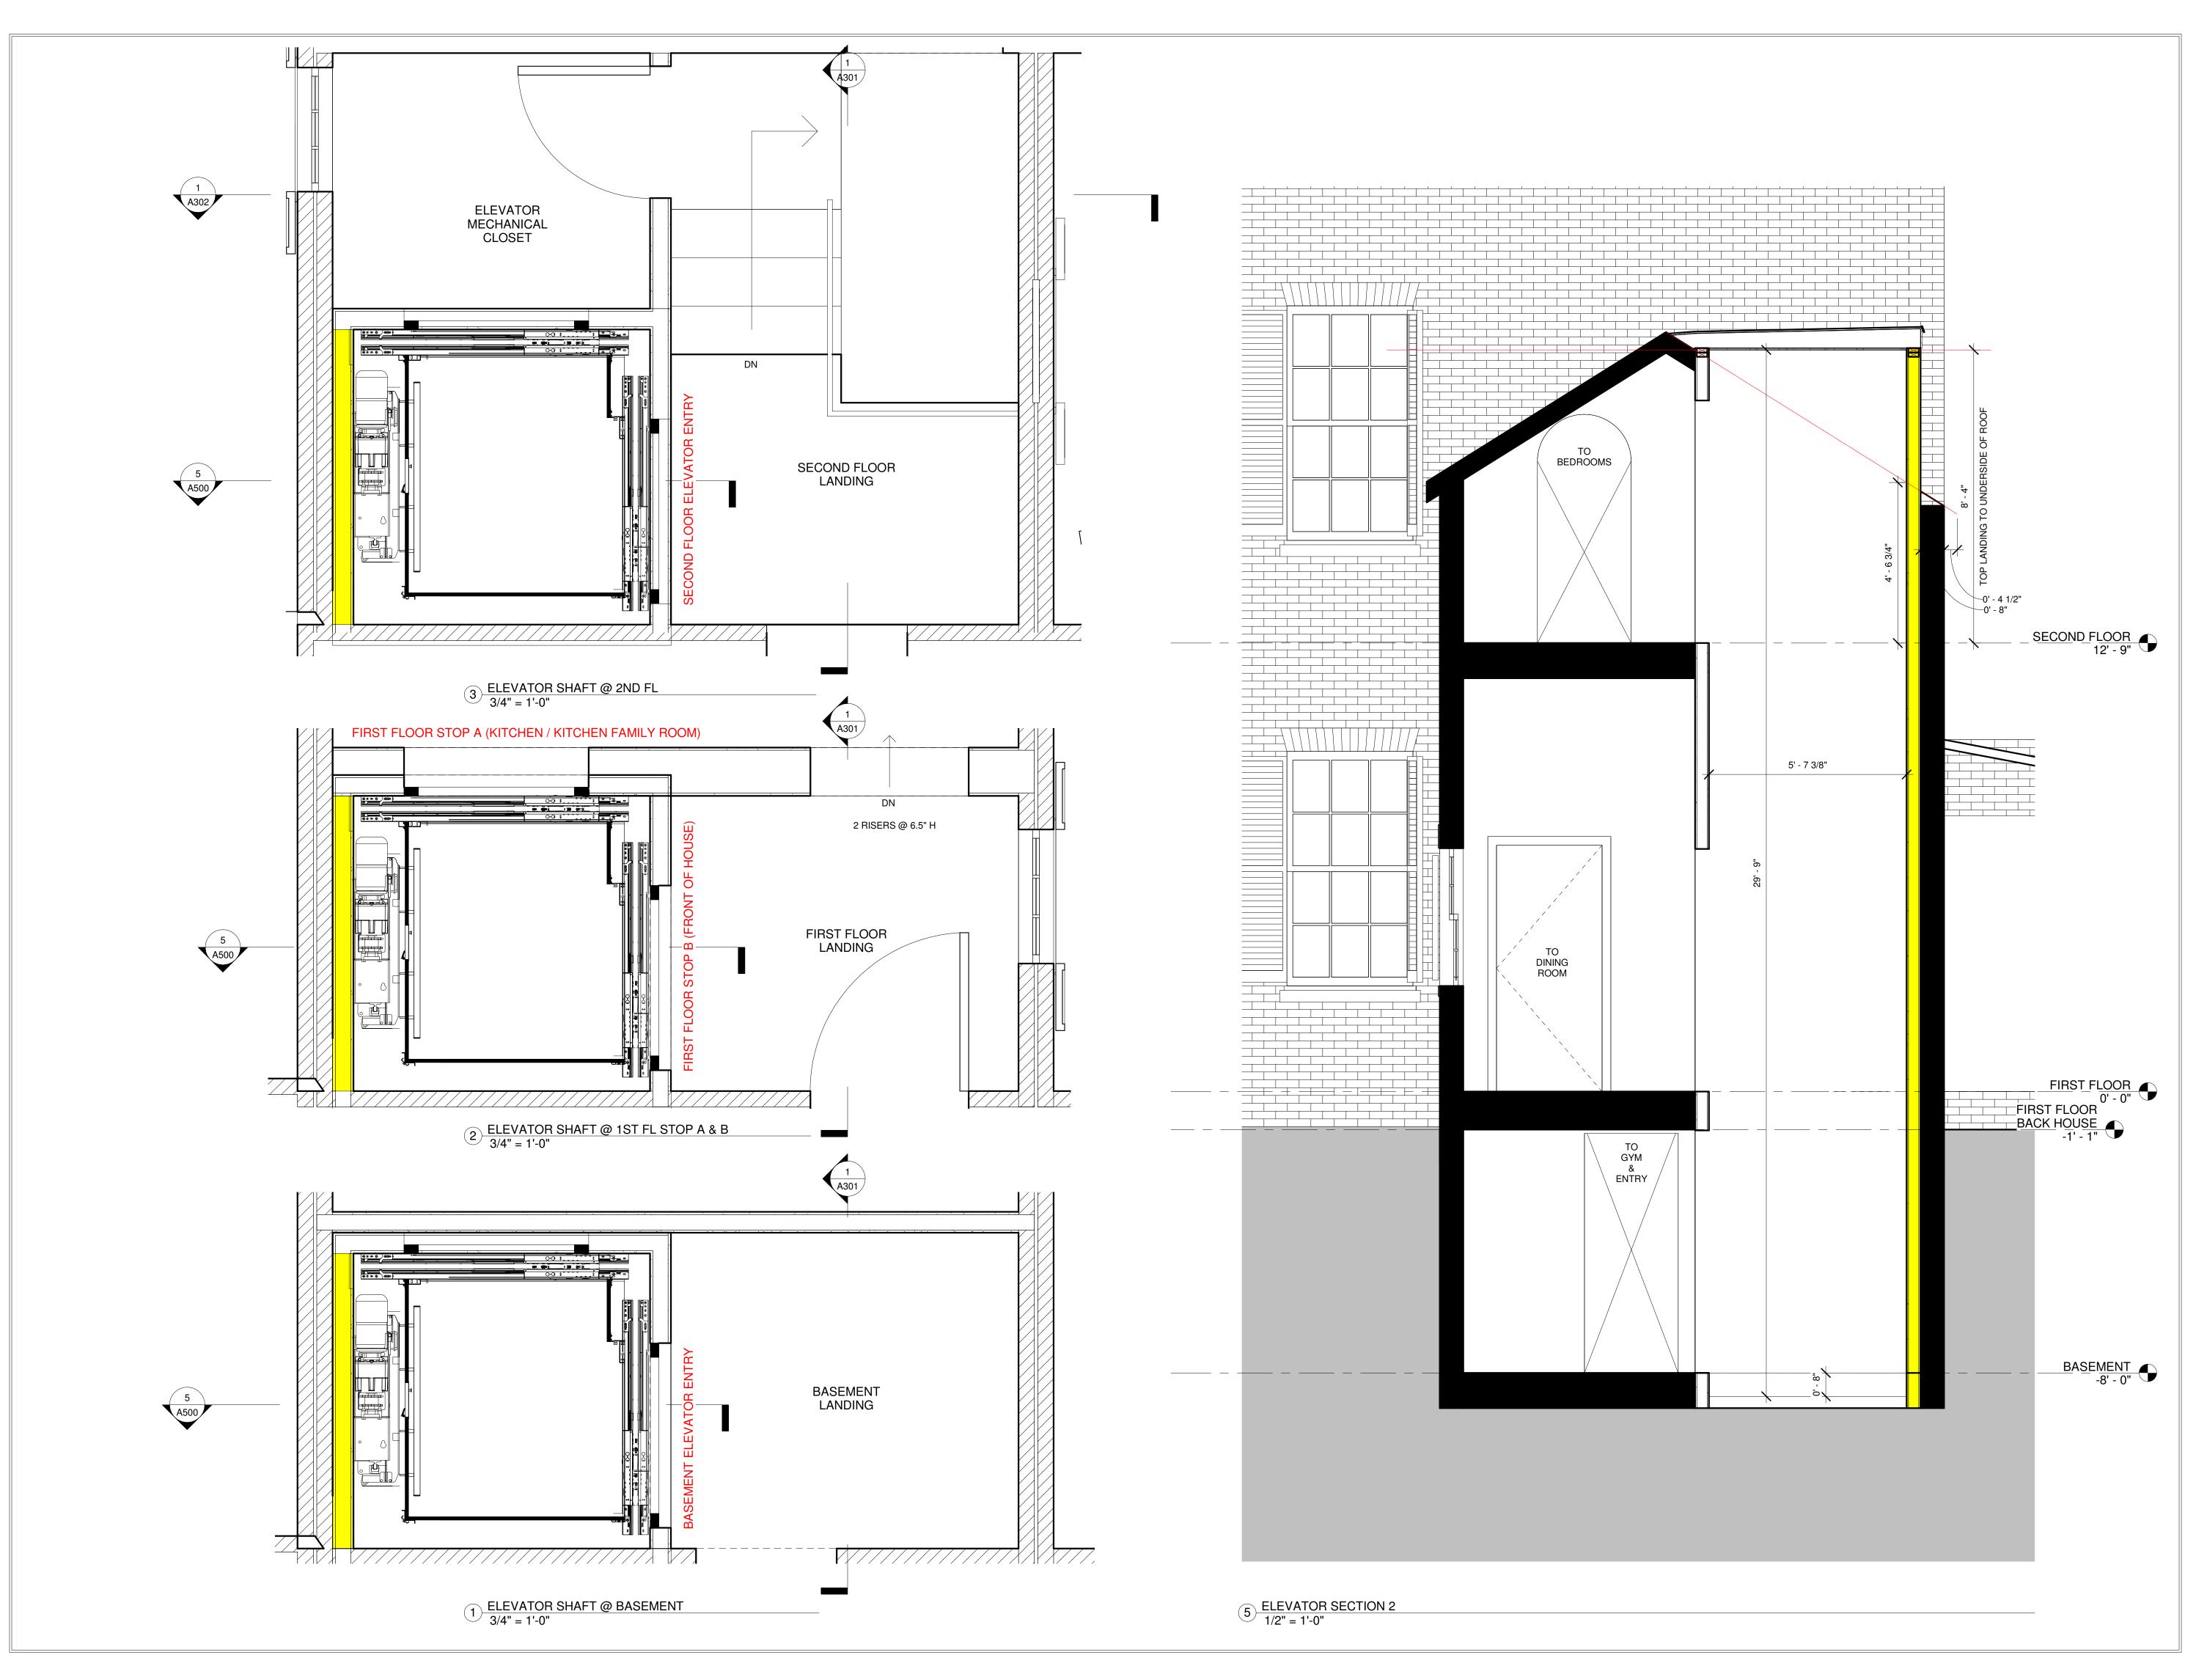
- DRAWING TITLE -

3D VIEWS

- DATE -March 11, 2021 - SCALE -

- DRAWING TITLE -

A400



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- DRAWING TITLE -


ELEVATOR DETAILS

- DATE March 11, 2021
- SCALE As indicated
- DRAWING TITLE -

A500



1: VIEW FROM PATIO EDGE

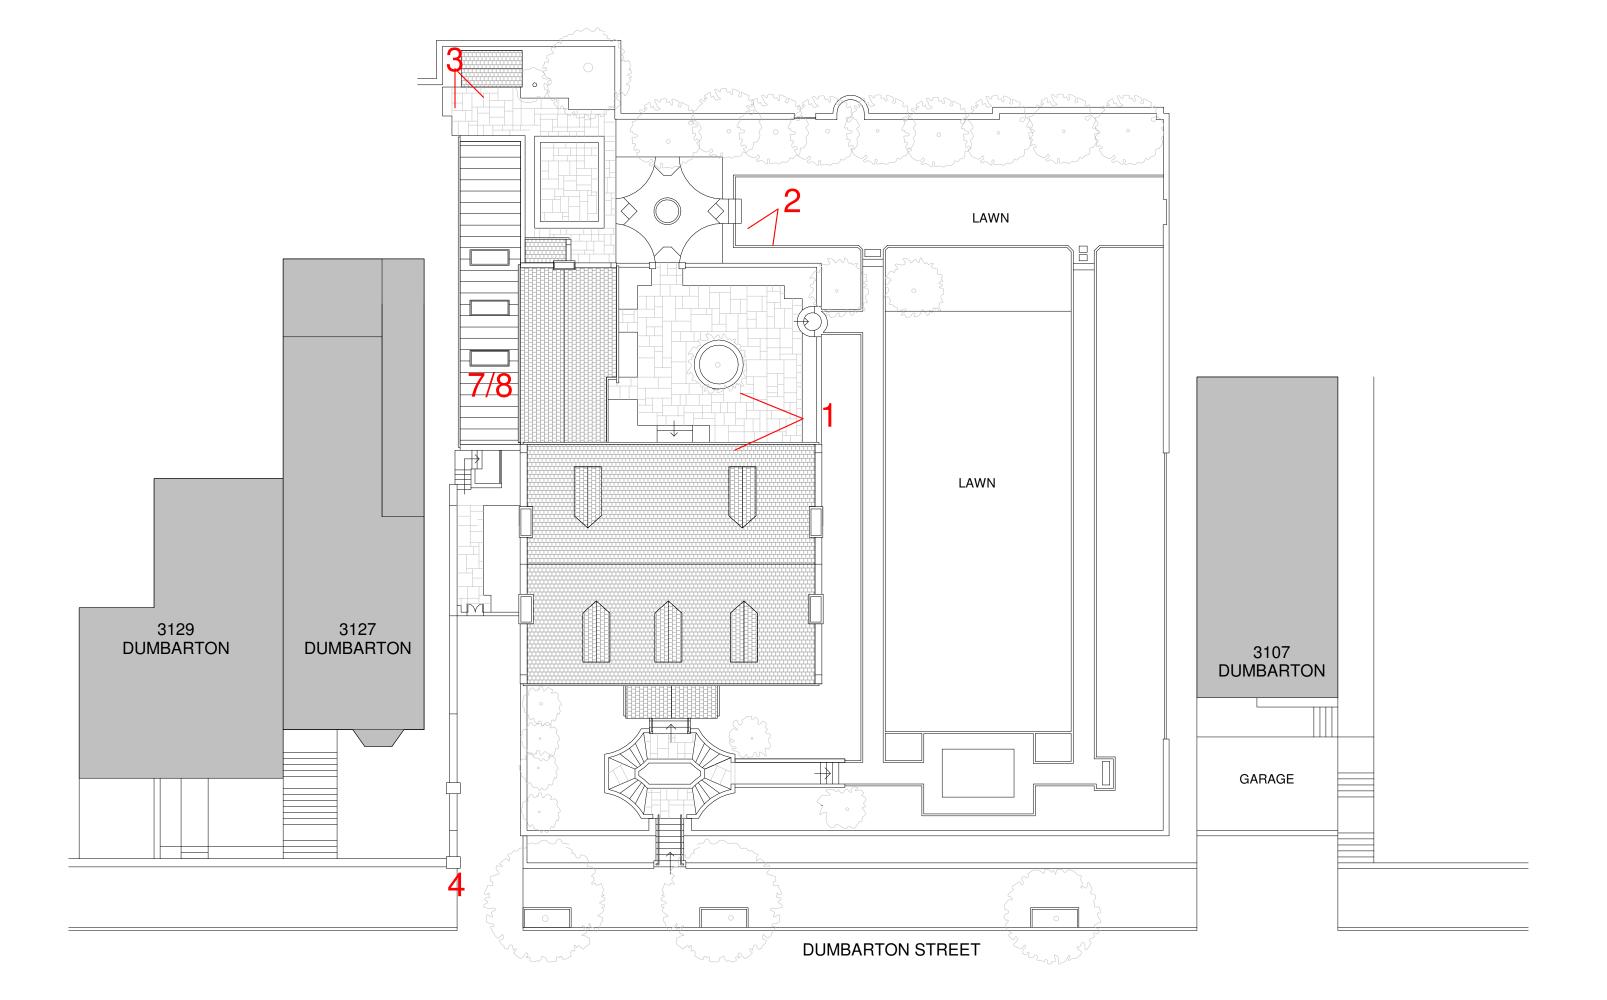

5: VIEW FROM MIDDLE OF STREET (SHEET A400)



2: VIEW FROM LAWN



3: VIEW FROM CORNER OF PROPERTY

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- DRAWING TITLE -

SITE PHOTOS

- DATE
March 11, 2021

- SCALE
1/16" = 1'-0"


- DRAWING TITLE -


A502

CONCEPT REVIEW

6: ACROSS STREET (SHEET A400)

RED LINE INDICATES OUTLINE OF ELEVATOR BOX

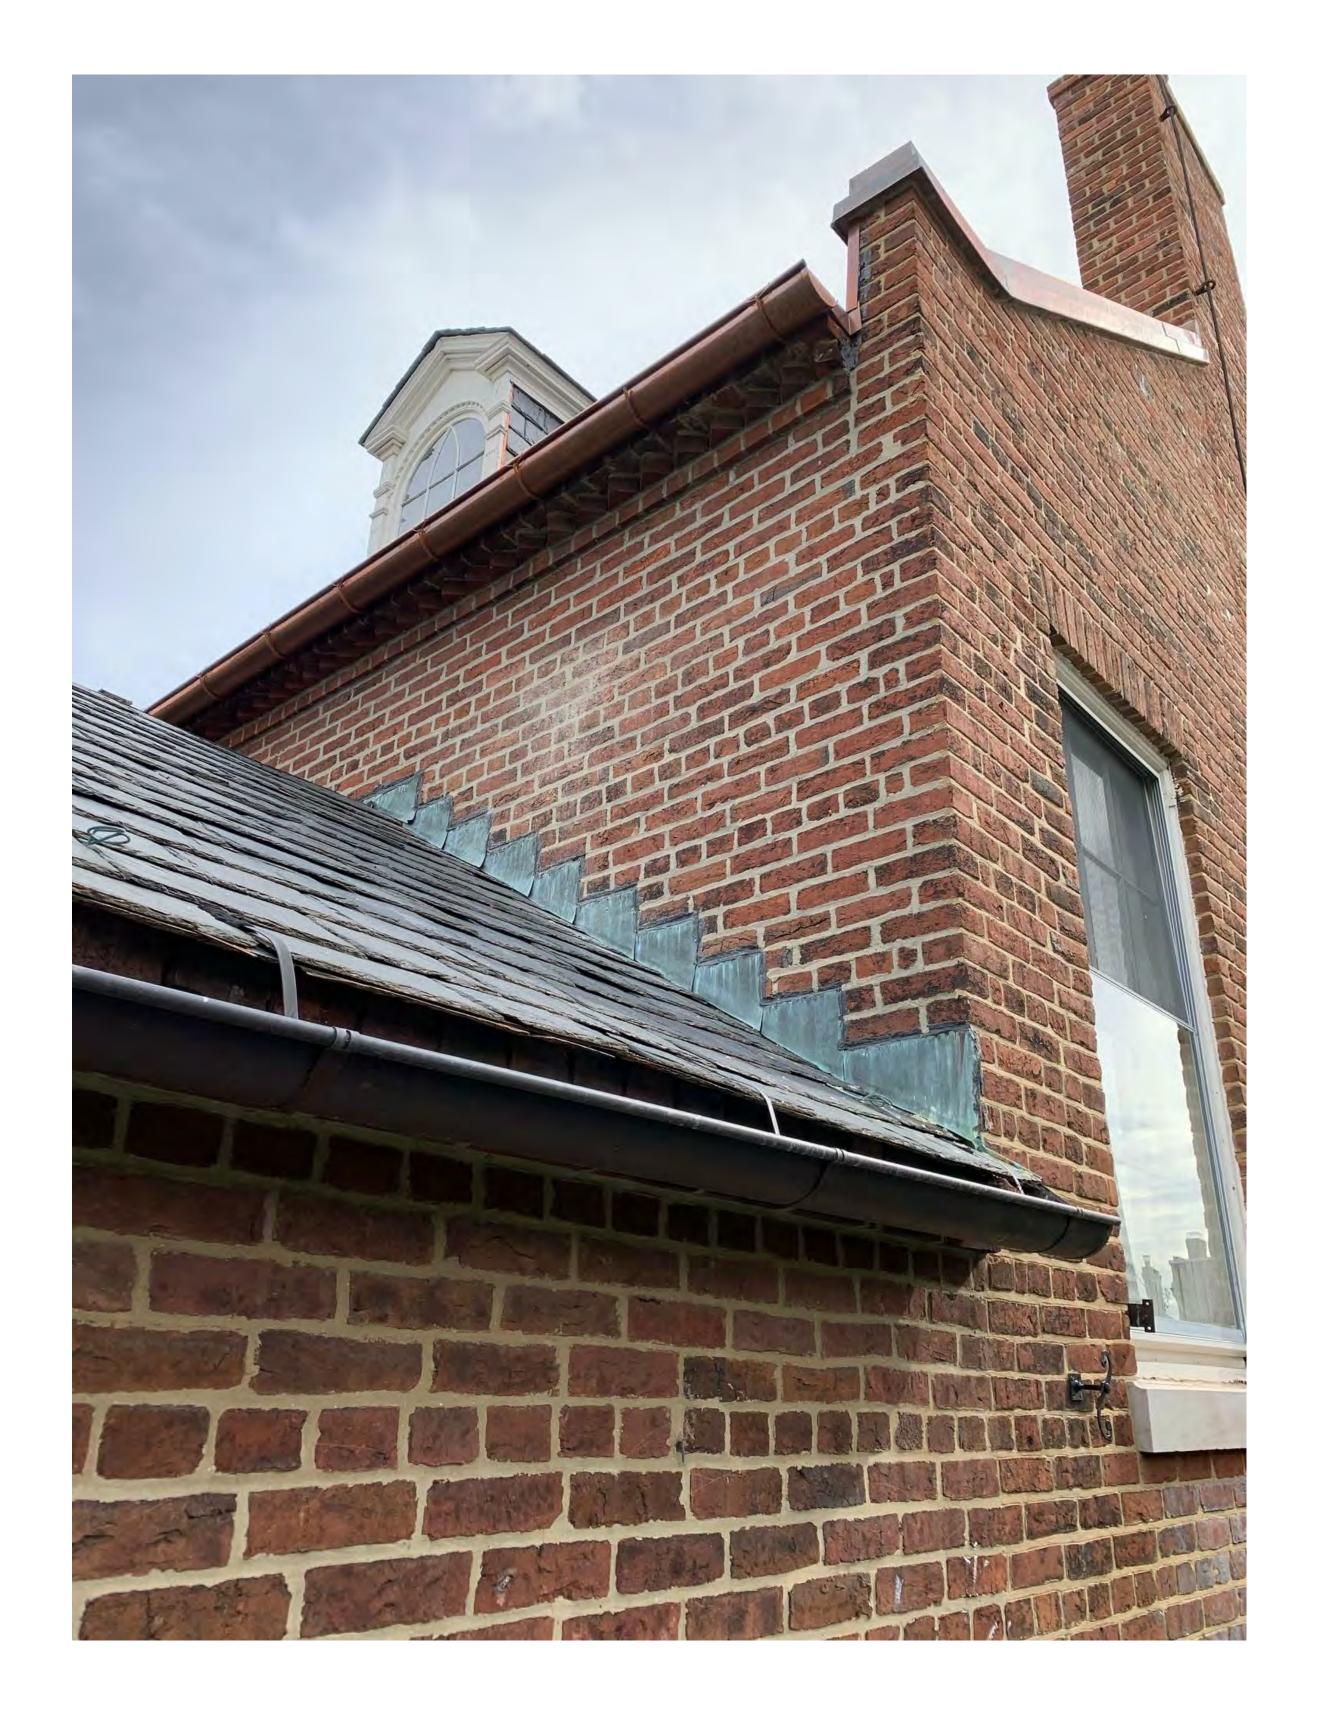

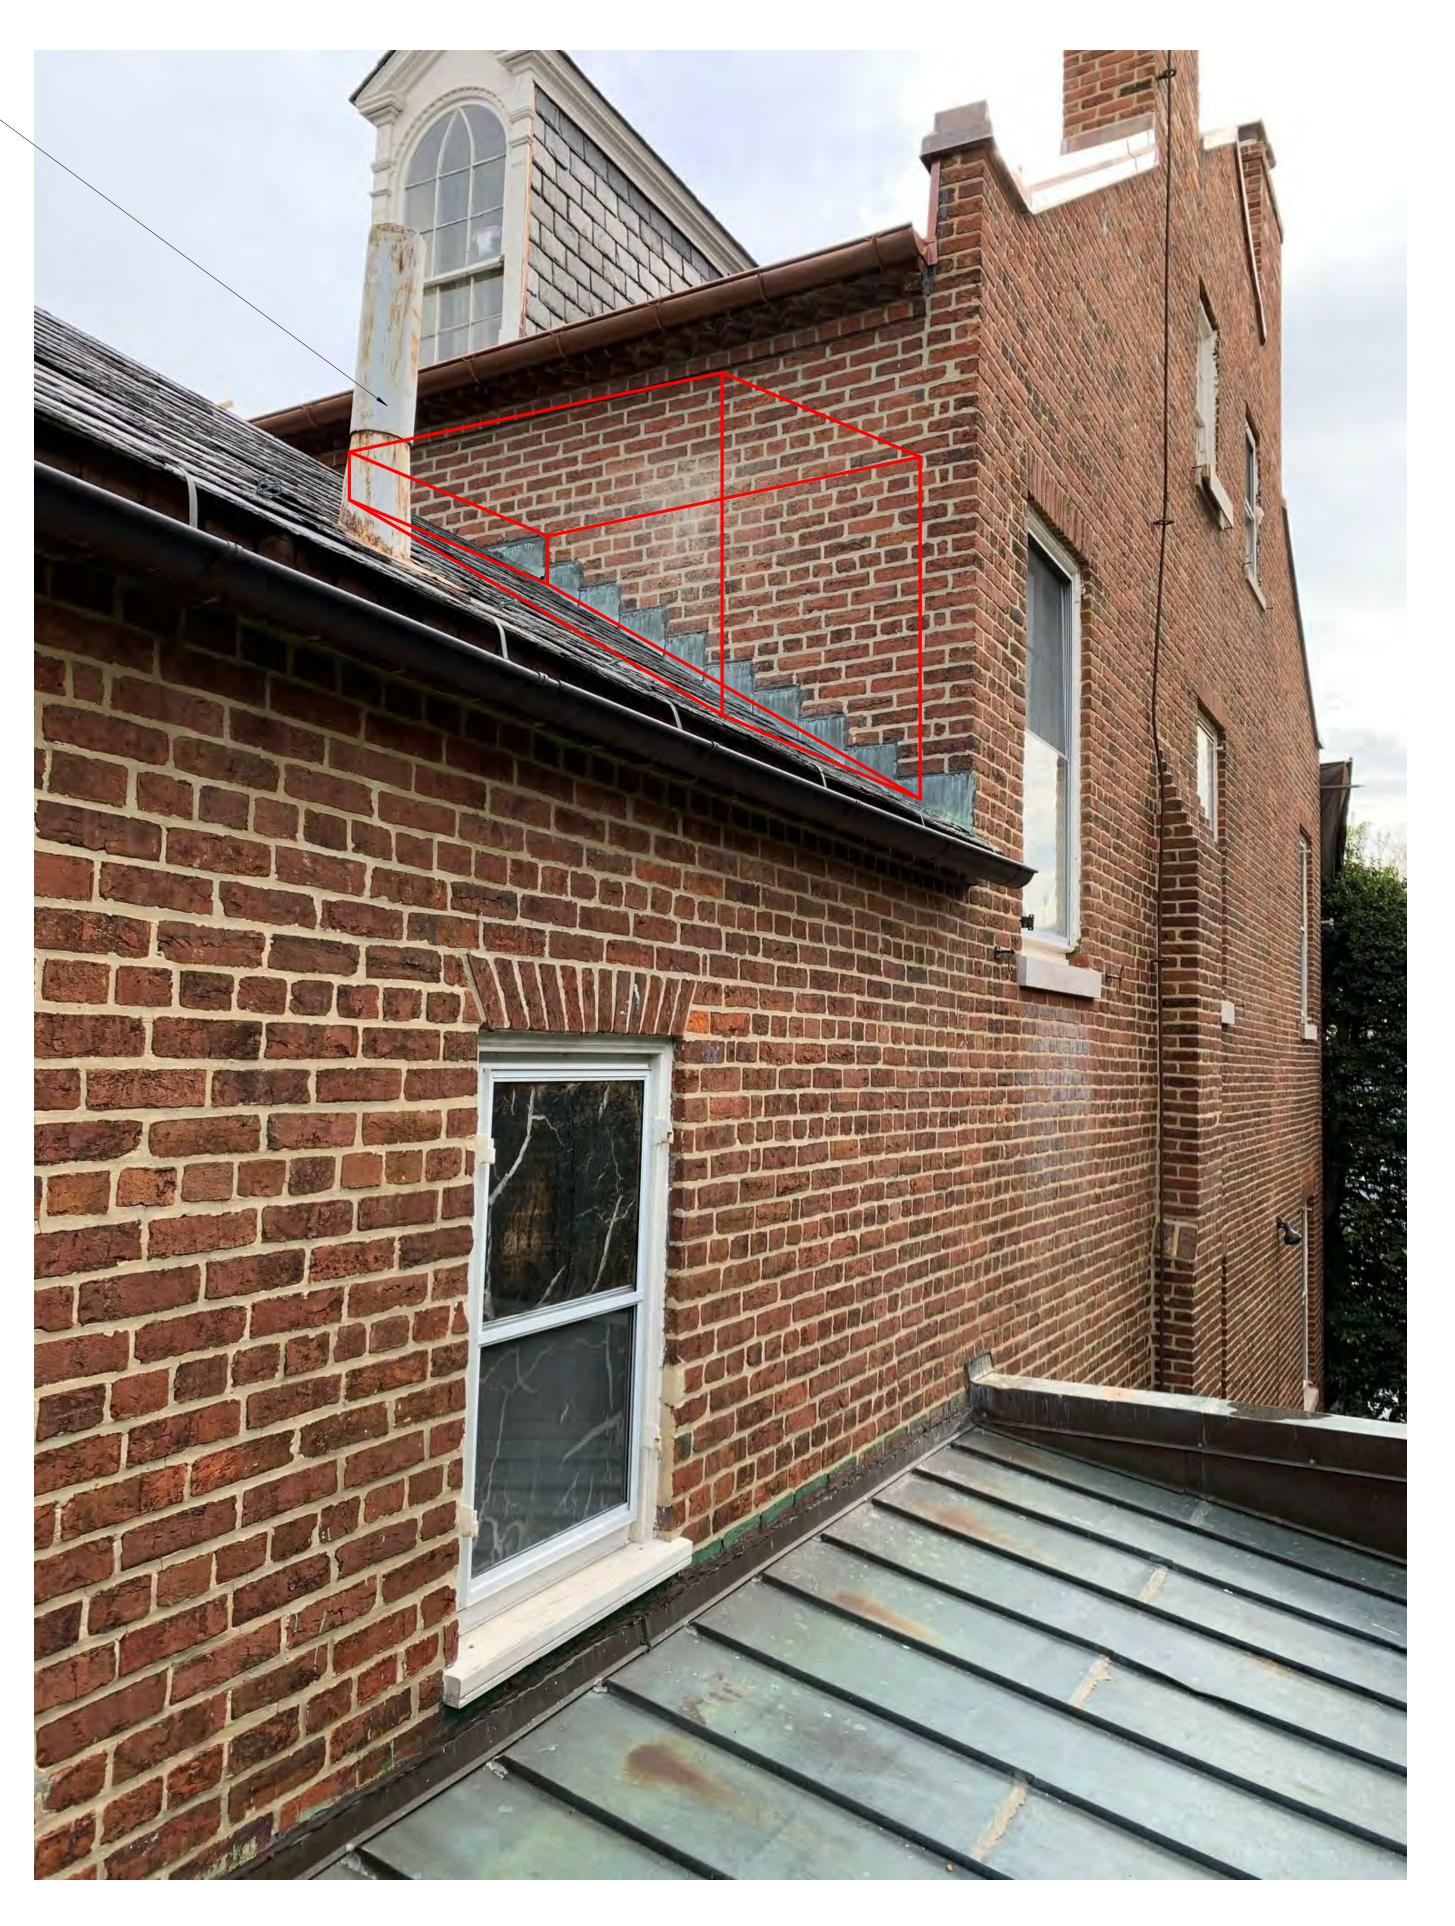

7 (SEE PHOTO LEGEND ON SHEET A502)

8 (SEE PHOTO LEGEND ON SHEET A502)

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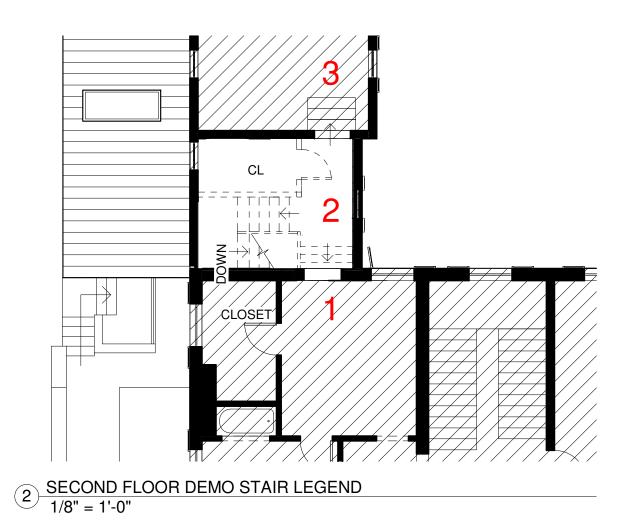
- DRAWING TITLE -


SITE PHOTOS

- DATE -

- DRAWING TITLE -


A503



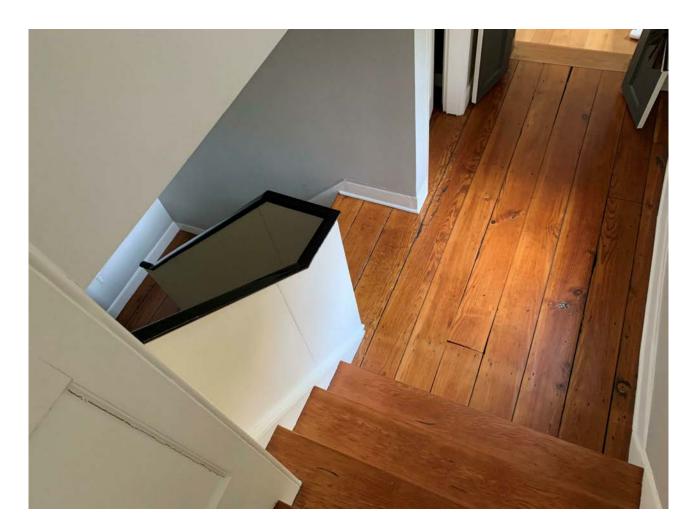


(1) SECOND FLOOR FRONT HOUSE LOOKING DOWN TO BACK STAIRWELL AND OFFICE STAIRS


DINING ROOM

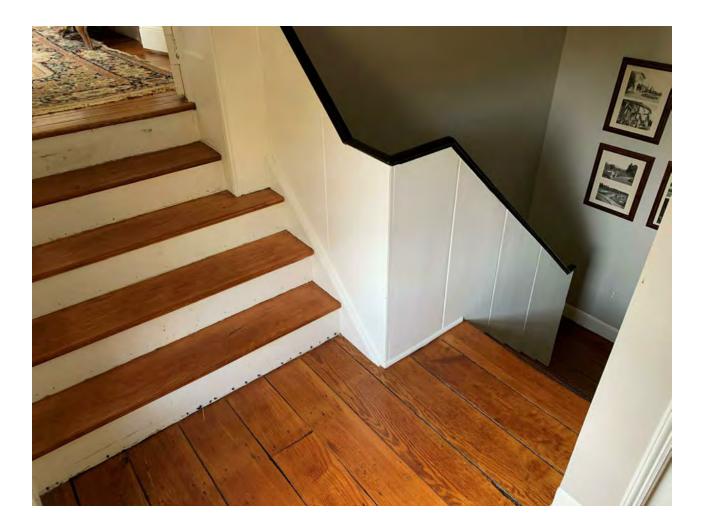

(2) LOOKING UP TO SECONF FLOOR FRONT HOUSE AND DOWN TOWARDS BACK STAIRWELL

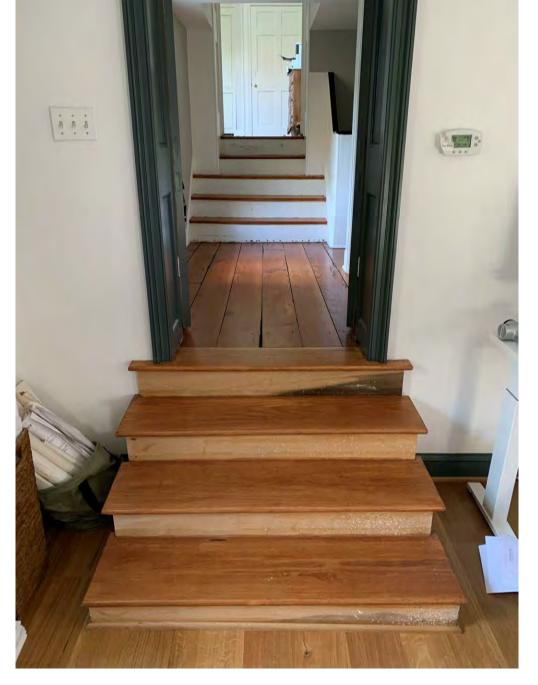

(3) LOOKING UP FROM OFFICE (SECOND FLOOR BACK OF HOUSE) TO SECOND FLOOR FRONT HOUSE

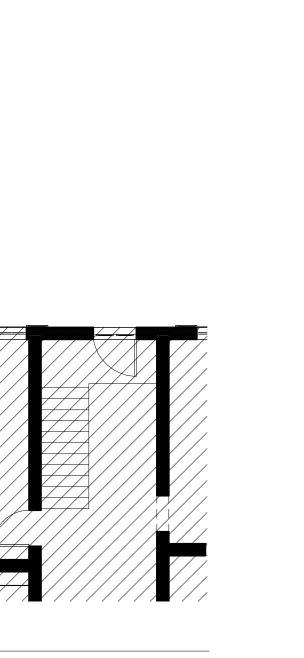

1 FIRST FLOOR DEMO STAIR LEGEND 1/8" = 1'-0"


KITCHEN



(4) LOOKING FROM 1ST FLOOR DINING ROOM UP BACK STAIRS




(5) LOOKING FROM 1ST BACK HOUSE TO DINING ROOM & STAIRS

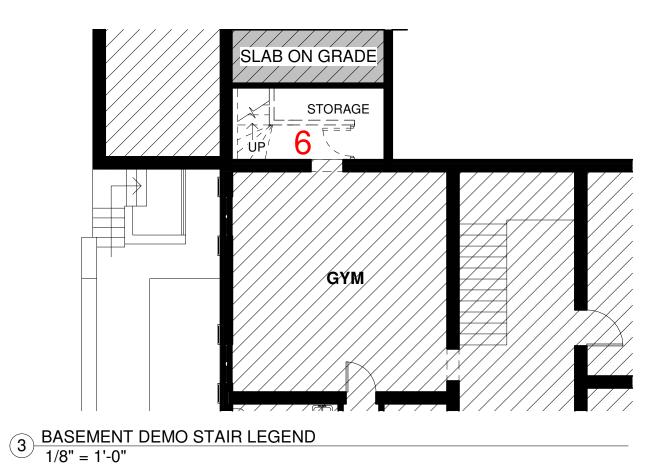



(6) LOOKING FROM BASEMENT UP BASEMENT STAIRS

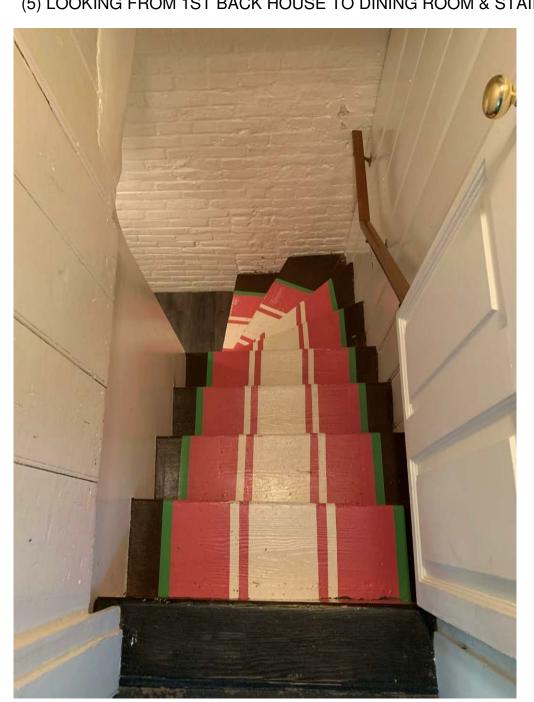

(7) LOOKING FROM 1ST BACK HOUSE DOWN BASEMENT STAIRS



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- DRAWING TITLE -

SITE PHOTOS

- DATE -March 11, 2021 - SCALE -1/8" = 1'-0" - DRAWING TITLE -

GENERAL

- 1. CONTRACTOR SHALL PROVIDE TEMPORARY SHORING, BRACING, SHEETING AND MAKE SAFE ALL FLOORS, ROOFS, WALLS AND ADJACENT PROPERTY, AS PROJECT CONDITIONS REQUIRE. A PROFESSIONAL ENGINEER, LICENSED BY THE DISTRICT OF COUNBIA AND HIRED BY THE CONTRACTOR, SHALL DESIGN ALL SHORING AND SHEETING AND SHALL SUBMIT SHOP DRAWINGS
- AND CALCULATIONS FOR THE OWNER'S REVIEW.

 2. ALL STRUCTURAL WORK SHALL BE COORDINATED WITH ARCHITECTURAL AND MECHANICAL DRAWINGS AND SHALL CONFORM TO THE PROJECT SPECIFICATIONS, INCLUDING THE INTERNATIONAL RESIDENTIAL CODE 2015 AS MODIFIED BY THE DISTRICT OF COLUMBIA DCMR—12B RESIDENTIAL CODE.
- 3. DIMENSIONS AND ELEVATIONS OF EXISTING CONSTRUCTION GIVEN IN STRUCTURAL DRAWINGS ARE BASED ON INFORMATION CONTAINED IN VARIOUS ORIGINAL DESIGN AND CONSTRUCTION DOCUMENTS PROVIDED BY THE OWNER, AND LIMITED FIELD OBSERVATIONS AND MEASUREMENTS. THE CONTRACTOR SHALL VERIFY ALL INFORMATION PERTAINING TO EXISTING CONDITIONS BY ACTUAL MEASUREMENT AND OBSERVATION AT THE SITE. ALL DISCREPANCIES BETWEEN ACTUAL CONDITIONS AND THOSE SHOWN IN THE CONTRACT DOCUMENTS SHALL BE REPORTED TO THE ARCHITECT FOR EVALUATION BEFORE THE AFFECTED CONSTRUCTION IS PUT IN PLACE.
- 5. THE INFORMATION CONTAINED IN THIS SET OF DRAWINGS REPRESENTS THE DESIGN INTENT OF THE PROPOSED CONSTRUCTION. ELECTRONIC VERSIONS (PDF, DWG) OF THESE DRAWINGS SHOULD NOT BE USED TO DETERMINE DIMENSIONS OR GATHER ANY INFORMATION THAT IS NOT SPECIFICALLY LABELED OR OTHERWISE DENOTED IN PLAN, SECTION, OR DETAIL. DUPLICATION OF THESE DRAWINGS FOR USE IN THE PREPARATION OF SHOP DRAWINGS IS NOT ACCEPTABLE. THIS INCLUDES ANNOTATED HARD—COPIES AND DIRECT REUSE OF ELECTRONIC FILES.

FOUNDATIONS

- 1. BUILDING FOUNDATIONS SHALL BEAR ON UNDISTURBED SOIL HAVING MINIMUM BEARING CAPACITY OF 1500 PSF. AS SPECIFIED BY THE 2015 IBC PRESUMPTIVE SOIL DESIGN VALUES. ADEQUACY OF BEARING STRATUM SHALL BE VERIFIED
- IN FIELD PRIOR TO PLACING CONCRETE. ADJUST BOTTOM OF FOOTING ELEVATIONS AS REQUIRED.

 2. FINISH ALL FOOTING EXCAVATIONS BY HAND. NO FOOTINGS SHALL BE PLACED IN WATER OR ON FROZEN GROUND. PROTECT FOOTINGS FROM FROST AFTER THEY ARE PLACED.
- 3. FILL AND BACKFILL MATERIAL— CLEAN RUN OF BANK MATERIAL, FREE OF DELETERIOUS ORGANIC MATERIALS.

CAST-IN-PLACE CONCRETE

- 1. ALL CONCRETE SHALL ATTAIN A MINIMUM COMPRESSIVE STRENGTH OF 3500 PSI AT 28 DAYS. SLUMP SHALL BE 4" FOR SLABS ON GRADE AND 5" FOR ALL OTHER CONCRETE.
- 2. SLABS ON GRADE SHALL BE 4" CONCRETE REINFORCED WITH WWF6x6-W1.4xW1.4 ON 10 MIL. POLY. VAPOR BARRIER ON 4" CRUSHED STONE, U.N.O.
- 3. ALL FOUNDATION CONCRETE SHALL INCLUDE 5% AIR ENTRAINMENT (±1.5%). ADJUST AIR ENTRAINMENT FOR EXPOSURE CLASS AS REQUIRED.
 4. REINFORCING STEEL SHALL BE DEFORMED BARS CONFORMING TO ASTM A615, GRADE 60. REINFORCING STEEL SHALL
- 4. REINFORCING STEEL SHALL BE DEFORMED BARS CONFORMING TO ASTM A615, GRADE 60. REINFORCING STEEL SHALL BE DETAILED ACCORDING TO THE ACI MANUAL OF CONCRETE PRACTICE (ACI 315), LOCALLY APPROVED EDITION.

 5. WELDED WIRE FABRIC (WWF) SHALL CONFORM TO ASTM A185, WITH A MINIMUM ULTIMATE TENSILE STRENGTH OF
- 70,000 PSI.

 6. CONCRETE WORK SHALL BE DESIGNED, REINFORCED, PLACED AND CURED IN CONFORMANCE WITH THE LOCALLY APPROVED EDITION OF ACI 301, "SPECIFICATIONS FOR STRUCTURAL CONCRETE", AND ALL RECOMMENDED PRACTICES
- CONTAINED THEREIN SHALL BE CONSIDERED MANDATORY FOR THIS PROJECT.

 7. PROVIDE MINIMUM TEMPERATURE REINFORCEMENT, AS REQUIRED BY ACI-318, IN ALL SLABS AND WALLS WHERE
- REINFORCEMENT IS NOT INDICATED ON DRAWINGS.

 8. COORDINATE SIZE AND LOCATION OF ALL OPENINGS AND PIPE SLEEVES WITH ARCHITECTURAL AND MECHANICAL DRAWINGS MINIMUM CONCRETE RETWEEN SLEEVES SHALL BE 6".
- DRAWINGS. MINIMUM CONCRETE BETWEEN SLEEVES SHALL BE 6".

 9. PROVIDE CLEARANCE FROM FACE OF CONCRETE TO REINFORCEMENT AS FOLLOWS:

SLABS: FOOTINGS:

- FOOTINGS: 3"
 BUILDINGS AND BRIDGES," LOCALLY APPROVED EDITIONS.

 11. ALL GROUT SHALL BE NON-SHRINK WITH A MINIMUM COMPRESSIVE STRENGTH OF 5000 PSI.

 12. UNLESS SPECIFICALLY WAIVED BY ENGINEER OF RECORD, CEMENTITIOUS MATERIAL REPLACEMENT FOR CONCRETE MIXES

 2. ALL STRUCTURAL STEEL SHALL CONFORM TO THE FOLLOWING ASTM SPECIFICATIONS:
- GROUND GRANULATED BLAST FURNACE SLAG (GGBFS) OR FLY ASH.

 13. WHERE CONCRETE IS PLACED AGAINST AND DOWELED TO HARDENED CONCRETE AND/OR WHERE A ROUGHENED SURFACE IS INDICATED IN THE STRUCTURAL DRAWINGS, THE HARDENED CONCRETE SURFACE SHALL BE CLEAN AND FREE OF LAITANCE AND SHALL BE ROUGHENED TO A FULL AMPLITUDE OF APPROXIMATELY 1/4".

AT ALL CAST-IN-PLACE CONCRETE SHALL BE 10% MINIMUM AND 33% MAXIMUM USING ONE OF THE FOLLOWING:

WOOD HEADER SCHEDULE

1. UNLESS NOTED OTHERWISE IN PLAN, PROVIDE HEADERS PER THE FOLLOWING:

ROUGH OPENING WIDTH:	HEADER:					
LESS THAN 3'-0" 3'-1 TO 4'-0" 4'-1" TO 6'-0" 6'-1" TO 8'-0" OVER 8'-0"	2x4 WALL (2) 2x6 (2) 2x8 (2) 2x10 (2) 2x12 SEE PLANS	2x6 WALL (3) 2x8 (3) 2x8 (3) 2x10 (3) 2x12 SEE PLANS				
NOTE:						

PROVIDE (2) JACK STUDS FOR SPANS LESS THAN 8'-0" WIDE, PROVIDE (3) JACK STUDS FOR SPANS OVER 8'-0" WIDE.

PROVIDE (3) JACK STUDS FOR SPANS OVER 8 -0 WIDE.

PROVIDE (1) JACK STUD FOR SPANS LESS THAN 4'-0" WIDE.

ENGINEERED WOOD PRODUCTS

- 1. MICROLLAM BEAMS: PROVIDE ENGINEERED BEAMS, SIZES AS SHOWN, MICROLLAM LVL (Fb=2600 PSI, E=2,000,000 PSI) OR PARALLAM PSL (Fb=2900 PSI, E=2,000,000 PSI) AS MANUFACTURED BY WEYERHAUSER OR APPROVED EQUAL. INSTALL IN STRICT COMPLIANCE WITH THE MANUFACTURER'S STANDARD RECOMMENDATIONS AND DETAILS.
- 2. GLUED LAMINATED TIMBER (SOFTWOOD): PROVIDE ENGINEERED BEAMS, SIZES AS SHOWN, IN ACCORDANCE WITH AITC 117-04 DESIGN STANDARD SPECIFICATIONS FOR STRUCTURAL GLUED LAMINATED TIMBER OF SOFTWOOD SPECIES. UNLESS NOTED OTHERWISE, ALL LAMINATIONS SHALL BE
- SOUTHERN PINE.

 A. ANTHONY POWER COLUMNS: COMBINATION 50 SOUTHERN PINE N1D14
- B. ANTHONY POWER PRESERVED COLUMNS: COMBINATION 50 SOUTHERN PINE N1D14 C. ANTHONY POWER BEAMS: 3000 Fb 2.1E 300 Fv
- D. ANTHONY POWER PRESERVED BEAMS: 24F-V5M1/SP (2400 Fb 1.8E 300 Fv)
- USE DOUBLE TRIMMERS AND HEADERS AT ALL FLOOR OPENINGS WHERE BEAMS ARE NOT DESIGNATED.
 BRIDGING FOR SPANS UP TO 14 FT., PROVIDE 1 ROW. BRIDGING FOR SPANS OVER 14 FT., PROVIDE 2 ROWS.

FRAMING LUMBER

- FRAMING LUMBER SHALL HAVE EACH PIECE GRADE STAMPED, SHALL BE SURFACED DRY (EXCEPT STUDS, WHICH SHALL BE KILN-DRIED) AND SHALL CONFORM TO THE FOLLOWING SPECIES AND GRADE: RAFTERS AND JOISTS: HEM-FIR #2 OR SPRUCE-PINE-FIR #2
- BEAMS, GIRDERS AND HEADERS: HEM-FIR #1 OR SPRUCE-PINE-FIR #1
 STUDS AND PLATES: HEM-FIR STUD GRADE OR SPRUCE-PINE-FIR STUD GRADE

 2. ALL WOOD FRAMING INCLUDING DETAILS FOR BRIDGING, BLOCKING, FIRE STOPPING, ETC., SHALL CONFORM TO THE LOCALLY APPROVED EDITION OF THE "NATIONAL DESIGN SPECIFICATION FOR WOOD
- CONSTRUCTION" AND ITS SUPPLEMENTS AND SHALL BE INSTALLED IN ACCORDANCE WITH THE INTERNATIONAL RESIDENTIAL CODE (SEE DESIGN LOADS AND FACTORS TABLE FOR IRC EDITION).

 3. FASTENING SHALL BE IN ACCORDANCE WITH THE MOST RESTRICTIVE OF: THE INTERNATIONAL RESIDENTIAL CODE, OR THE MANUFACTURER'S RECOMMENDED FASTENING SCHEDULES. (SEE DESIGN LOADS AND FACTORS TABLE FOR IRC EDITION)
- 4. ALL FLUSH FRAMED CONNECTIONS SHALL BE MADE WITH APPROVED GALVANIZED STEEL JOIST OR BEAM HANGERS, MINIMUM 18 GAUGE, INSTALLED ACCORDING TO MANUFACTURER'S RECOMMENDATIONS.

 5. WHERE FRAMING LUMBER IS FLUSH FRAMED TO MICROLLAM. STEEL OR FLITCH—PLATE GIRDER. SET THESE
- GIRDERS ¼" CLEAR (MIN.) BELOW TOP OF FRAMING LUMBER, TO ALLOW FOR SHRINKAGE.

 6. STUD BEARING WALLS ARE TO BE 2x4, @ 16" O.C., UNLESS NOTED OTHERWISE ON PLAN.
- 7. LAP ALL PLATES AT CORNERS AND AT INTERSECTION OF PARTITIONS.

 8. STAGGER ALL TOP AND BOTTOM PLATE SPLICES A MINIMUM OF 32 INCHES.
- 9. USE DOUBLE STUDS @ ENDS OF WALL AND ENDS OF WALL OPENINGS.

 10. AT THE ENDS OF ALL BEAMS, HEADERS AND GIRDERS PROVIDE A BUILT UP OR SOLID POST WHOSE WIDTH IS AT LEAST EQUAL TO THE WIDTH OF THE MEMBER IT IS SUPPORTING AND WHOSE DEPTH IS 4" (NOM.) AT INTERIOR WALLS AND 6" (NOM.) AT EXTERIOR WALLS.
- 11. USE DOUBLE TRIMMERS AND HEADERS AT ALL FLOOR OPENINGS WHERE BEAMS ARE NOT DESIGNATED.

 12. BRIDGING FOR SPANS UP TO 14 FT., PROVIDE 1 ROW. BRIDGING FOR SPANS OVER 14 FT., PROVIDE 2
- ROWS.

 13. BUILT-UP BEAMS LESS THAN 8" DEEP SHALL BE SPIKED TOGETHER WITH (2) 16D NAILS @ 16" O.C.
- BUILT-UP BEAMS CREATER THAN 8" DEEP SHALL BE SPIKED TOGETHER WITH (2) 16D NAILS @ 16" O.C.

 14. WHERE THERE IS NO PLYWOOD WALL SHEATHING, PROVIDE DIAGONALS AT ALL EXTERIOR CORNERS OF
- STUD WALLS AT EACH FLOOR. (1"x4" BRACES LET INTO STUDS AND NAILED AT EACH STUD CROSSING WITH (2) 10D NAILS.)

 15 WHERE CANTUL EVERED BEAMS ARE INDICATED. THE FAR CONNECTOR SHALL BE CARRIE OF RESISTING AND ADDRESS OF RESISTING ADDRESS
- 15. WHERE CANTILEVERED BEAMS ARE INDICATED, THE FAR CONNECTOR SHALL BE CAPABLE OF RESISTING AN UPLIFT OF 1000 LBS. MIN., U.N.O.

 16. NO NEW OR EXISTING JOISTS SHALL BE CUT OR NOTCHED WITHOUT APPROVAL.

17. ALL LIGHT-GAGE HANGERS SUPPORTING PRESERVATIVE TREATED WOOD SHALL MEET OR EXCEED G185 (1.85 oz OF ZINC PER SQUARE FOOT). ALTERNATIVELY, STAINLESS STEEL CONNECTORS MAY BE USED.

FASTENERS SHALL MATCH THE SELECTED HANGER FINISH AND MATERIAL.

18. ALL SILL PLATES SHALL BE P.T. AND ANCHORED TO FOUNDATION WALLS W/½" DIA. HEADED ANCHOR BOLTS (ASTM F1554) @ 4'-0" O.C. THERE SHALL BE A MINIMUM OF (2) BOLTS PER PLATE SECTION WITH (1) BOLT LOCATED NOT MORE THAN 12" OR LESS THAN 7x BOLT DIA. FROM THE END OF EACH PLATE SECTION. ANCHOR BOLTS SHALL HAVE A MINIMUM 7" EMBEDMENT INTO CONCRETE OR GROUTED CMU CELLS. THE BOLTS SHALL BE LOCATED WITHIN THE MIDDLE THIRD OF THE PLATE WIDTH AND HAVE A TIGHTENED NUT AND WASHER.

STRUCTURAL STEEL

- ALL STRUCTURAL STEEL WORK SHALL CONFORM TO THE FOLLOWING GOVERNING STANDARDS:
 A. AISC "SPECIFICATION FOR STRUCTURAL STEEL BUILDINGS" AND "CODE OF STANDARD PRACTICE FOR STEEL BUILDINGS AND BRIDGES," LOCALLY APPROVED EDITIONS.
 B. AMERICAN WELDING SOCIETY (AWS) D1.1 "STRUCTURAL WELDING CODE——STEEL", LOCALLY APPROVED EDITION.
- 2. ALL STRUCTURAL STEEL SHALL CONFORM TO THE FOLLOWING ASTM SPECIFICATION A. WIDE FLANGE BEAMS, COLUMNS AND STRUCTURAL TEES: ASTM A992
- B. HOLLOW STRUCTURAL SECTIONS: ASTM A500, GRADE B
- C. STRUCTURAL PIPE SECTIONS: ASTM A53, GRADE B
 D. CHANNELS, ANGLES AND PLATES: ASTM A36 UNLESS OTHERWISE NOTED.
- E. BOLTED CONNECTIONS OF BEAMS/GRIDERS ARE TO BE DESIGNED AS FOLLOWS:

 i. STANDARD BEAM TO BEAM/GRIDER: A325 OR A490 BEARING TYPE BOLTS (3/4" DIAMETER MINIMUM).

 ii. BEAM/GIRDER TO COLUMN CONNECTIONS: A325 OR A490 TYPE BOLTS (3/4" DIAMETER MINIMUM).
- ii. BEAM/GIRDER TO COLUMN CONNECTIONS: A325 OR A490 TYPE BOLTS (3/4" DIAMETER MINIMUM).

 F. ANCHOR BOLTS: ASTM F1554, GRADE 36. FURNISHED COMPLETE WITH NUTS AND WASHERS. ANCHOR BOLTS SHALL HAVE HEADED ENDS OR NUTS WELDED (TACK AT BOTTOM SIDE OF NUT) AT EMBEDDED END.

 3. STEEL CONNECTIONS:
- A. MINIMUM SIZE WELD, UNLESS NOTED OTHERWISE, IS 1/4" FILLET.
 B. EXISTING STEEL MEMBERS SHALL BE EVALUATED BY THE E.O.R. PRIOR TO FIELD MODIFICATION FOR CONNECTIONS ASSOCIATED WITH NEW WORK.
- 4. SHOP AND ERECTION DRAWINGS SHALL BE SUBMITTED TO THE STRUCTURAL ENGINEER FOR REVIEW AND APPROVAL.
 NO FABRICATION OF STEEL SHALL COMMENCE WITHOUT APPROVED SHOP DRAWINGS.
- NO FABRICATION OF STEEL SHALL COMMENCE WITHOUT APPROVED SHOP DRAWINGS.

 5. WELDING SHALL BE PERFORMED BY CERTIFIED WELDERS LICENSED BY THE GOVERNING LOCALITY AND CERTIFIED IN ACCORDANCE WITH AWS D1.1. WELDING ELECTRODES SHALL BE ASTM A233, CLASS E70XX (USE LOW HYDROGEN
- ELECTRODES FOR A992, GRADE 50 STEEL).

 6. STRUCTURAL STEEL MEMBERS SHALL BE FINISHED PER THE FOLLOWING SPECIFICATIONS:

 A. WHERE SHOP PAINTING IS REQUIRED BY PROJECT SPECIFICATION, PROVIDE MODIFIED ALKYD PER

 MANUFACTURER REQUIREMENTS. ALL FIELD PAINTING SHALL BE PER ARCHITECTURAL DRAWINGS AND
- ALL BEAMS, EXCEPT CANTILEVER BEAMS, SHALL BE FABRICATED WITH NATURAL CAMBER UP.
 FIELD CUTTING OR BURNING OF STRUCTURAL STEEL IS PROHIBITED EXCEPT WHEN APPROVED BY THE ENGINEER OF RECORD.

STANDARD ABBREVIATIONS

STANDARD ABBREVIATIONS										
ADD'L	ADDITIONAL	EMBED.	EMBEDMENT	NOM.	NOMINAL					
ADJ.	ADJACENT	ENGR	ENGINEER	N.S.	NEAR SIDE					
A/E	DESIGN TEAM OF RECORD	E.O.R.	ENGINEER OF RECORD	N.T.S.	NOT TO SCALE					
ALT.	ALTERNATIVE	EQ.	EQUAL	O.C.	ON CENTER					
APC	ANTHONY POWER COLUMN	E.S.	EACH SIDE	O.D.	OUTSIDE DIAMETER					
	APPROXIMATE	EXT.	EXTERIOR	0.F.	OUTSIDE FACE					
		E.W.	EACH WAY	OPNG.	OPENING					
ARCH.	ARCHITECTURAL/ARCHITECT	FNDN	FOUNDATION	OPP.	OPPOSITE					
B.O.	BOTTOM OF	FIN.	FINISH	P.A.F.	POWER ACTUATED FASTENER					
BLDG.	BUILDING	FLR.	FLOOR	PC.	PIECE					
BM	BEAM	FRMG	FRAMING	P/C	PRECAST CONCRETE					
BOT.	BOTTOM	F.S.	FAR SIDE	PERP.	PERPENDICULAR					
BRG	BEARING	FTG	FOOTING	PL.	PLATE					
BSMT	BASEMENT	F.P.	FIRE PROTECTION	PLF	POUND PER LINEAR FOOT					
CANT.	CANTILEVERED	F.W.	FLAT WISE	PSI	POUND PER SQUARE INCH					
(C.E.)	CONCRETE ENCASED MEMBER	GA.	GAUGE	PSL	PARALLEL STRAND LUMBER					
CFS	COLD FORMED STEEL	GALV.	GALVANIZE	P-T	POST TENSIONED					
C.I.	CAST IRON	G.B.	GRADE BEAM	 Р.Т.	PRESERVATIVE TREATED					
C.I.P.	CAST IN PLACE	G-LAM	GLUE LAMINATED LUMBER	REINF.	REINFORCED					
C.J.	CONTROL JOINT	HORIZ.	HORIZONTAL	REQ'D	REQUIRED					
CLG	CEILING	H.P.	HIGH POINT	REV.	REVISION					
CLR	CLEAR	HT.	HEIGHT	R.O.	ROUGH OPENING					
CMU	CONCRETE MASONRY UNIT	HVAC	HEATING, VENTILATION & AIR							
COL.	COLUMN		CONDITIONING	SCHED.	SCHEDULE					
CONC.	CONCRETE	I.D.	INSIDE DIAMETER	SECT.	SECTION					
	COORDINATE	I.F.	INSIDE FACE	SIM.	SIMILAR STEP IN FOOTING					
CONTR.	CONTRACTOR	I.J.	ISOLATION JOINT	S.I.F.	STEP IN FOOTING					
COTR.	CONTRACT OFFICER'S TECHNICAL REP.	INFO.	INFORMATION	S.O.G	SLAB ON GRADE					
CTR.	CENTER	INT.	INTERIOR	SPEC.	SPECIFICATION					
D.B.A.	DEFORMED BAR ANCHOR	JT.	JOINT	SQR.	SQUARE					
DBL	DOUBLE		LIVE LOAD	S.S.	STAINLESS STEEL					
DEMO	DEMOLITION	LLH	LONG LEG HORIZONTAL	STD.	STANDARD					
DTL	DETAIL	LLV	LONG LEG VERTICAL	STIFF.	STIFFENER					
DIA.	DIAMETER	LSL	LAMINATED STRAND LUMBER	STIR.	STIRRUP					
DIAG.	DIAGONAL	LVL	LAMINATED VENEER LUMBER	STL.	STEEL					
DIM.	DIMENSION	L-W	LONG WAY	SQR.	SQUARE					
D.L.	DEAD LOAD	L.P.	LOW POINT	S-W	SHORT WAY					
DN	DOWN	L.W.	LIGHT WEIGHT	SYM.	SYMMETRICAL					
DO	DITTO	MAX.	MAXIMUM	T.C.	TERRA COTTA					
DWG(S)	DRAWING(S)	MECH.	MECHANICAL	T.O.	TOP OF					
DWL	DOWEL	MEP	MECHANICAL, ELECTRICAL, PLUMBING &	T&B	TOP AND BOTTOM					
(E)	EXISTING MEMBER OR DIMENSION	IVILI	F.P.		TEMPORARY					
EXIST.	EXISTING	MFR.	MANUFACTURER	T&G	TOUNGE AND GROOVE					
EA.	EACH	MIN.	MINIMUM	THK.	THICK(NESS)					
E/	EDGE OF	MISC.	MISCELLANEOUS	T.L.S.	TENSION LAP SPLICE					
•		M.O.	MASONRY OPENING	TR.	TRANSFER					
E.A.	EACH FACE EXPANSION JOINT	N.F.	NEAR FACE	TYP.	TYPICAL					
		I Nation	114411 1710							

N.F. NEAR FACE

NO. NUMBER

N.I.C. NOT IN CONTRACT

E.J. EXPANSION JOINT

E.L. ELEVATION

V.I.F. VERIFY IN FIELD

WITH

WATER PROOF

WWF WELDED WIRE FABRIC

CENTER LINE

NUMBER

DIAMETER

PLATE

W.A. WORK POINT

<u>LEGEND</u>									
[]	EXIST. CONCRETE FOOTING	_	WOOD JOIST						
г——— ¬ L——— J	CONCRETE FOOTING	0	WOOD RAFTER						
	EXIST. BRICK MASONRY	2K/2J 2V/2K	WOOD BEAM, #J INDICATES NO. OF JACK STUDS, #K INDICATES NO. OF KING STUDS						
	BRICK MASONRY		WOOD HEADER						
	EXIST. CONCRETE MASONRY (CMU)		STEEL BEAM						
	CONCRETE MASONRY (CMU)		INDICATES EXIST. WOOD POST THRU OR DOWN						
Δ	EXIST. CONCRETE WALL		INDICATES EXIST. WOOD POST ABOVE						
4	CONCRETE WALL OR CURB	•	INDICATES EXIST. STEEL POST THRU OR DOWN						
	EXIST. WOOD BEARING WALL	6	INDICATES EXIST. STEEL POST UP						
	WOOD BEARING WALL (2x6 ❷ 16" U.N.O.)	— п—	INDICATES WOOD POST THRU OR DOWN (APC POSTS SUPPORTING GIRDERS TO BE CONTINUOUS THROUGH						
	WALL BELOW TO BE REMOVED	_	FLOOR CONSTRUCTION DOWN TO THE FOUNDATION LEVEL)						
	BEARING WALL ABOVE	— 	INDICATES WOOD POST ABOVE (REFER TO NOTES FOR						
۷	EXIST. WOOD JOIST	_	WOOD POST THRU OR DOWN)						
O	EXIST. WOOD RAFTER		INDICATES STEEL POST UP						
	EXIST. WOOD BEAM	——	INDICATES STEEL POST THRU OR DOWN						
////	EXIST. FRAMING TO BE REMOVED	(X)	DENOTES CONNECTION REQUIREMENTS (SEE SCHED.)						
	EXIST. STEEL BEAM	(##'-##")	INDICATES TOP OF FOOTING ELEVATION						

U.N.O. UNLESS NOTED OTHERWISE

U-P UNDERPINNING

VERT. VERTICAL



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210 N. Lee St., Suite 210 Alexandria, VA 22314 T: 703.350.4151 1200ae.com

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- DRAWING TITLE -


GENERAL NOTES

- DATE - 3/11/2021	
- SCALE -	

- DRAWING TITLE -

S001

						DES	SIGN	LOADS AND FACTORS				DESIGN CODE: 2015 IRC AS MODIFIE RESIDENTIAL CODE	ED BY DC	MR-12B
LIVE LOAD DATA		ROOF LOAD DATA		DEAD LOAD DATA		WIND LOAD DATA		EARTHQUAKE DESIGN DATA		SOIL DESIGN DATA		DEFLECTIONS LIMITS FOR WOOD FRAMING		
FLOOR OR ROOF AREA	LOAD (PSF)	LOAD TYPE	VALUE (PSF)	AREA	VALUE (PSF)	PARAMETER	VALUE	PARAMETER	VALUE	PARAMETER*	VALUE		LL	TL Δτ.(in)
TYP. FLOOR (U.N.O.)	40	NON-DRIFT SNOW	30	FLOOR	15	ULTIMATE DESIGN WIND SPEED	115 MPH	SHORT-PERIOD MAP VALUE (S _S)	15.0% g	AT-REST PRESSURE CONDITION	65 PSF/FT	RAFTERS	L/360	L/240 0.75
STAIRS	40	DRIFTING SNOW	PER CODE	PARTITION	10	WIND EXPOSURE	В	SEISMIC SITE CLASS	D	ACTIVE PRESSURE CONDITION	45 PSF/FT	ROOF BEAMS	L/240	L/180 0.75
SLEEPING ROOMS	30			FLAT ROOF	13	IMPORTANCE FACTOR	RESIDENTIAL SEISMIC DESIGN CATEGORY TYPE PER R301.2.2, THE SEISMIC PROVISIO		16.0% g	PASSIVE PRESSURE CONDITION	180 PSF/FT	JOIST	L/480	L/360 0.625
ATTICS WITH STORAGE	20	PARAMETER	VALUE	SLATE ROOF	31	MINIMUM ULTIMATE			10.0% g	SURCHARGE LOADS	60 PSF	FLOOR BEAMS	L/360	L/240 0.75
ATTICS WITHOUT STORAGE	10	GROUND SNOW LOAD (Pg)	30			AND C&C)		RESIDENTIAL SEISMIC DESIGN	A	S.O.G. COEFFICIENT OF SLIDING FRICTION	0.3	JOISTS/BEAMS-TILE OR STONE FINISH	L/600	L480 0.5
		CEILING APPLIED	YES			SHEAR WALL TYPE			501.2.2, THE SEISMIC PROVISIONS OF THE RESIDENTIAL		1.5	MASONRY LINTELS (OR XFER BEAMS		
						EXIST. TO REMAIN		BUILDING CODE ARE NOT APPLICABLE TO DET. DWELLINGS ASSIGNED TO SEISMIC DESIGN CAT	DETACHED ONE—FAMILY CATEGORY A, B, OR C.	TOTAL/DIFFERENTIAL SETTLEMENT	1/.5 INCH	OF EXIST MASONRY)	L/600	L/600 0.3
										* PER IBC 2015 PRESUMPTIVE SOIL D VALUES	ESIGN			

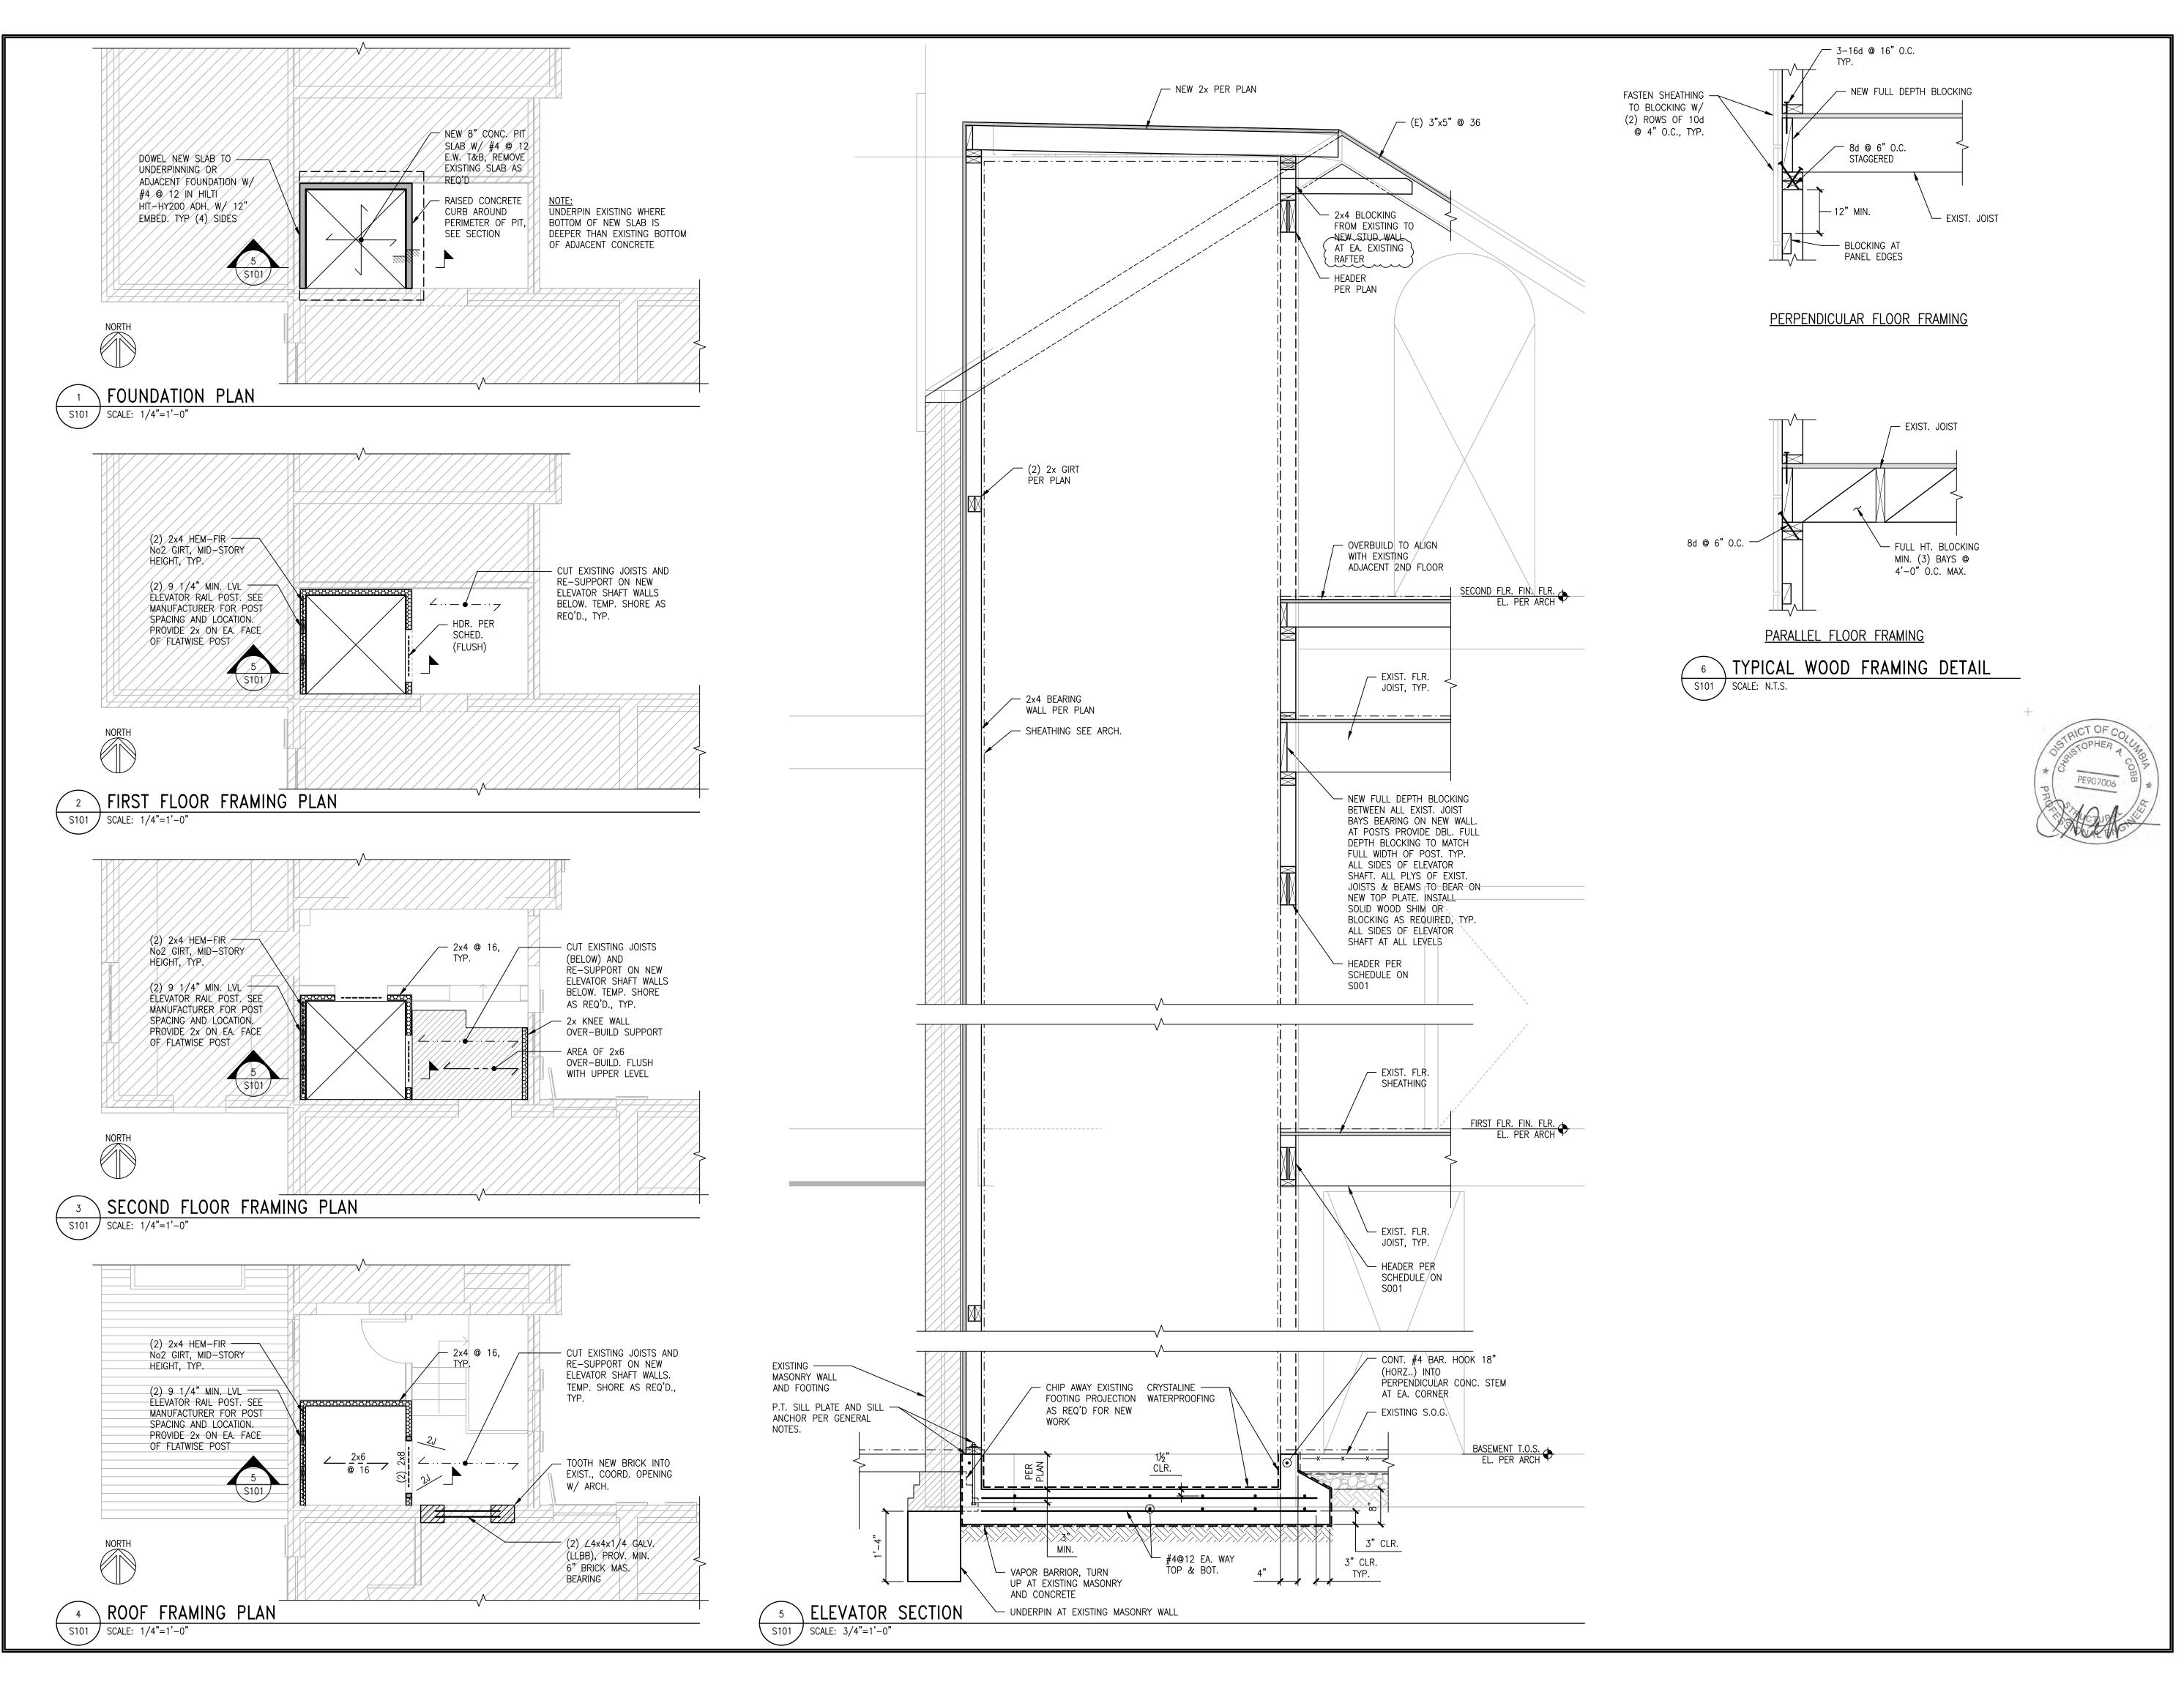



1050 30th Street, NW Washington, DC 20007 Telephone (202) 674-9226 www.valhawkins.com

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210 N. Lee St., Suite 210 Alexandria, VA 22314 T: 703.350.4151 1200ae.com

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- DRAWING TITLE -

ELEVATOR PLANS AND **DETAILS**

> - DATE -3/11/2021 - SCALE -

- DRAWING TITLE -

S101