## 122430th St NW, WASHINGTON, DC 20007 CONCEPT REVIEW SET

LOT:0041


SCOPE OF WORK


WINDOW REPLACEMENT ON THE REAR OF THE MAIN HOUSE & ACCESSORY BUILDING INTERIOR WORK APPROVED UNDER A SEPARATE PERMIT #B2208283

SQUARE:1209

LOCATION

VICINITY MAP

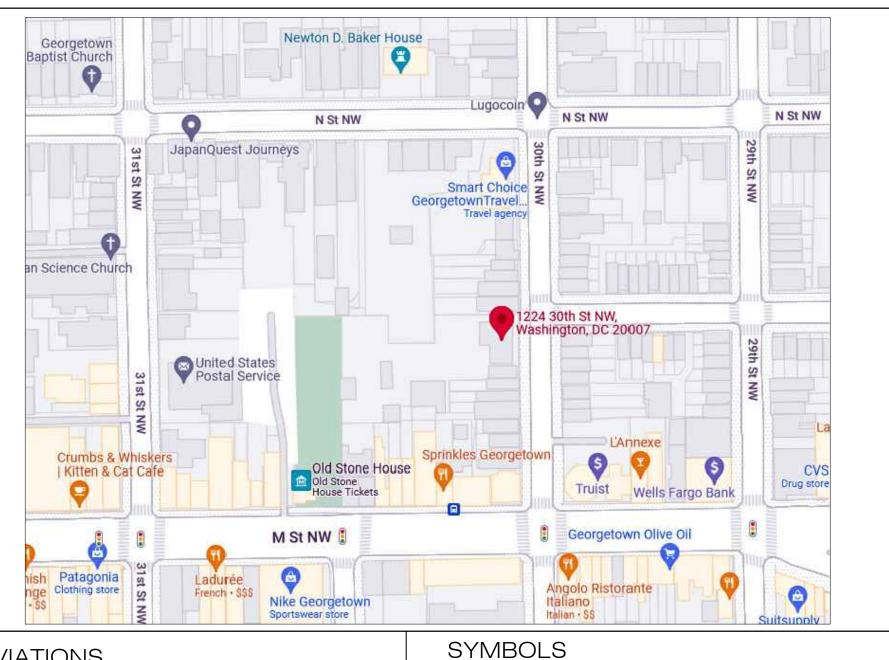

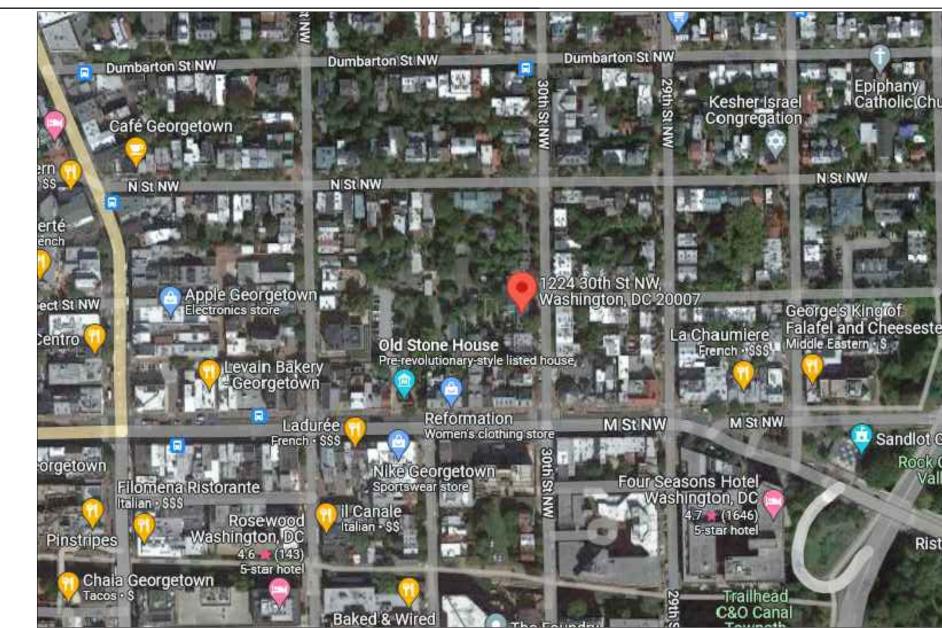

**GENERAL NOTES** 

GENERAL NOTES

DIVISION 1 - GENERAL REQUIREMENTS

THE SUB-CONTRACTOR SHALL READ ALL GENERAL AND SPECIFIC NOTES AND BE BOUND TO THEIR REQUIREMENTS SUB-CONTRACTOR SHALL VISIT SITE AND EXAMINE EXISTING CONDITIONS PRIOR TO BID. THE SUB-CONTRACTOR SHALL VISIT THE SITE AND FAMILIARIZE HIMSELF WITH THE CONDITIONS

UNDER WHICH THE WORK IS TO BE PERFORMED. THE BID SHALL BE BASED ON THE USE OF ALL EQUIPMENT, MATERIALS, MANUFACTURERS AND

SYSTEMS DESCRIBED IN THIS SET OF CONSTRUCTION CONTRACT DOCUMENTS UNLESS SPECIFICALLY INDICATED IN THE PRICE SUBMISSION. UNLESS AN ITEM IS SPECIFICALLY EXCLUDED OR A SUBSTITUTION IS LISTED ON THE SUBMISSION BY THE SUB-CONTRACTOR, HE SHALL BE RESPONSIBLE FOR THE FULL EXTENT OF ALL WORK CONTAINED IN THE CONTRACT DOCUMENTS.

ANY QUESTIONS OR CONFLICTS REGARDING ARCHITECTURAL DRAWINGS OR SPECIFICATIONS ARE TO

BE IN WRITING AND DIRECTED TO RICH MARKUS AT RICH MARKUS ARCHITECTS IF CONFLICTS ARE DISCOVERED AT ANY TIME BETWEEN ENGINEERING AND ARCHITECTURAL DRAWINGS, ARCHITECT

SHALL BE CONTACTED AT ONCE TO RESOLVE THE PROBLEM. IF ARCHITECT IS NOT CONTACTED, SUB-CONTRACTOR SHALL ACCEPT ANY RESPONSIBILITY TO CORRECT ANY WORK INSTALLED THAT IS NOT IN ACCORDANCE WITH THE DWGS IF CONFLICTS ARE DISCOVERED AT ANY TIME BETWEEN SITE CONDITIONS AND ARCHITECTURAL DWGS, ARCHITECT SHALI

EXACT LOCATIONS OF ALL UTILITIES PRIOR TO CUTTING AND DIGGING. ALL SLAB PENETRATION SHALL

TAKE PRECEDENCE AND ALL CONFLICTS SHOULD BE BROUGHT TO THE ATTENTION OF THE ARCHITECT IMMEDIATELY. SUB-CONTRACTOR SHALL VERIFY ALL DIMENSIONS AND QUANTITIES IN THE FIELD.

WHERE SLAB CUTTING IS REQUIRED, IT SHALL BE THE SUB-CONTRACTOR'S RESPONSIBILITY TO VERIFY EXACT LOCATIONS OF ALL UTILITIES PRIOR TO CUTTING AND DIGGING. ALL SLAB PENETRATION SHALL BE DONE BY EITHER CORE DRILLING OR SAW CUTTING SLAB. FOR SLABS ON GRADE, SUB-CONTRACTOR SHALL BACKFILL IN LIFTS NOT TO EXCEED 8" AND TAMPER USING A MECHANICAL COMPACTOR. NEW PATCHING SHALL BE THE SAME THICKNESS AS EXISTING SLAB AND, SHALL ALIGN AND MAINTAIN THE LEVEL OF EXISTING SLAB.

0. SUB-CONTRACTOR SHALL PERFORM ALL WORK IN ACCORDANCE WITH NATIONAL, STATE AND LOCAL CODES.

11. ALL PERMITS, INSPECTIONS AND FEES ARE TO BE OBTAINED, SECURED AND PAID FOR BY THE SUB-SUBMITTAL OF A SUBSTITUTION IN WRITING OR BY SAMPLE TO ARCHITECT. ANY COST CHANGES MUST ALSO BE SUBMITTED. THE ARCHITECT WILL COMMUNICATE THE DECISION TO THE SUB-CONTRACTOR BY LETTER IF THE SUBMISSION IS ACCEPTED. SUBSTITUTION FOR LONG LEAD ITEMS MUST BE PROPOSED EARLY ENOUGH IN THE CONSTRUCTION PROCESS THAT NO DELAY IS CREATED IN COMPLETION OF THE PROJECT DUE TO THE SUBSTITUTION, OTHERWISE THE SUB-CONTRACTOR SHALL ASSUME RESPONSIBILITY FOR ANY COST

TO THE OWNER ARISING OUT OF SUCH WORK. 3. WARRANTIES, GUARANTEES AND MANUFACTURER'S INSTRUCTIONS ON EQUIPMENT FURNISHED AND INSTALLED BY THE SUB-CONTRACTOR SHALL BE ASSEMBLED INTO A NOTEBOOK AND GIVEN TO THE

OWNER AT THE TIME OF OCCUPANCY. 14. AT COMPLETION OF THE WORK, THE SUB-CONTRACTOR SHALL ENSURE ALL SURFACES ARE CLEAN

AND UNMARKED, AND THAT ALL SYSTEMS ARE OPERATING PROPERLY. 15. SUB-CONTRACTOR SHALL REPAIR ALL DAMAGE CAUSED BY HIM OR HIS PERSONNEL DURING

16. SUB-CONTRACTOR SHALL CLEAN ALL WINDOWS AT THE COMPLETION OF CONSTRUCTION. WINDOWS AT THE COMPLETION OF CONSTRUCTION.

17. SUB-CONTRACTOR SHALL ENSURE THAT ALL PAINT HAS BEEN REMOVED FROM ALL WINDOW

SURFACES PRIOR TO DELIVERY OF THE SPACE. 18. ALL MISCELLANEOUS NAILS, HANGERS, STAPLES, WIRES AND WIRE CONDUITS SHALL BE REMOVED

FROM WALLS AND CEILINGS WHERE THEY WILL BE EXPOSED IN THE NEW WORK. 19. HVAC SUB-CONTRACTOR TO CLEAN AND CHECK EXISTING HVAC SYSTEM AND REPORT TO ARCHITECT ANY

PROBLEMS OR REPAIRS REQUIRED. 20. SUB-CONTRACTOR SHALL EXAMINE ALL DRAWINGS RELATED TO HIS AND OTHER TRADES, AND SHALL

BE FULLY INFORMED AS TO THE EXTENT OF THIS CONTRACT AND ALL INCLUDED WORK ON PLANS IN OTHER TRADES. 21. ALL SYSTEMS AND EQUIPMENT TO BE GUARANTEED FOR ONE YEAR FREE LABOR AND MATERIALS.

DEMOLITION NOTES

FLOOR / CEILING CONSTRUCTION

ROOF CONSTRUCTION

SHAFT

 COORDINATE THE REMOVAL AND PROPER DISPOSAL OF ALL CONSTRUCTION DEBRIS AND TAKE NECESSARY PRECAUTIONS TO PROTECT THE BUILDING ELEMENTS TO REMAIN AND OCCUPANTS FROM CONSTRUCTION RELATED DEBRIS, DAMAGE, INJURY OR ACCIDENT.

0 HR:

0 HR:

1 HR:

DTL DWG ELEC ELEV EQUAL EQUIP EXST. EQUIPMEN1 **EXISTING** FINISH FLOOR **FLOOR** FLUOR FLUORESCENT GROUND FAULT INTERRUPTER GENERAL CONTRACTOR GLAZING **GYPSUM** GYPSUM WALL BOARD

HDWR HARDWARE

HM HOLLOW METAL

**ABBREVIATIONS** 

ACOUSTICAL CEILING TILE

AFF ABOVE FINISH FLOOR

ALL AROUND

ALUMINUM

ANODIZED

**BOTH SIDES** 

**CENTER LINE** 

CONTINUOUS

DIMENSION

DOWN

DOUGLAS DOOR DETAIL

DRAWING

ELECTRICAL

**ELEVATION** 

CONCRETE MASONI

CEILING

ACOUS ACOUSTICAL

ADJ ALUM ANOD

CONT

DOUG

ROP REFLECTE
RND ROUND
RO ROUGH OF
SC SOLID COF
SIM SIMILAR
SHT SHEET
STND STAINED
STL STEEL
STOR AGE **ROUGH OPENING** SOLID CORE TELEPHONE TYPICAL TME TO MATCH EXISTING UON VCT UNLESS OTHERWISE NOTED VINYL COMPOSITION TILE VERT VERTICAL
VEN VENEER VERIFY IN FIELD VWC VINYL WALL COVERING WITH


MILLWORK CONTRACTOR

MISC MISCELLANEOUS

MEDIUM DENSITY FIBERBOARD

MEDIUM DENSITY OVERLAY

MASONRY OPENING MOUNTED OPPOSITE PLYWD PLYWOOD PAINTED REFLECTED CEILING PLAN

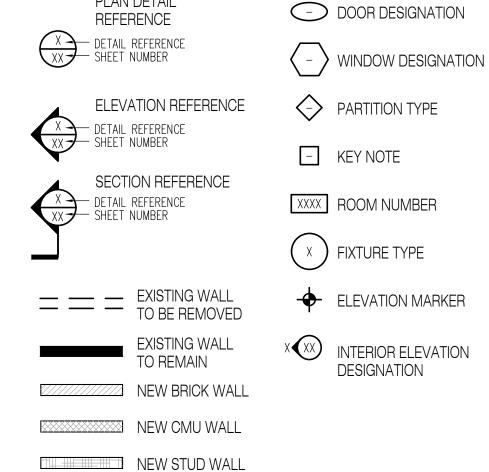

PLAN DETAIL

INDEX A000 COVER

A001 SITE PLAN A002 EXISTING VIEWS A003 EXISTING VIEWS

A100 EXISTING FLOOR PLANS A101 PROPOSED FLOOR PLANS

A200 MAIN HOUSE EXISTING REAR ELEVATION A201 MAIN HOUSE PROPOSED REAR ELEVATION

A202 PAVILION PLAN & ELEVATIONS

A203 PAVILION REAR ELEVATION


GENERAL NOTES	1224 30TH ST NW WASHINGTON DC 20007	GEN		
ZONING DISTRICT	R20		TOTAL LOT AREA 29,660 SF	GENE
JSE GROUP	(R3) RESIDE	ENTIAL	TOTAL LOT WIDTH 93.60'	USE C
	· , ,			TYPE
				BUILD
_OT	0041			BUILD
SQUARE	1209			NUME
REQUIREMENT	EXISTING	ALLOWABLE /	PROPOSED	NUME
		REQUIRED		FIRE A
LOT OCCUPANCY	6,948 SF (23%)	40% (11,864)	6,948 SF (23%- NO CHANGE)	AREA
HEIGHT	33'-0" 3 STORIES + CELLAR	35 FT / 3 STORIES	33'-0" 3 STORIES + CELLAR (NO CHANGE)	SMO
	_	_	<u> </u>	INSUL
./1.11.				COV
SIDEYARD WIDTH	3'-9"	5'	3'-9" (NO CHANGE)	BUILDI
				ELECT
REAR YARD SETBACK	184'-0"	20'	184'-0" (NO CHANGE)	PLUME
			1010 (11001) (1102)	GREEN
PARKING	3	N/A	3 (NO CHANGE)	ACCES
		Δ front sethack consistent		_
FRONT YARD	6'-9"	A front setback consistent with at least one (1) of the immediately adjacent	6'-9" (NO CHANGE)	FIRE F
		immediately adjacent properties on either side		FIRE S
DWELLING UNITS	1	-	1	EXTER
				EXTER


NERAL NOTES / CODE ANALYSIS 1224 30th St NW ERAL INFORMATION **EXISTING LOT** PROPOSED BUILDING RESIDENTIAL/R-3 RESIDENTIAL /R-3 GROUP OF CONSTRUCTION VΒ 6,948 SF DING FOOTPRINT 6.948 SF DING HEIGHT 33'-0"- 3 STORIES + CELLAR 33'-0"- 3 STORIES + CELLAR <u>1BER OF EXITS</u> **1BER OF STORIES** NONE ALARM: NONE 2,327 SF A OF WORK YES; HARDWIRED AND INTERCONNECTED ON DEDICATED OKE DETECTORS CIRCUIT WITH BATTERY BACKUP 5399 JLATION: YES; EXTERIOR WALLS @ R20 & ROOF @ R-49, ONLY FOR RENOVATED AREAS VERING CODES 2017 DCMR 12A, DC BUILDING CODE AMENDMENTS, 2015 INTERNATIONAL RESIDENTIAL CODE (IRC), 2015 IEBC 2017 DCMR 12C, DC ELECTRICAL CODE 2017 DCMR 12F, DC PLUMBING CODE 2017 DCMR 12K, DC GREEN CONSTRUCTION CODE ICC / ANSI A117.1 2010 RATINGS SEPARATION WALLS (PROPERTY LINE WALLS) 2 HR (EXISTING TO REMAIN) ERIOR BEARING WALL 0 HR 09-13-2022 ERIOR FRONT AND REAR WALLS 0 HR: NON BEARING WALLS 0 HR: **COLUMNS AND GIRDERS** (none provided)

MARKUS NW 20007 S 30th


shington 2

DRAWING NUMBER

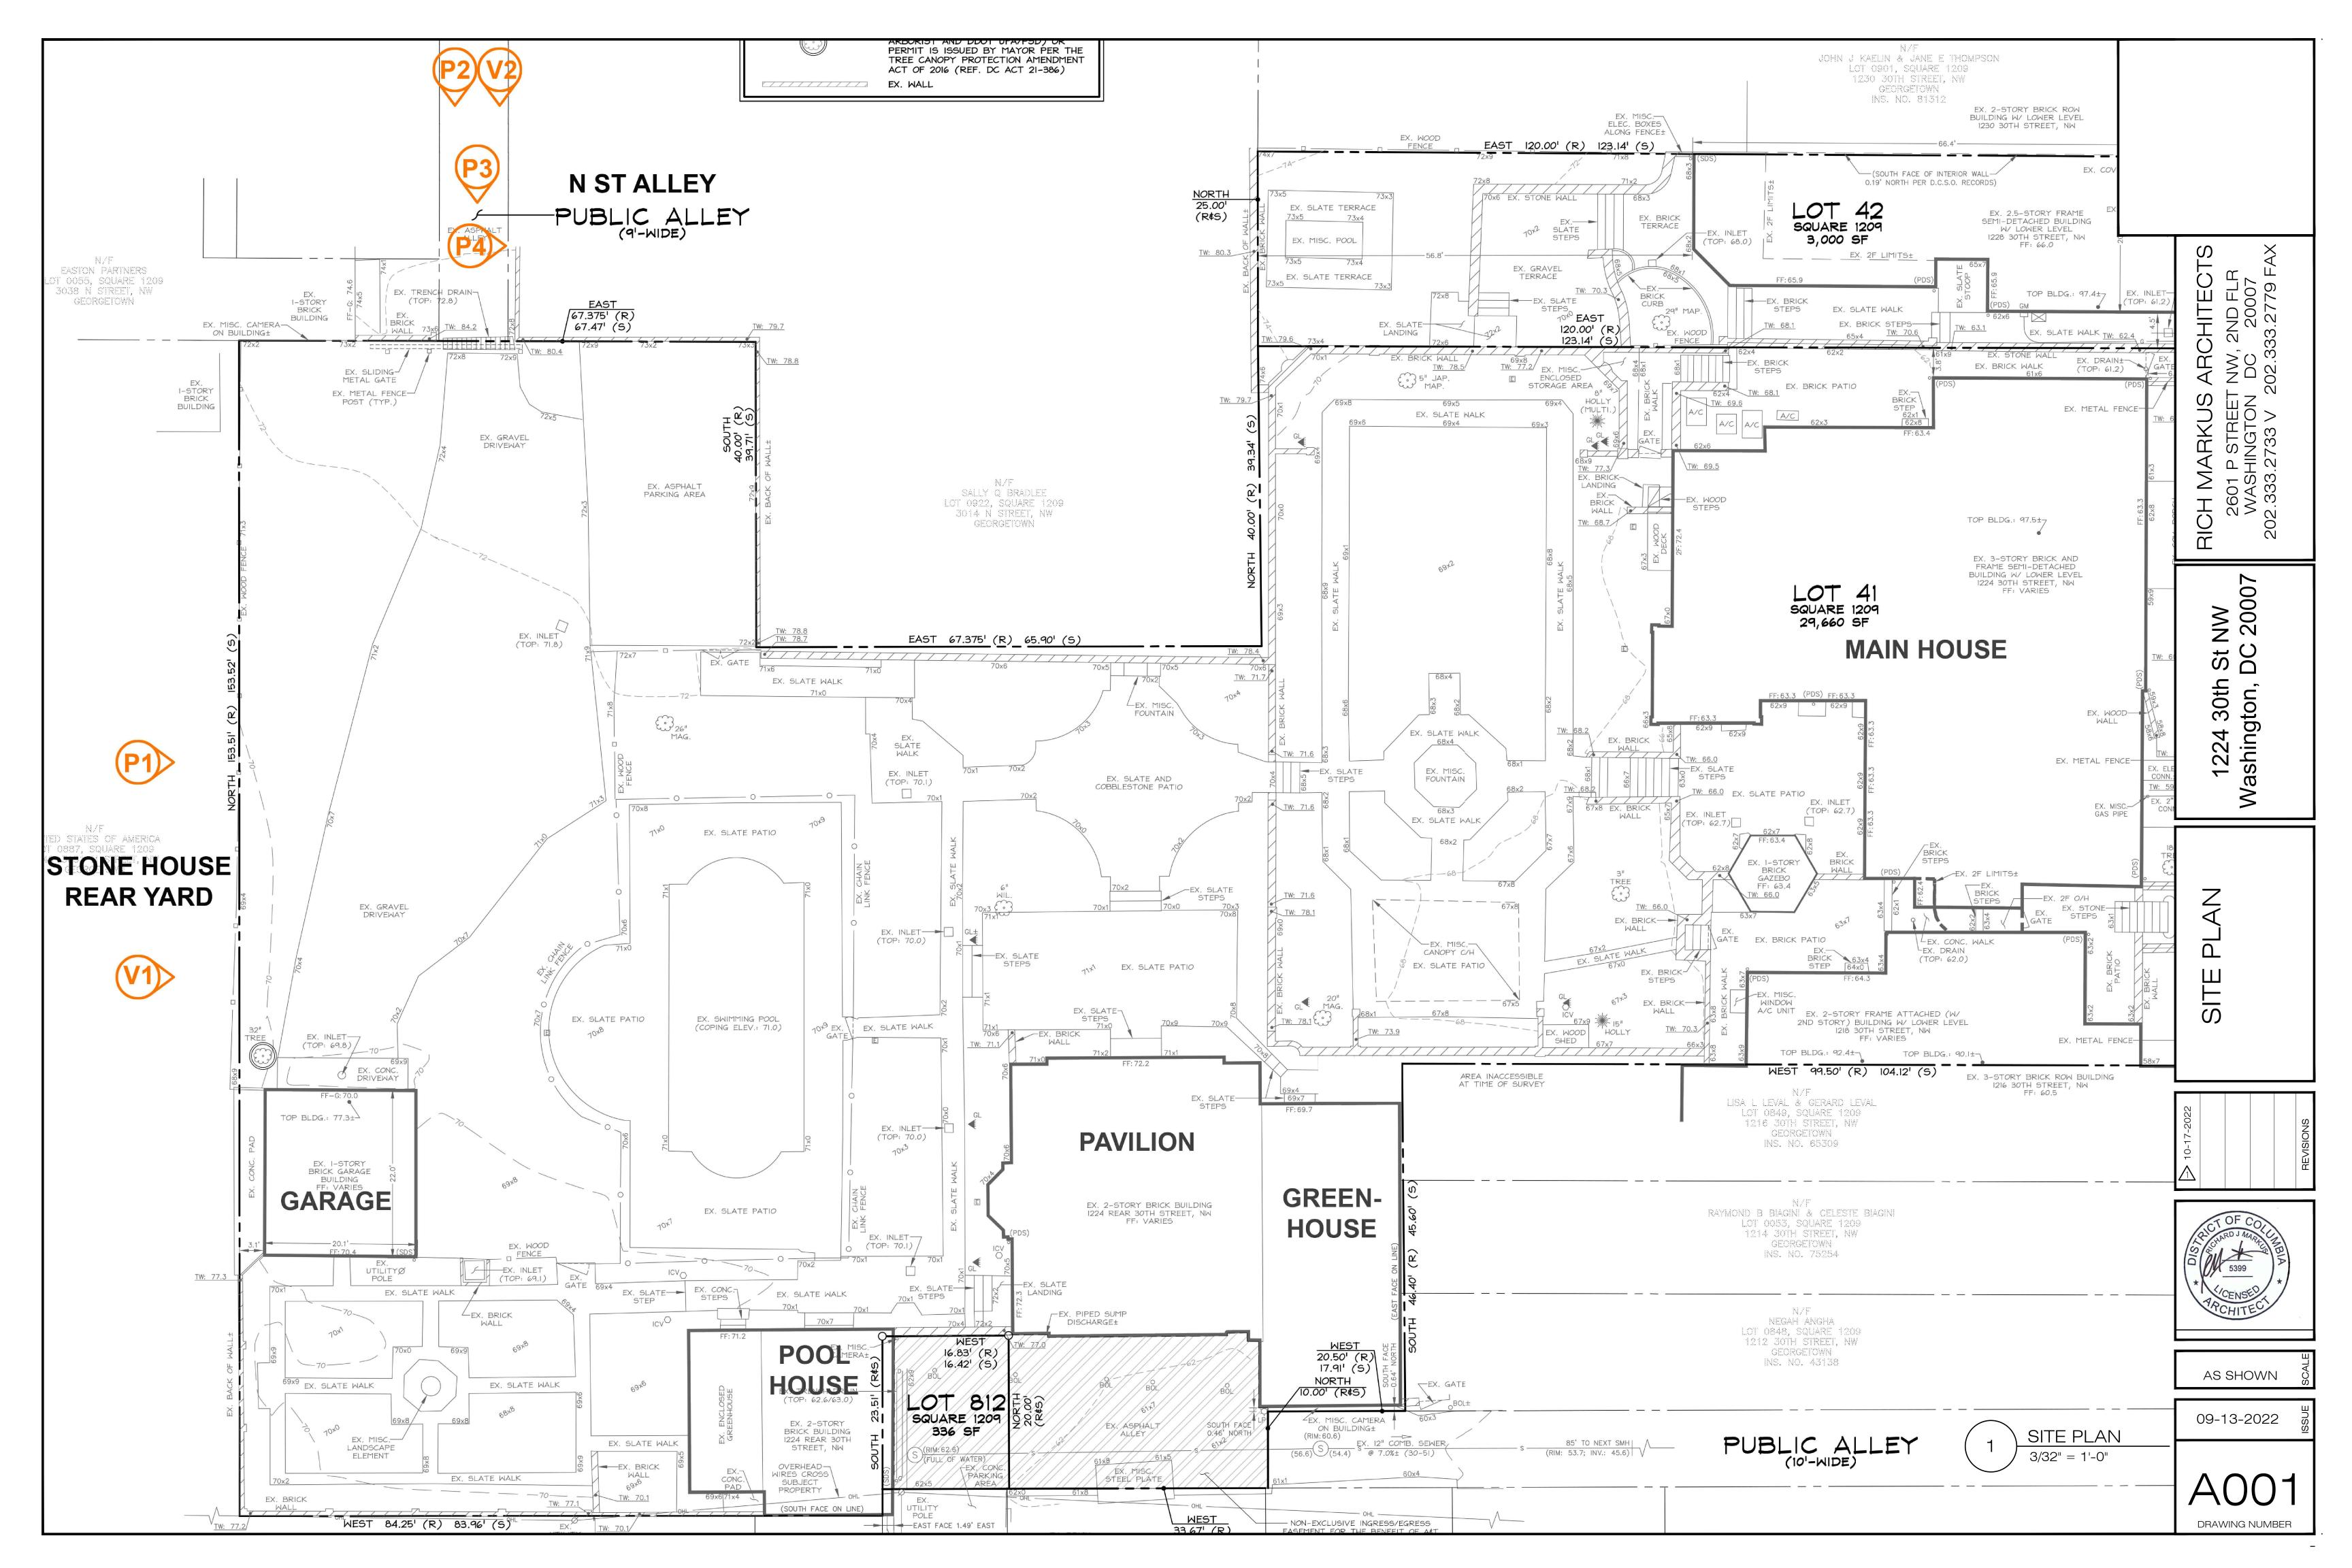

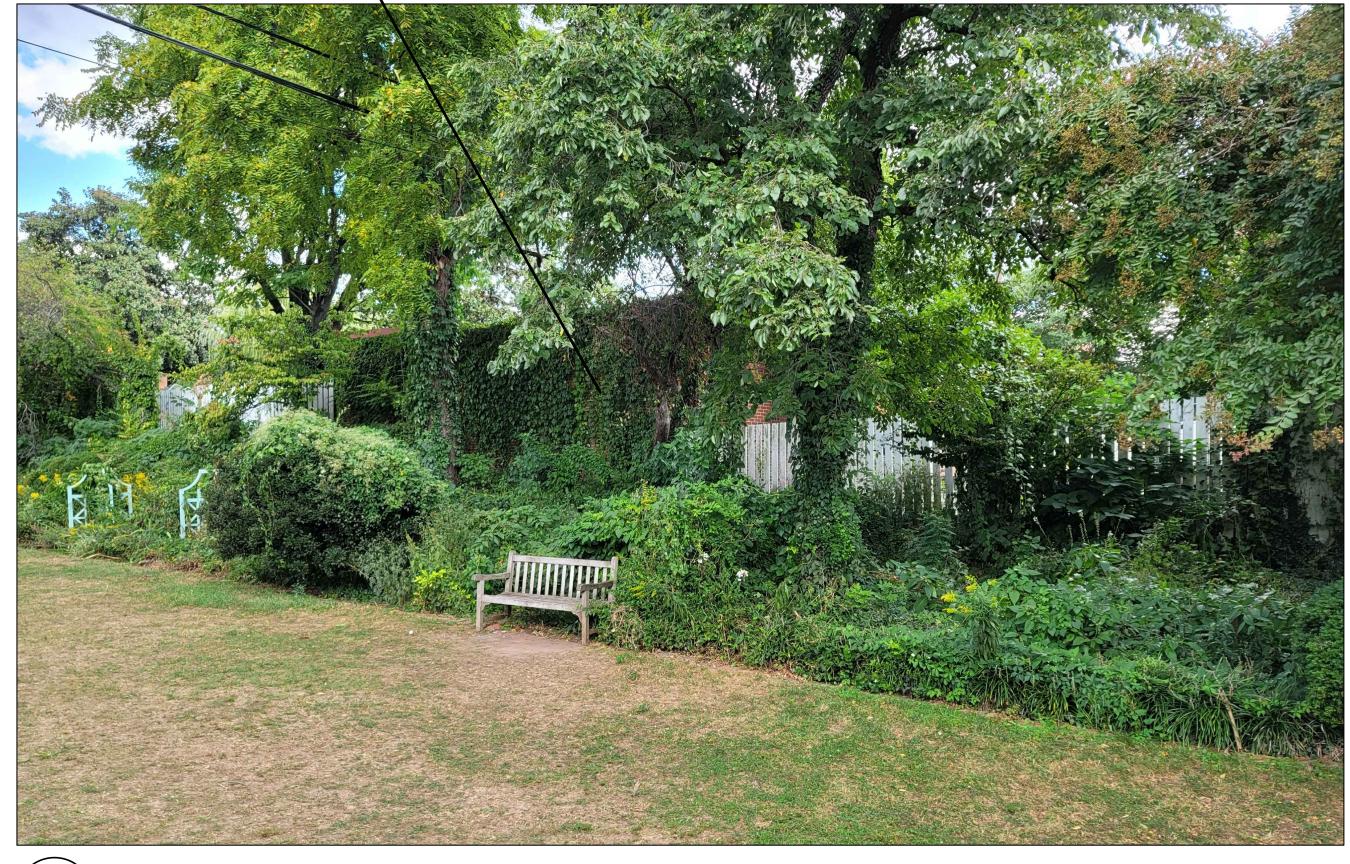

1 P01- VIEWS FROM THE STONE HOUSE REAR YARD NTS

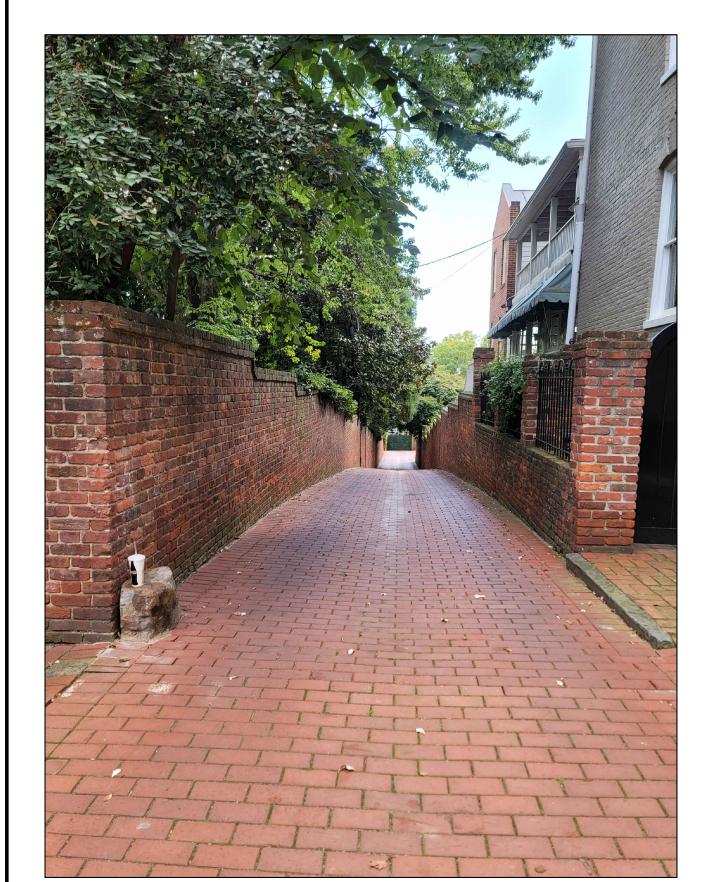






BO3 - N ST ALLEY
NTS

## EXISTING GARAGE



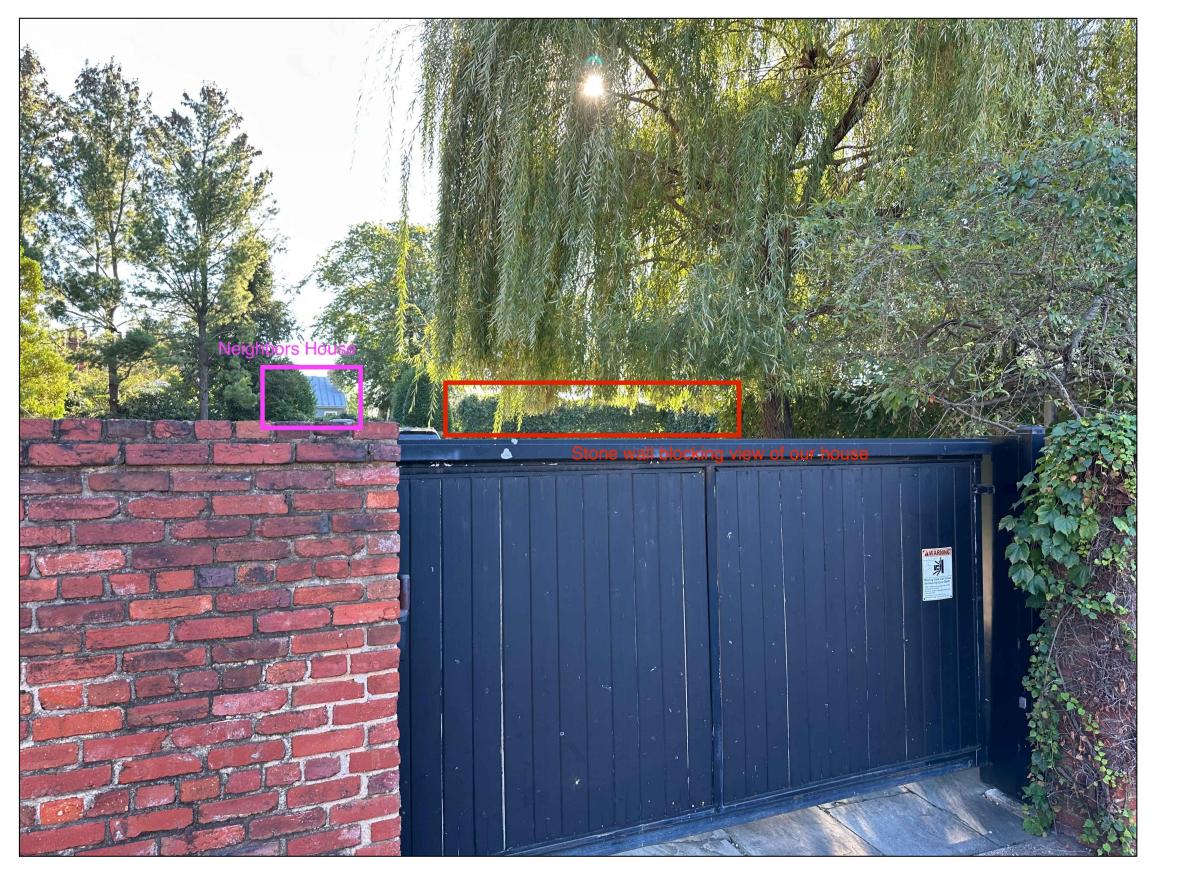





ICH MARKUS ARCHITECTS
2601 P STREET NW, 2ND FLR
WASHINGTON DC 20007

1224 30th St NW Washington, DC 2000

EXISTING VIEWS

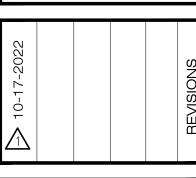


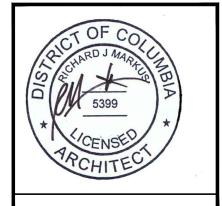

AS SHOWN

09-13-2022



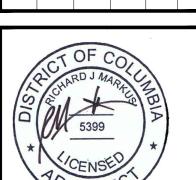




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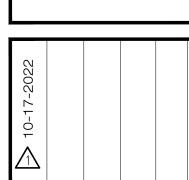





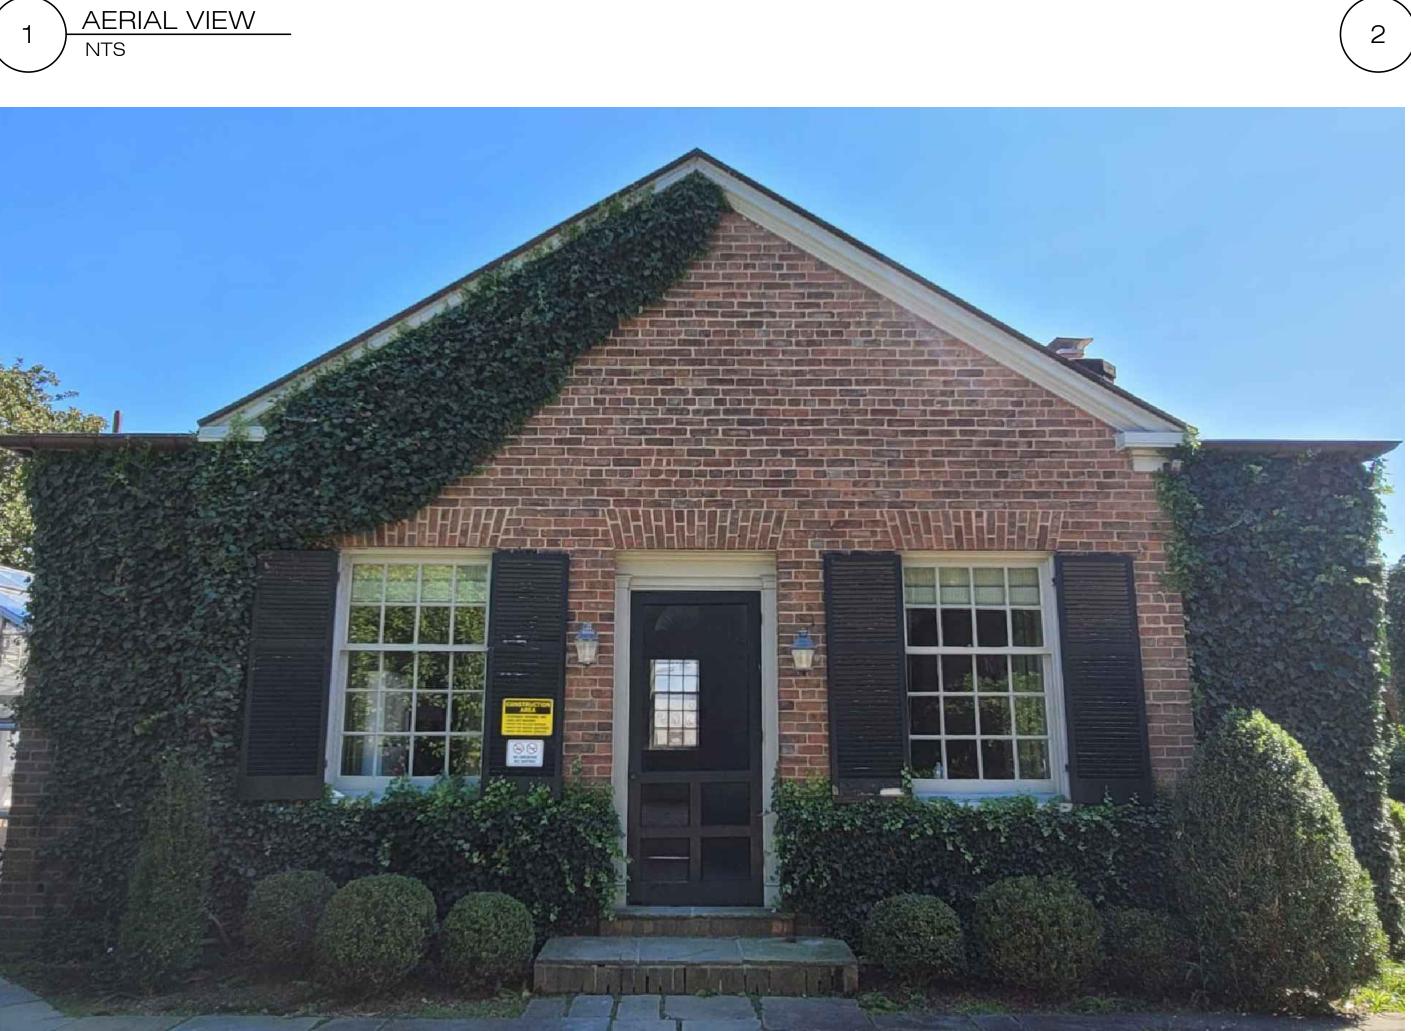


3 PAVILION ENTRANCE- VIEW 02

PAVILION EXISTING REAR- VIEW 03



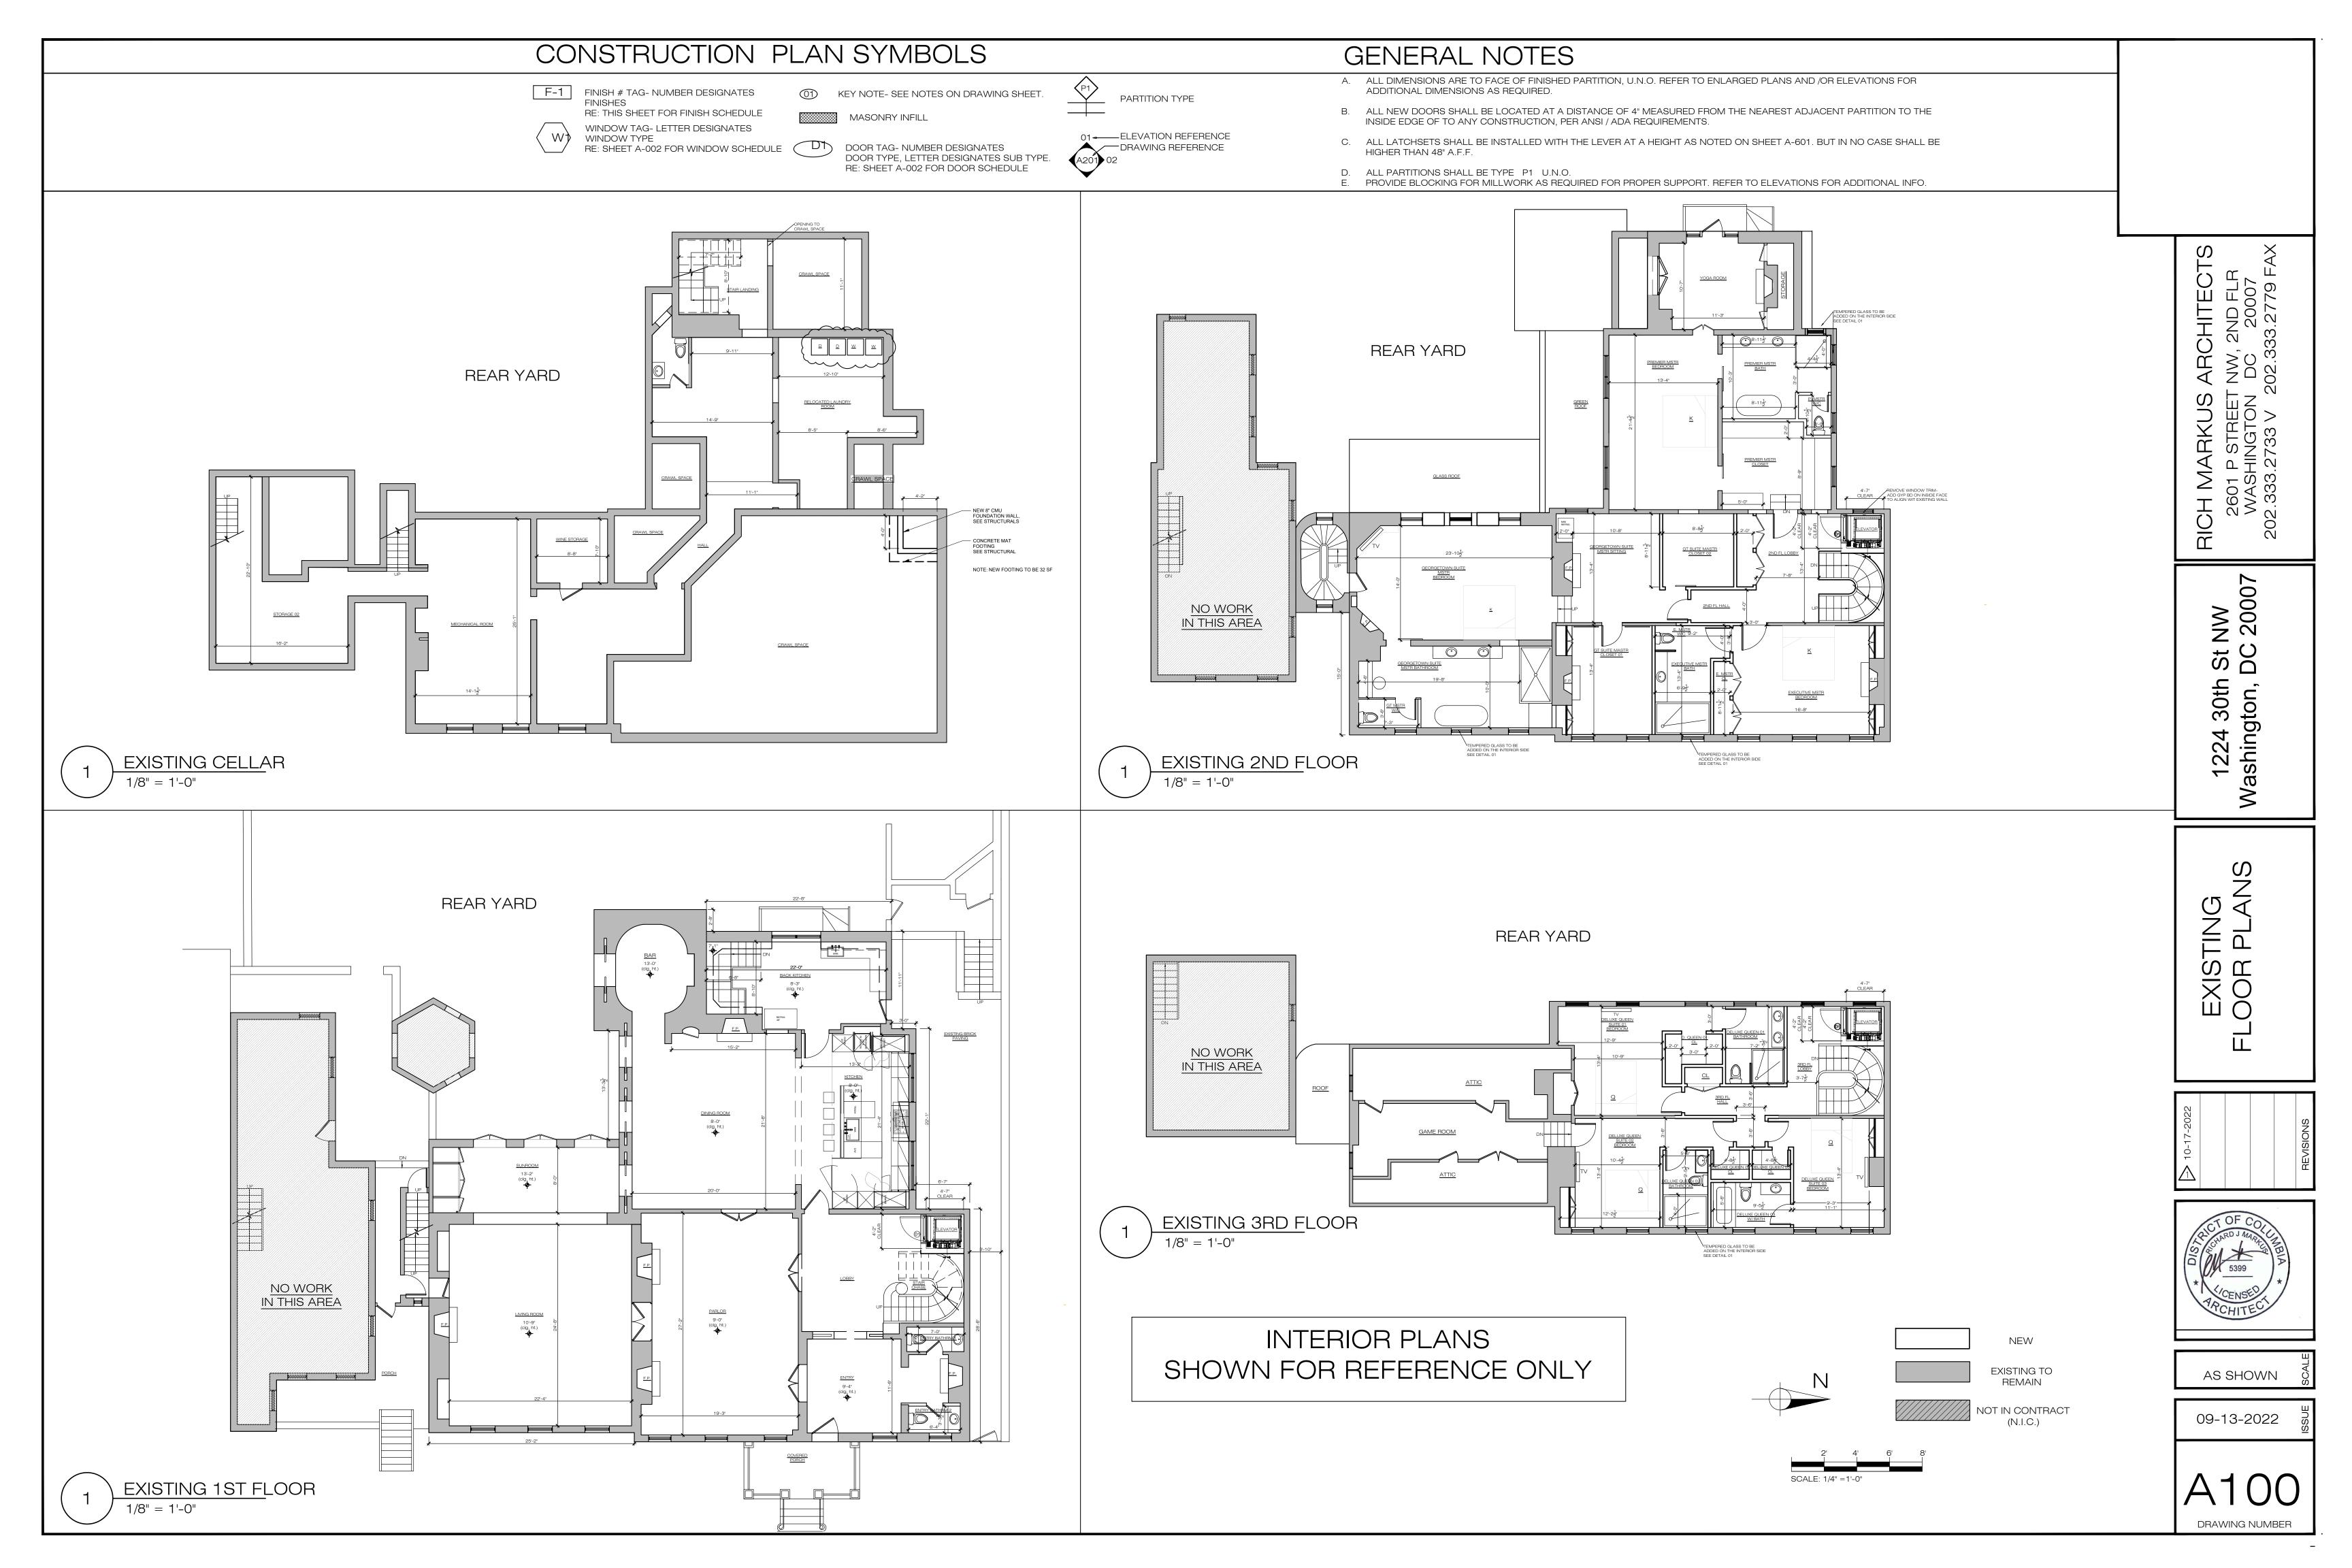

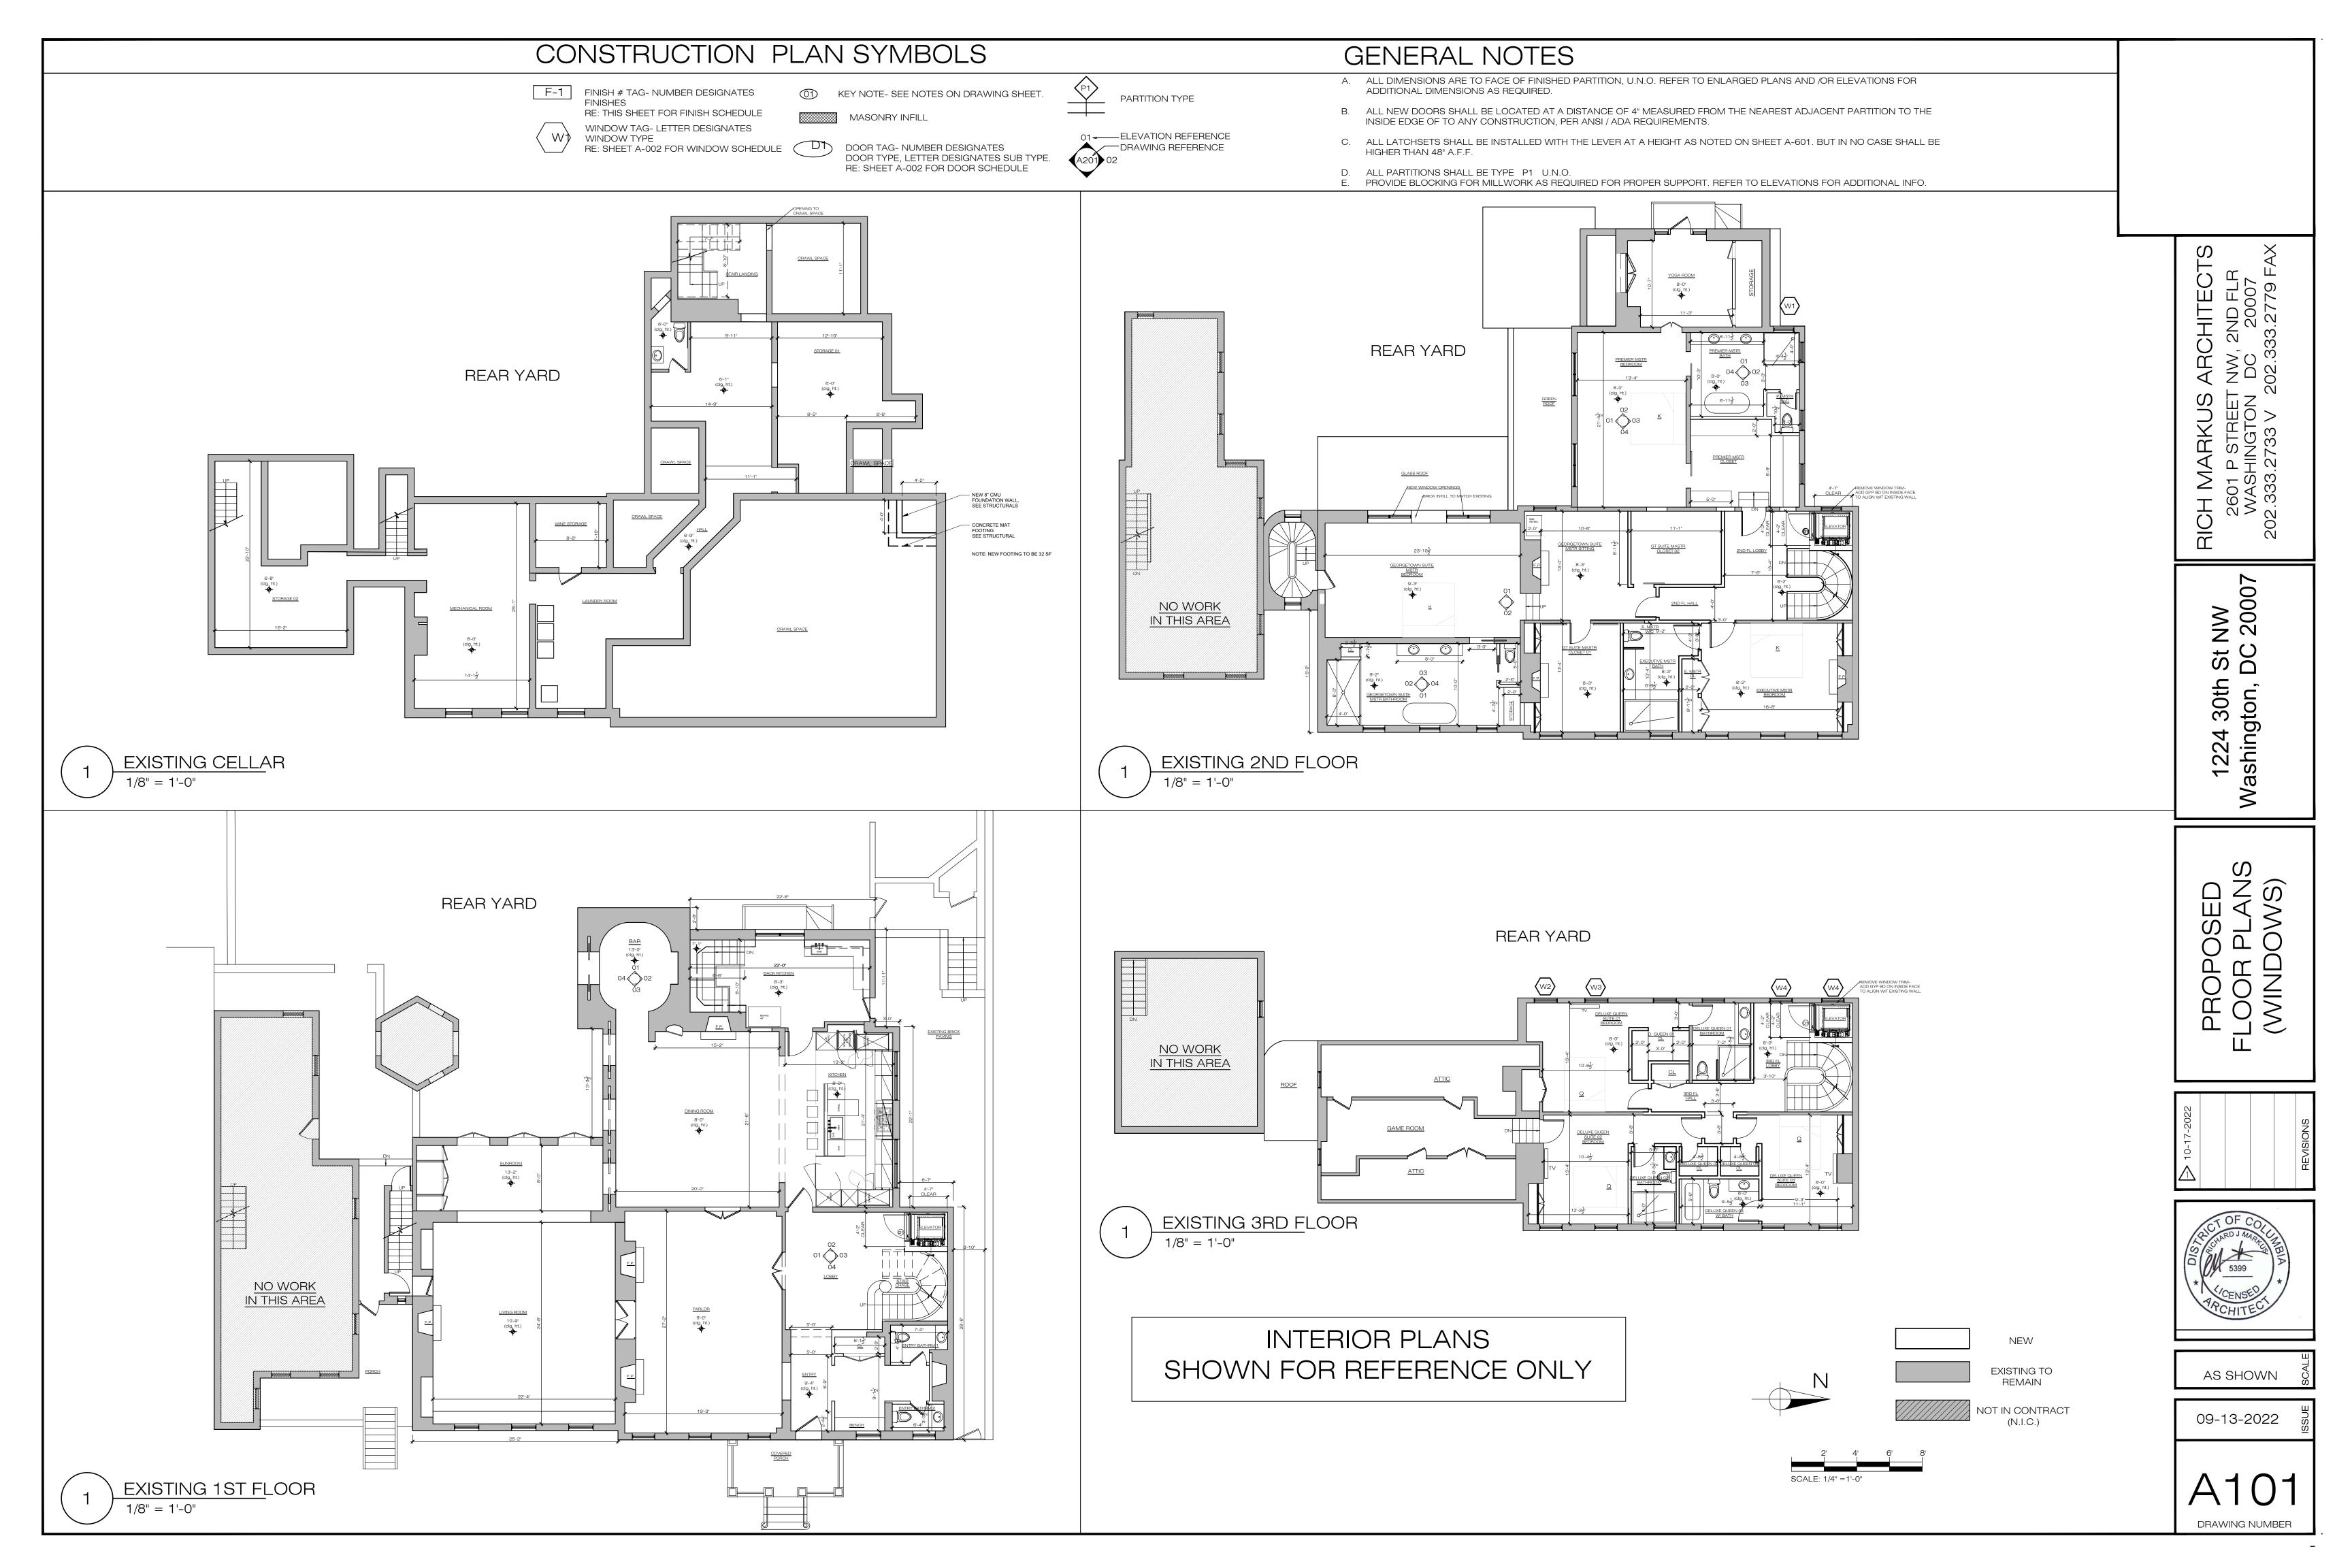


MAIN HOUSE EXISTING REAR ELEVATION 1/4" = 1'-0" St NW
2601 P STREET NW, 2ND FLR
WASHINGTON DC 20007
202.333.2733 V 202.333.2779 FAX

1224 30th St NW Washington, DC 200

MAIN HOUSE
EXISTING
EAR ELEVATION

D 10-17-2022

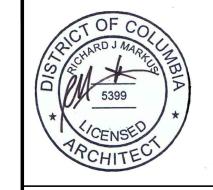


AS SHOWN

09-13-2022

A200
DRAWING NUMBER




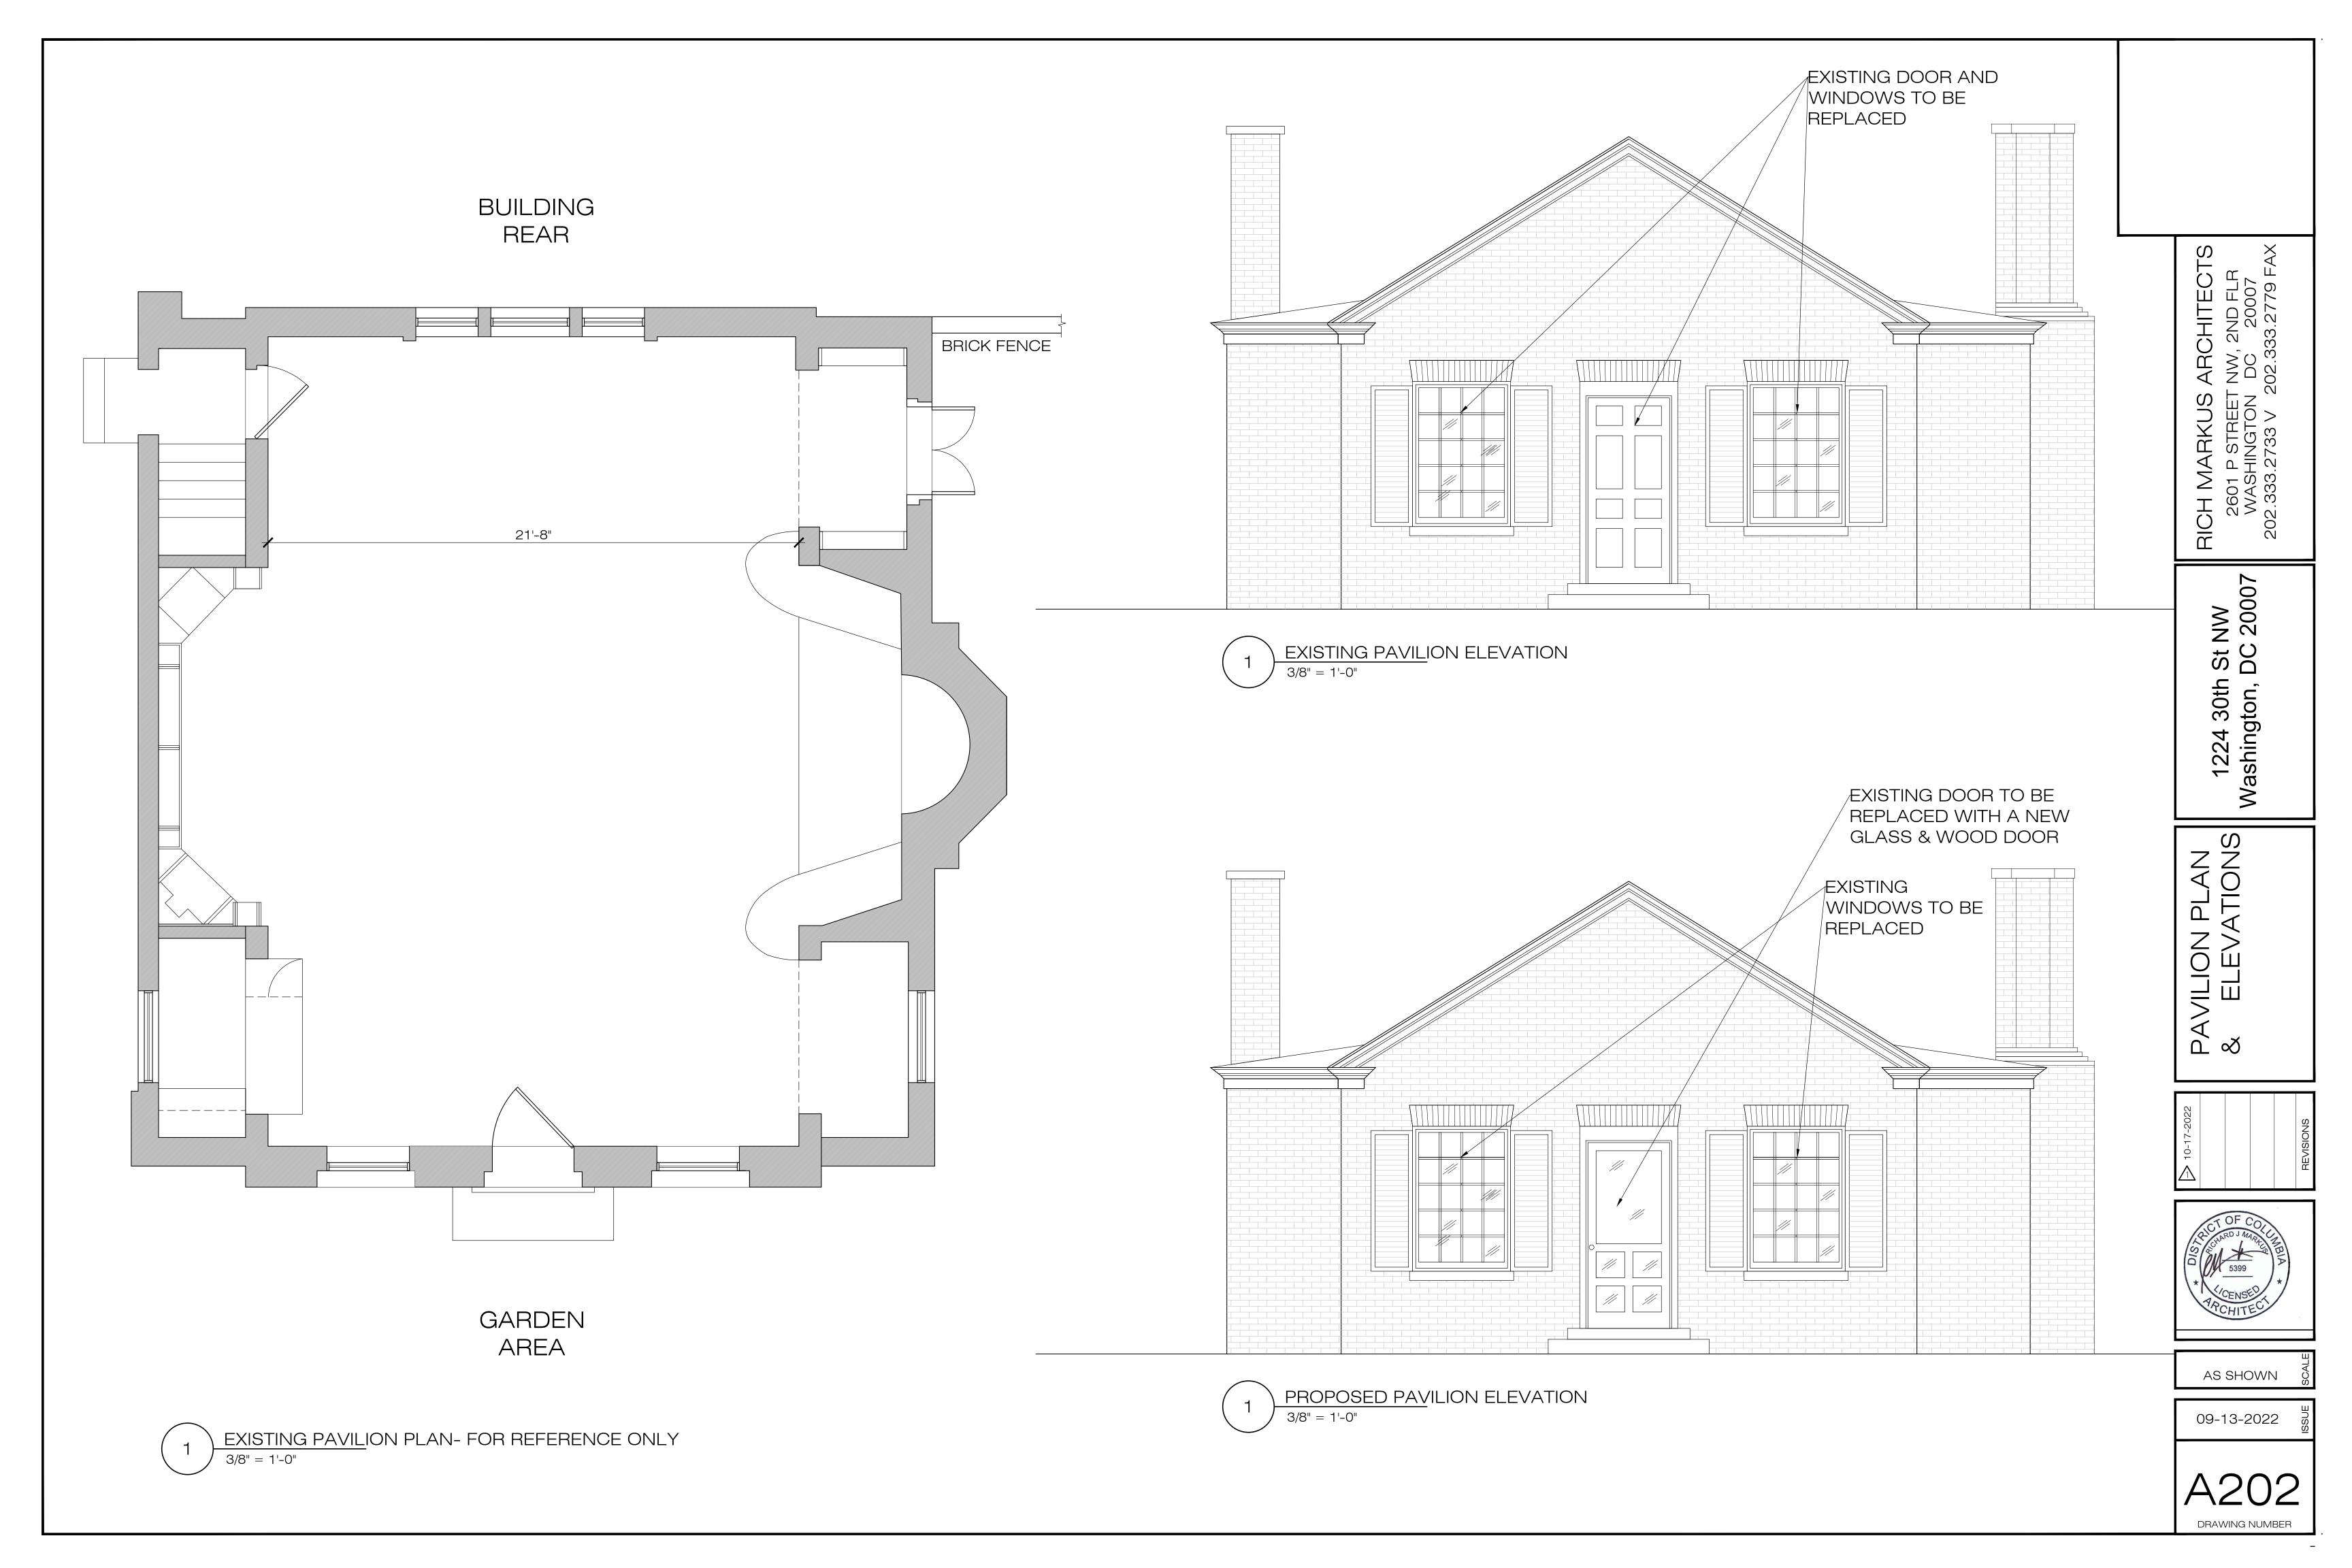


RICH MARKUS ARCHITECTS
2601 P STREET NW, 2ND FLR
WASHINGTON DC 20007

1224 30th St NW Washington, DC 20007

PAVILION REAR ELEVATION

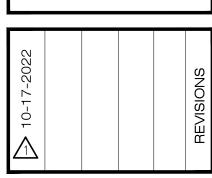

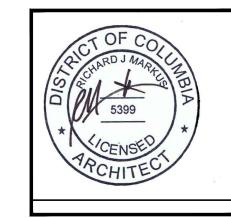



AS SHOWN

09-13-2022

A203

DRAWING NUMBER

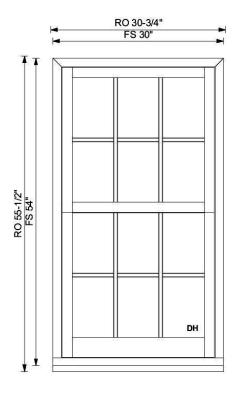

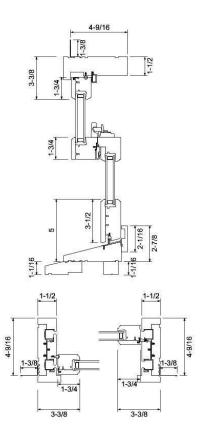

Attribute	Value
Product	25 DOUBLE/SINGLE HUNG
Exterior Frame Finish	Primed
Location	PREMIER MASTER SHOWER
Glazing Options Top	Heat Smart Double 272
Glass Thickness Top	3 MM Glass Thickness
Glass Tint Top	Clear Glass
Glazing Options Bottom	Heat Smart Double 272
Glass Tint Bottom	Clear Glass
Tempered Glass Top	Tempered Not Required Top
Tempered Glass Bottom	Tempered Not Required Bottom
Grille Style	Colonial Grille
Grille Pattern	3W2H Pattern
Exterior Grille Type	Putty Exterior Profile
Interior Grille Type	Putty Interior Profile
Vertical Grille Bar Size	5/8" (16mm)
Horizontal Grille Bar Size	5/8" (16mm)
Exterior Casing	No Exterior Casings Required
Sill Nose Type	Standard Subsill
Jamb Size of Unit	4 9/16" (116mm)
Wood Species	Douglas Fir

91.5 100 0

Page 1 of 1 Location : PREMIER MASTER SHOWER Exterior View

Quote:

QT118558

Item:

1

ID:

. N

Quantity:

1

Approved by:

Note: Structural support may be required around and between mulled units. The size and type to be determined by a structural engineer.

Project: WINDOW PACKET FOR 1224 30TH ST

Company: Loewen Windows of Bethesda


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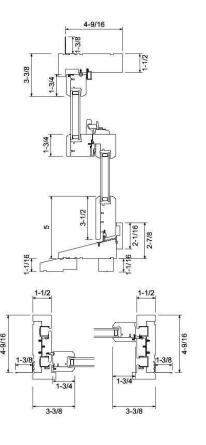
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Current Page:

1 of 17





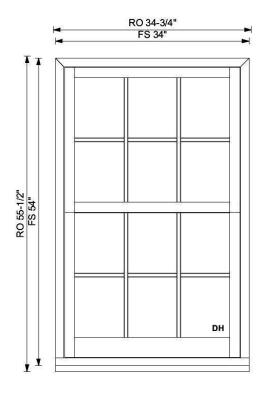

Attribute	Value
Product	25 DOUBLE/SINGLE HUNG
Exterior Frame Finish	Primed
Location	3RD FL BEDROOM 4
Glazing Options Top	Heat Smart Double 272
Glass Thickness Top	3 MM Glass Thickness
Glass Tint Top	Clear Glass
Glazing Options Bottom	Heat Smart Double 272
Glass Tint Bottom	Clear Glass
Tempered Glass Top	Tempered Not Required Top
Tempered Glass Bottom	Tempered Not Required Bottom
Grille Style	Colonial Grille
Grille Pattern	3W2H Pattern
Exterior Grille Type	Putty Exterior Profile
Interior Grille Type	Putty Interior Profile
Vertical Grille Bar Size	5/8" (16mm)
Horizontal Grille Bar Size	5/8" (16mm)
Exterior Casing	No Exterior Casings Required
Sill Nose Type	Standard Subsill
Jamb Size of Unit	4 9/16" (116mm)
Wood Species	Douglas Fir

91.5

Page 1 of 1 Location : 3RD FL BEDROOM 4 Exterior View

Quote:

QT118558

Item:

2

ID:

N

Quantity:

1

Approved by:

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Project: WINDOW PACKET FOR 1224 30TH ST

Company: Loewen Windows of Bethesda


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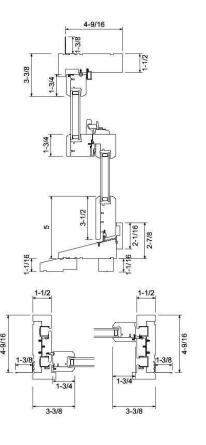
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Current Page:

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Attribute	Value
Product	25 DOUBLE/SINGLE HUNG
Exterior Frame Finish	Primed
Location	3RD FL BEDROOM 4
Glazing Options Top	Heat Smart Double 272
Glass Thickness Top	3 MM Glass Thickness
Glass Tint Top	Clear Glass
Glazing Options Bottom	Heat Smart Double 272
Glass Tint Bottom	Clear Glass
Tempered Glass Top	Tempered Not Required Top
Tempered Glass Bottom	Tempered Not Required Bottom
Grille Style	Colonial Grille
Grille Pattern	3W2H Pattern
Exterior Grille Type	Putty Exterior Profile
Interior Grille Type	Putty Interior Profile
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Exterior Casing	No Exterior Casings Required
Sill Nose Type	Standard Subsill
Jamb Size of Unit	4 9/16" (116mm)
Wood Species	Douglas Fir

Page 1 of 1 Location: 3RD FL BEDROOM 4 Exterior View

Quote:

QT118558

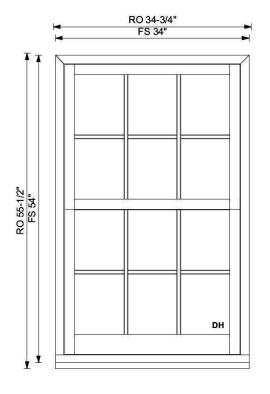Item:

3

ID:

. N

Quantity:

Approved by:

Note: Structural support may be required around and between mulled units. The size and type to be determined by a structural engineer.

Project: WINDOW PACKET FOR 1224 30TH ST

Company: Loewen Windows of Bethesda


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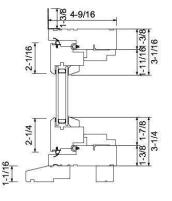
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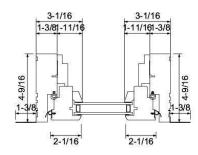
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Attribute	Value
Product	28 AWNING AND CASEMENT
Exterior Frame Finish	Primed
Style of Unit	Casement Style
Operator Type	Traditional Operation
Location	3RD FL ELEVATOR LOBBY
Glazing Options	Heat Smart Double 272
Glass Thickness	3 MM Glass Thickness
Glass Tint	Clear Glass
Tempered Glass	Tempered Not Required
Glazing Stop Type	Interior Putty Glazing Stops
Grille Style	Colonial Grille
Grille Pattern	3W4H Pattern
Exterior Grille Type	Putty Exterior Profile
Interior Grille Type	Putty Interior Profile
Vertical Grille Bar Size	5/8" (16mm)
Horizontal Grille Bar Size	5/8" (16mm)
Exterior Casing	No Exterior Casings Required
Sill Nose Type	Standard Subsill
Jamb Size of Unit	4 9/16" (116mm)
Wood Species	Douglas Fir

Page 1 of 1 Location : 3RD FL ELEVATOR LOBBY Exterior View

Quote:

QT118558

Item:

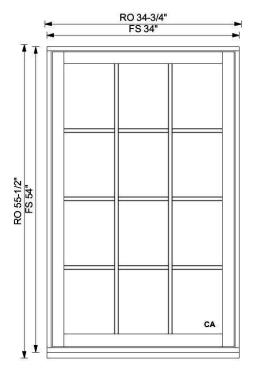4

ID:

N

Quantity:

1

Approved by:

Note: Structural support may be required around and between mulled units. The size and type to be determined by a structural engineer.

Project: WINDOW PACKET FOR 1224 30TH ST

Company: Loewen Windows of Bethesda

Date:

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Current Page:

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